

**From:** Ben Stevens, CFO

stevensb@winmedical.org

**Date:** 3/15/2024

**Project Name:** WinnMed Expansion & Renovation

**RFP Due Date:** 4/10/2024 12:00 PM

**Questions & RFP**

**Responses Sent To:** Ben Stevens, stevensb@winmedical.org

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WinnMed is seeking bids for the Expansion & Renovation project which entails equipment for OB, Surgery, and Clinical departments. Attached are the specifications and plans pertaining to this request.

Interested vendors should complete the information on the respective bid form. There are three bid packages included in this project. Bid Package A and Bid Package B will each have one awardee while Bid Package C may have multiple awardees. All freight, delivery and installation of products need to be included in each separate bid package while also be shown on the bid form. Note that the owner will provide contractors to hook up items requiring licensed individuals (i.e. electrical, plumbing, HVAC). The Owner reserves the right to add or delete items based upon unit pricing. This request for proposal is for final pricing. Unit prices shall cover any price increases anticipated at time of purchase and shall be held for 45 days from bid due date.

Bid Submittal to include:

- Equipment Specifications
- Bid Forms A, B, C
- Freight, Delivery, and Installation charges
- History and Description of Dealer's Firm
- References
- Certificate of Insurance will be requested once awards are provided

**Schedule of the project is as follows:**

- Bids reviewed on April 10, 2024 by owner. Recommendation to the Board of trustee will occur at the next board meeting which are scheduled the first Wednesday of each month. Purchase orders will be processed within one week of the Board of Trustee approval.
- Anticipated Furniture Delivery/Installation Date(s):
  - Bid Package A: Quarter 4 2025
  - Bid Package B: Quarter 4 2025

## **Furniture Quotations and General Information Form**

*Page 2 of 2*

- Bid Package C: multiple dates to be coordinated upon issuance of Purchase Order
- Questions regarding building access or pre-installation walk-throughs and installation updates shall be addressed to Graham Construction (Construction Manager) or Ben Stevens from WinnMed.

Equipment shall be delivered and installed to the job site. Equipment vendor(s) are responsible for the proper placement (based on equipment plans and specifications) and removal and disposal of all cartons, packaging, and debris from the job site(s).

Any equipment delivered damaged, defective, dirty, or scratched will be the responsibility of the vendor for repair or replacement as soon as possible. Notification regarding damage, defects, etc. will be addressed on a punch list immediately following the installation.



**Bid Form  
Package A**

Date:	3/22/2024								
District:	Winneshek Medical Center								
	901 Montgomery Street								
Contact Name:	Ben Stevens-Chief Financial Officer								
Contact Number:	(563) 387-3109								

Bid Item #	Specified Vendor	Item Description	Specified Model #	Per Spec /Substitute	Bidding Vendor	Model #	Description	Quantity	Unit Price	Total Price
1.A	Steris	Cart Washer/Utensil Washer & Disinfecter; Exterior Panels	FW12102					1		
2.A	Steris	Triple Bay Reprocessing Sink; 120"; Height Adjustable; Chemistry Mount, Flex Plate; External Drain Lever Handles	SINK50120					1		
3.A	Steris	InnoWave ProSonic Irrigator; 60 Lumens	IWPRO60					1		
4.A	Steris	Rack Washer/Disinfecter; Three level manifold rack (Total Qty 4), auto docking transfer card adapter (Total Qty 4)	FH19042					2		
5.A	Steris	Auto Docking Transfer Cart	FD179					4		
6.A	Steris	Work Table; 36" x 72"; Height Adjustable	CG5					2		
7.A	Steris	Drying Cabinet, Pass Through, Trim Kit	DCR101101XL					1		
8.A	Steris	Prep & Pack Table, Deluxe Accessory Package, Height Adjustable; Task Drawer, Magnification Light	PREP63					1		
9.A	Steris	V-Pro Max 2 Sterilizer; Electric; VAPROX HC Sterilant; Thermal Paper Roll; 5 Test Packs	VP500002101					1		
10.A	Steris	600 Prevac Steam Sterilizer; Single Door, 480V; Drain Kit, Chamber Rail	EF1301242					2		
11.A	Steris	Transfer Carriage, Fixed Height; Loading Car w/ 2 Shelves	AY1598104 AY1596604					4		
12.A	Steris	Case Cart; 28.6x47,3x39; Stainless Steel; 2 Wire Adjustments per Cart	ACC243739					6		
13.A	Steris	Cart Washer Universal Rack	FD372					1		
14.A	Steris	System Rail - 38"	T635Q0					2		
18.A	Steris	400 16x16x26 Prevacuum Single Sliding Sterilizer; Electric	SR0101110311					1		
19.A	Steris	Triple Bay Reprocessing Sink; 97.5"; Height Adjustable; Chemistry Mount, Flex Plate	SINK5097					1		
20.A	Steris	Pass-Thru Automated Endoscope Reprocessor	ADVPT3008					2		
21.A	Steris	Endoscope Drying and Storage System	DRY1001					4		
22.A		Bid Package A Delivery & Installation						1		

**TOTAL**

COMPANY:

PHONE:

NAME:

SIGNATURE:

ADDRESS:

FAX:

TITLE:

DATE:

ADDITIONAL INFORMATION:

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**Bid Form  
Package B**

Date:	3/22/2024		
District:	Winneshek Medical Center		
	901 Montgomery Street		
Contact Name:	Ben Stevens-Chief Financial Officer		
Contact Number:	(563) 387-3109		

Bid Item #	Specified Vendor	Item Description	Specified Model #	Per Spec /Substitute	Bidding Vendor	Model #	Description	Quantity	Unit Price	Total Price
24.B	Stryker	Ceiling Mounted Surgical Light; Endoscopic Room; Wall Control Display; Sterile Control & Light Handle; Sterile Control Prep; 2 Arm; Qty 1 Monitor	RD 2207					2		
25.B	Stryker	Ceiling Mounted Equipment Management System; 3 Row, 4 Shelves; Foot Pedal Storage Drawer	SPS-3-C					2		
26.B	Stryker	Ceiling Mounted Anesthesia Boom; 2 Row, 2 Arm, 1 Air, 2 Vac, 1 N2O Gas, 2 O2, 1 WAGD Gas	SFS-2					2		
27.B	Stryker	Endoscopic Room Ancillary Parts; DVI Monitor Ports (Total 6); Cable Assembly; Fiber Optic; DVI Plate; BNC Plate and Cable						2		
28.B	Stryker	OR 1 Surgical Light w/ Monitor; 2 Arm; Handle Integrated Camera; Wall Control Display; Sterile Control Prep & Light Handle	FD 2203					1		
29.B	Stryker	OR 1 Surgical Light w/ Monitor; 2 Arm; Sterile Control Prep & Light Handle	FD 2203					1		
30.B	Stryker	OR 1 Ceiling Mounted Anesthesia Boom; 2 Row, 2 Arm, 1 Air, 2 Vac, 1 N2O Gas, 2 O2, 1 WAGD Gas	SFS-2					1		
31.B	Stryker	OR 1 Ceiling Mounted Equipment Management System; 3 Row, 4 Shelves; Foot Pedal Storage Drawer	SPS-3-C					1		
32.B	Stryker	OR 3 Ceiling Mounted Equipment Management System; 3 Row, 4 Shelves; Foot Pedal Storage Drawer	SPS-3-C					1		
33.B	Stryker	OR 4 Ceiling Mounted Equipment Management System; 3 Row, 4 Shelves; Foot Pedal Storage Drawer	SPS-3-C					1		
34.B	Stryker	OR 1 Ceiling Mounted Nurse Station; 1 Shelf	SPS-2					1		
35.B	Stryker	OR 3 Ceiling Mounted Nurse Station; 1 Shelf	SPS-2					1		
36.B	Stryker	OR 4 Ceiling Mounted Nurse Station; 1 Shelf	SPS-2					1		
37.B	Stryker	Integration System; Video Routing Platform	1678100004					3		
38.B	Stryker	Hospital Status System	1678055001					1		
39.B	Stryker	OR 3 Surgical Light w/ Monitor; 2 Arm; Camera Ready; Sterile Control Prep & Light Handle	FD 2203					1		
40.B	Stryker	OR 4 Surgical Light w/ Monitor; 2 Arm; Camera Ready; Sterile Control Prep & Light Handle	FD 2203					1		
41.B	Stryker	OR 3 Surgical Light w/ Monitor; 2 Arm; Sterile Control Prep & Light Handle	FD 2203					1		
42.B	Stryker	OR 4 Surgical Light w/ Monitor; 2 Arm; Sterile Control Prep & Light Handle	FD 2203					1		
43.B	Stryker	OR 3 Ceiling Mounted Anesthesia Boom; 2 Row, 2 Arm, 1 Air, 2 Vac, 1 N2O Gas, 2 O2, 1 WAGD Gas	SFS-2					1		
44.B	Stryker	OR 4 Ceiling Mounted Anesthesia Boom; 2 Row, 2 Arm, 1 Air, 2 Vac, 1 N2O Gas, 2 O2, 1 WAGD Gas	SFS-2					1		

45.B	Stryker	Endoscopic/Surgical Room Hub Base System	240200100					5		
46.B	Stryker	32" OLED Surgical Display	240031300					10		
47.B	Stryker	32" Surgical Display Cover	240031051					10		
48.B	Stryker	DVI to HDMI Converter	240099265					2		
49.B	Stryker	S-Video/Composite to HDMI Converter	240099250					2		
50.B	Stryker	Endoscopic/Surgical Room Hub Device Control Package	240200103					5		
51.B	Stryker	Endoscopic/Surgical Room Hub Dicom Package	240200106					5		
52.B		Bid Package B Delivery & Installation						1		

**TOTAL**

COMPANY:

ADDRESS:

PHONE:

FAX:

NAME:

TITLE:

SIGNATURE:

DATE:

ADDITIONAL INFORMATION:



**Bid Form  
Package C**

Date:	3/22/2024								
District:	Winneshek Medical Center								
	901 Montgomery Street								
Contact Name:	Ben Stevens-Chief Financial Officer								
Contact Number:	(563) 387-3109								

Bid Item #	Specified Vendor	Item Description	Specified Model #	Per Spec /Substitute	Bidding Vendor	Model #	Description	Quantity	Unit Price	Total Price
15.C	SHIMADZU	Digital Radiography System; 65kW Generator; Touch Screen Console; Elevating Table; Ceiling Rail System; Auto Wall Bucky; Workstation w/ 24" Monitor	RSP-A65-702C					1		
16.C	Stryker	LED Exam Light; Ceiling Mount	CE-3863075					8		
55.C	RF Technologies	Infant Security Systems; Server Enterprise software; Staff Alert Panel; (3) Double Door Systems; (12) Alarming Band Receivers w/ Antennas						1		
58.C	Midmark	Clinic Exam Chairs; Drawer Heater; Wired Controls; 650 lbs. weight capacity	MIM626005					39		
59.C	Midmark	Clinic Exam Chair Support Rails	MIM9A600002					39		
60.C	Midmark	Clinic Exam Chair Premium Upholstered Top Upgrade	MIM0022000814					41		
61.C	Midmark	Clinic Procedure Chair; Foot & Hand Pedal; Swing Away Instrument Tray; LED Exam Light; Vision Block Screen; Articulating Knee Crutches	MIM230001					2		
64.C	Unicas Medical	Stainless Steel Pass-Through Cabinets, 55" W x 60" H x 22.75" D; Sliding Door Surgery Room Side; Door Handle Sterile Hall Side	Type E Pass-Through					3		
66.C	Steris	Pass-Thru Blanket/Fluid Warmer	???					3		
67.C	Steris	Surgery Scrub Sink; 2- Station; 64" w x 27 1/2" D x 51 1/2" H; Infrared Faucet System	071655-000					3		
70.C	ARJO	Ceiling Mounted Patient Lift; 600 lbs. capacity	Max Sky 2					1		
73.C	AMSCO	OB Headwall; Backlit Accent Panel; built in electrical/data/medical gas connections; bed bumpers	NuLook Manifold System					6		
74.C		Delivery & Installation Included in Each Line Item								

**TOTAL**

COMPANY:	_____	ADDRESS:	_____
PHONE:	_____	FAX:	_____
NAME:	_____	TITLE:	_____
SIGNATURE:	_____	DATE:	_____

ADDITIONAL INFORMATION: \_\_\_\_\_

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# WinnMed

WinnMed  
Expansion and Renovation  
Decorah, IA 52101  
Furniture Specifications

Issue Date:

3/6/2024

**CONTACT:** Ben Stevens - CFO  
**PHONE NUMBER:** 563-387-3109

ITEM NUMBER:	1
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ITEM NAME:	Cart Washer/Utensil Washer & Disinfector
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ROOM NUMBER:		QUANTITY:	
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SPECIFICATION INFORMATION	
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MANUFACTURER:	Steris
MODEL #:	FW12102
DIMENSIONS:	70" W x 71.5" D x 94.25" H
DESCRIPTION:	Cart and Utensil Washer/Disinfector; 460-480 V, 60 Hz, Steam Heated; Touch-Screen controls; Full-Glass Doors; 3 chemistry pumps; service side exterior panels and non-service exterior panels included

FURNITURE & EQUIPMENT IMAGE
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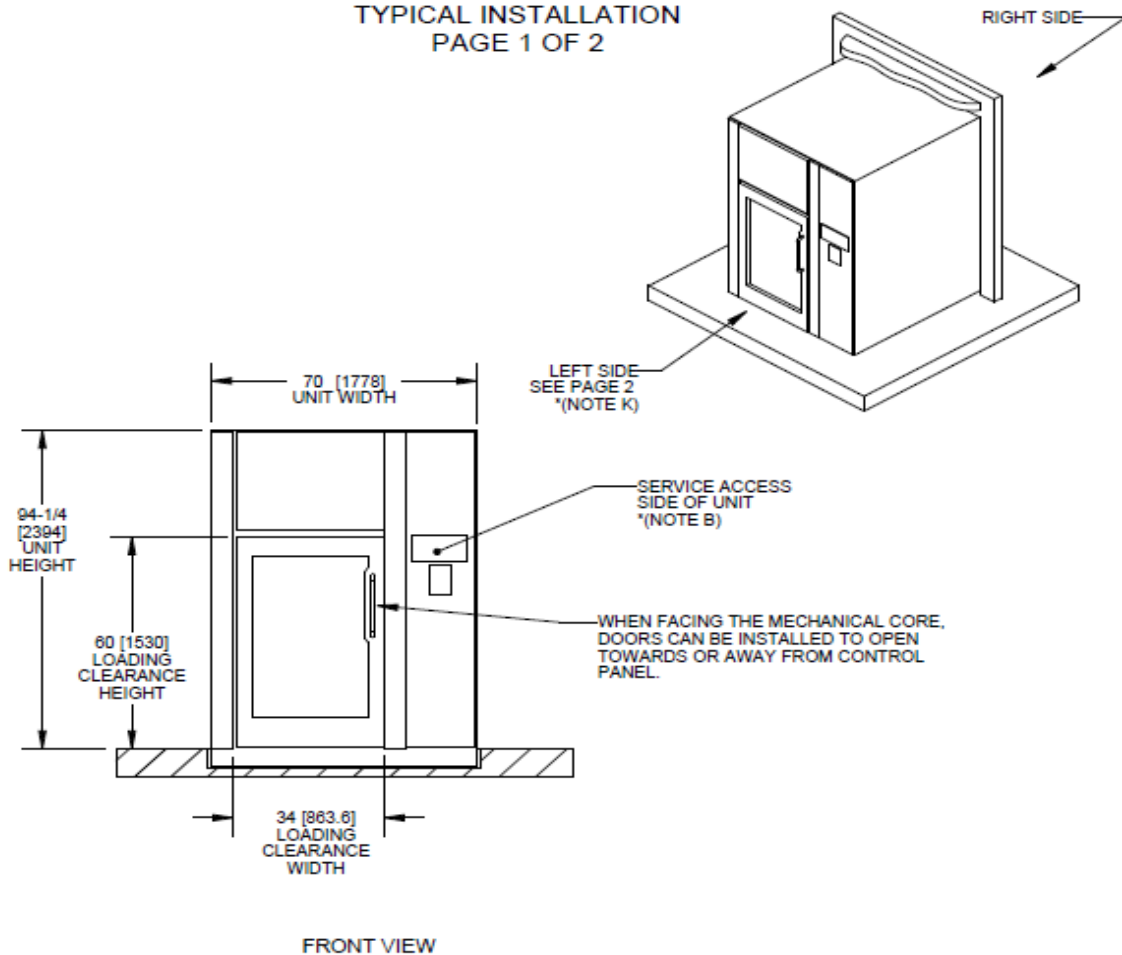
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## TYPICAL INSTALLATION PAGE 1 OF 2



### \*NOTES:

- (A) UNLESS OTHERWISE SPECIFIED, ALL DIMENSIONS ARE IN INCHES [mm].
- (B) SERVICE ACCESS SIDE OF UNIT IS RECOGNIZED BY THE TOUCH SCREEN AT THE RIGHT OF WASH CHAMBER. ELECTRICAL AND CONTROL COMPONENTS, AS WELL AS MOST OF SERVICABLE PARTS ARE ACCESSIBLE FROM THAT SIDE OF UNIT. NON-SERVICE SIDE IS EQUIPPED WITH THE TOUCH SCREEN ON THE LEFT OF THE WASH CHAMBER.
- (C) CUSTOMER MUST BE SURE THAT MACHINE STANDS ON A NON-COMBUSTIBLE FLOOR.
- (D) WEIGHTED EQUIVALENT SURFACE SOUND PRESSURE LEVEL: 65.0 dB(A) CALCULATED AS DESCRIBED IN ISO 3746.




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EQUIPMENT DRAWING OF  
AMSCO® 1215 CART WASHER

STEAM HEATED, W/O ACU-RINSE RES., PIT MOUNTED UNIT

SIZE:  
A

SCALE:  
N/A

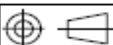

DRAWN BY:  
Michel Blouin

DRAWING NUMBER:  
12225978

PART NUMBER  
& REVISION

Page 1 of 12


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## TYPICAL INSTALLATION PAGE 2 OF 2



### \*NOTES:

- (E) VERTICAL BARRIER WALL FLANGES ARE PROVIDED WITH UNIT TO FILL GAP BETWEEN UNIT AND WALL ON BOTH SIDES. DIMENSIONS ARE 5 in [127 mm] WIDTH X 101 1/2 in [2578 mm] LONG.
- (F) HORIZONTAL BARRIER WALL FLANGES ARE PROVIDED WITH UNIT TO FILL GAP BETWEEN UNIT AND WALL. DIMENSIONS ARE 80 in [2032 mm] WIDTH X 5 in [127 mm] HEIGHT.
- (G) MINIMUM REQUIRED DIMENSION. THE STANDARD BARRIER WALL FLANGES CAN'T BE USED AT THAT DIMENSION.
- (H) RECOMMENDED DIMENSION. THE STANDARD BARRIER WALL FLANGES CAN BE USED AT THAT DIMENSION.
- (I) IF NO BUILDING SIDE WALL IS PRESENT ON NON-SERVICE SIDE, NON-SERVICE SIDE EXTERIOR PANELS ACCESSORY IS RECOMMENDED (FD37-7).
- (J) IF NO BUILDING SIDE WALL IS PRESENT ON SERVICE SIDE, SERVICE SIDE EXTERIOR PANELS ACCESSORY IS RECOMMENDED (FD37-8).
- (K) STERIS RECOMMENDS TO INSTALL UNIT WITH LEFT SIDE TO BE LOCATED ON SOILED SIDE (LOAD SIDE) OF SPD.
- (L) PROCESS FLOW SIDE (LOADING DOOR) CAN BE EITHER CONFIGURED ON LEFT SIDE OR RIGHT SIDE. EXCEPT FOR SINGLE DOOR CONFIGURATION WHERE LOAD/UNLOAD DOOR IS ALWAYS THE LEFT DOOR (SEE NOTE M).
- (M) SINGLE DOOR CONFIGURATION KIT AVAILABLE (FD38-8).

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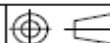
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EQUIPMENT DRAWING OF  
AMSCO® 1215 CART WASHER

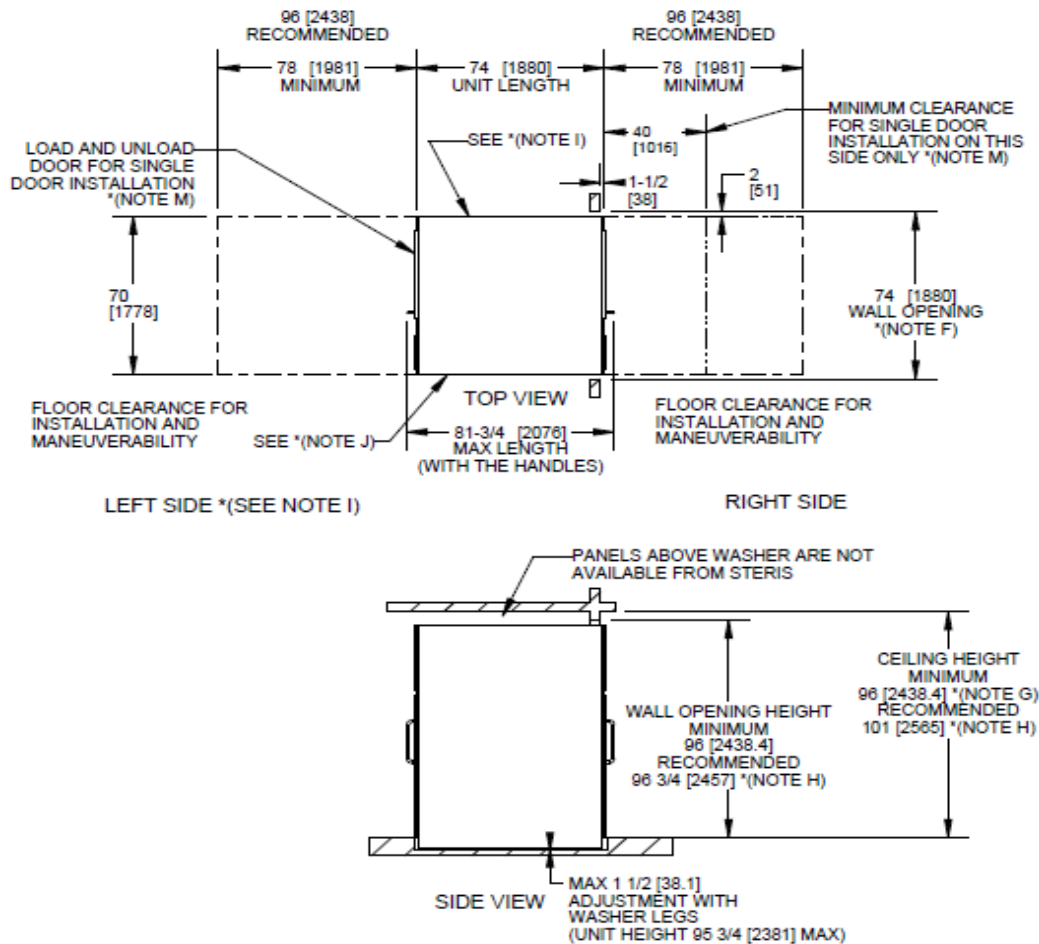STEAM HEATED, W/O ACU-RINSE RES., PIT MOUNTED UNIT

SIZE:  
A

SCALE:  
N/A



DRAWN BY:  
Michel Blouin

DRAWING NUMBER:  
12225978

PART NUMBER  
& REVISION

Page 2 of 12

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[illegible]

(A) CONCRETE FLOOR MUST REMAIN FREE OF DEFECTS IN THESE AREA, AS PER ESR-1917 & ESR-3187.  
(B) FOR INSTALLATION OF SEISMIC ANCHORS (NOT PROVIDED BY STERIS) SEE SEISMIC REPORTS 11441618 AND 11053371.  
(C) THE FLOOR SINK AND DRAIN SHALL NOT OCCUPY THESE AREAS.  
(D) WITH SEISMIC 6 in x 6 in [152 mm x 152 mm] FLOOR SINK WITH 04 in [102 mm] DRAIN IS REQUIRED WHEN USING SEISMIC MOUNTS.  
(E) WITHOUT SEISMIC REFER TO PAGE 9 FOR FLOOR SINK SPECIFICATION.  
(F) WITH SEISMIC MOUNTS 57 [1448] MIN, 61 3/4 [1568] MAX WITHOUT SEISMIC MOUNTS 57 [1448] MIN, 64 [1626] MAX



## STEAM HEATED, W/O ACU-RINSE RES., PIT MOUNTED UNIT

PART NUMBER  
& REVISION

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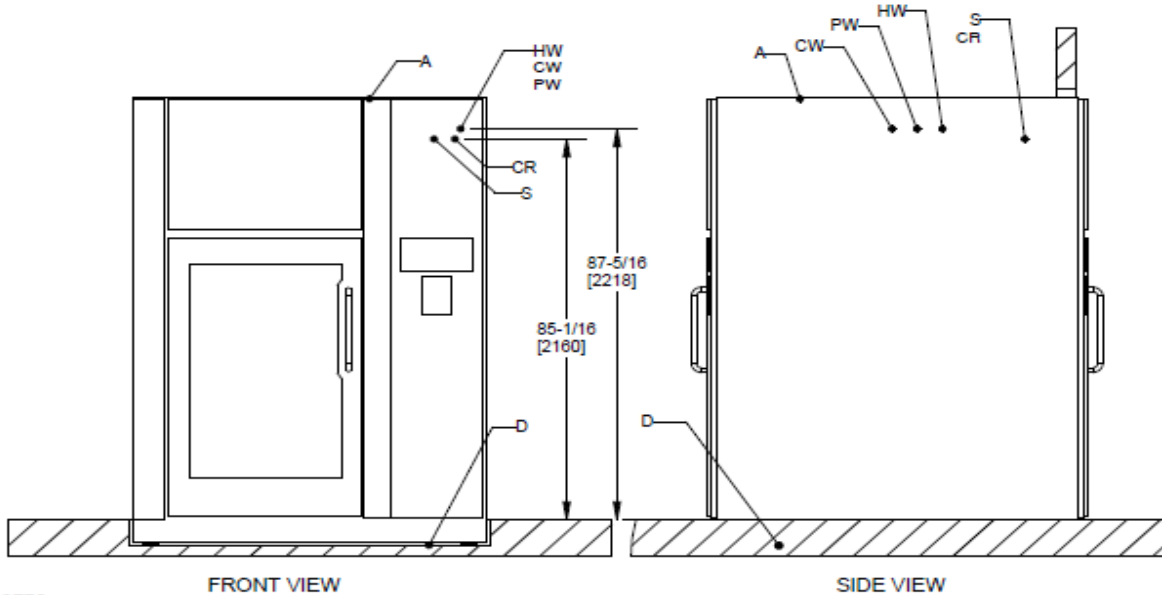
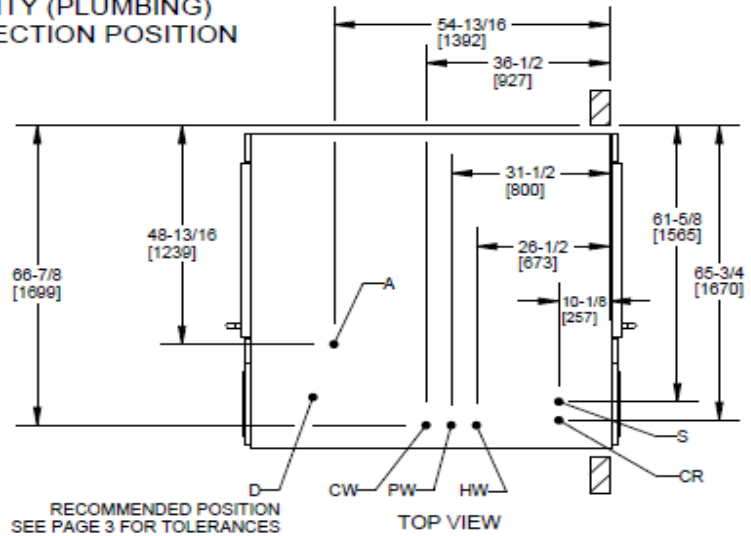


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## UTILITY (PLUMBING) CONNECTION POSITION

HW	HOT WATER
CW	COLD WATER
PW	PURE WATER
A	COMPRESSED AIR
D	FLOOR DRAIN LOCATION
S	STEAM
CR	CONDENSATE RETURN



### \*NOTES:

- (A) ALL OVER PRESSURE DEVICES TO CONTROL PRESSURE OF STEAM, WATER AND AIR ARE NOT INCLUDED. IT IS RESPONSIBILITY OF CUSTOMER TO INSTALL THOSE EQUIPMENT ON MAIN UTILITIES.  
(B) ALL CONNECTIONS SHOULD BE IN ACCORDANCE WITH LOCAL CODES.



TITLE	EQUIPMENT DRAWING OF AMSCO® 1215 CART WASHER				
	STEAM HEATED, W/O ACU-RINSE RES., PIT MOUNTED UNIT				
SIZE: A	SCALE: N/A	DRAWN BY: Michel Blouin	DRAWING NUMBER: 12225978	PART NUMBER & REVISION	

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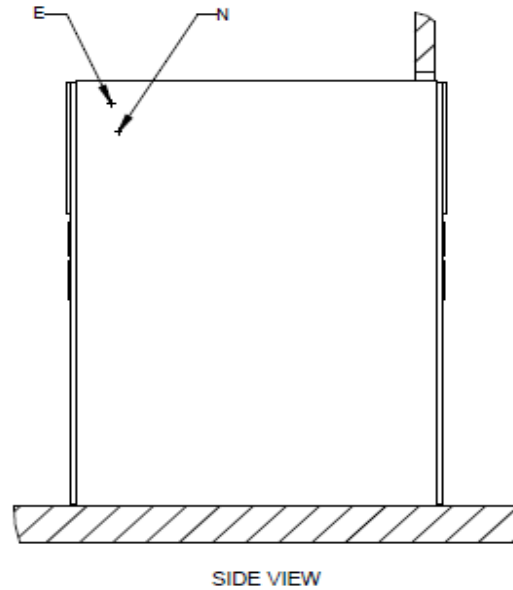
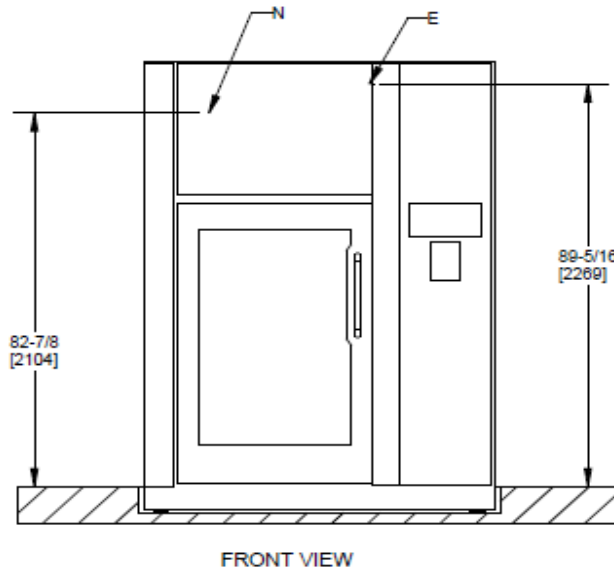
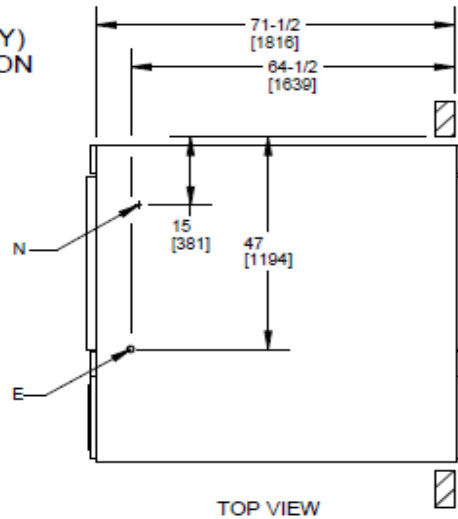
# WinnMed

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## UTILITY (ELECTRICITY) CONNECTION POSITION

E	ELECTRICAL
N	NETWORK

RELAY - FUNCTION (SEE NOTE B)	
CR-11	READY TO LOAD CUSTOMER DRY CONTACT
CR-12	READY TO UNLOAD CUSTOMER DRY CONTACT
CR-20	COLD WATER REQUEST CUSTOMER DRY CONTACT
CR-21	HOT WATER REQUEST CUSTOMER DRY CONTACT
CR-22	VENTILATION REQUEST CUSTOMER DRY CONTACT
CR-23	PURE WATER REQUEST CUSTOMER DRY CONTACT



**STERIS**  
Corporation


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EQUIPMENT DRAWING OF  
AMSCO® 1215 CART WASHER

STEAM HEATED, W/O ACU-RINSE RES., PIT MOUNTED UNIT

SIZE:  
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SCALE:  
N/A



DRAWN BY:  
Michel Blouin

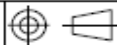DRAWING NUMBER:  
12225978

PART NUMBER  
& REVISION

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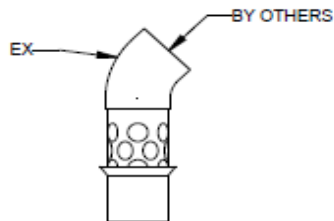
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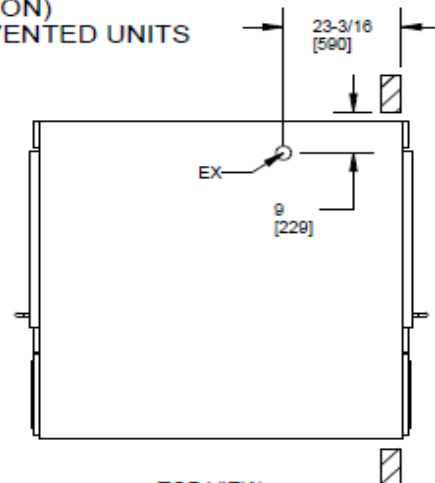
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## UTILITY (VENTILATION) NOT APPLICABLE FOR NON-VENTED UNITS

EX VENTILATION EXHAUST




VENTILATION CONNECTION (OPTIONAL)  
(SEE PAGE 11 \*(NOTE 1))




TOP VIEW

VAPOR CONDENSATE  
COLLECTING POINT  
DRAIN 3/4 in [20 mm] O.D.  
(ROUTED TO WASHER DRAIN)  
DRY CONTACT (SEE PAGE 11 \*(NOTE 3))

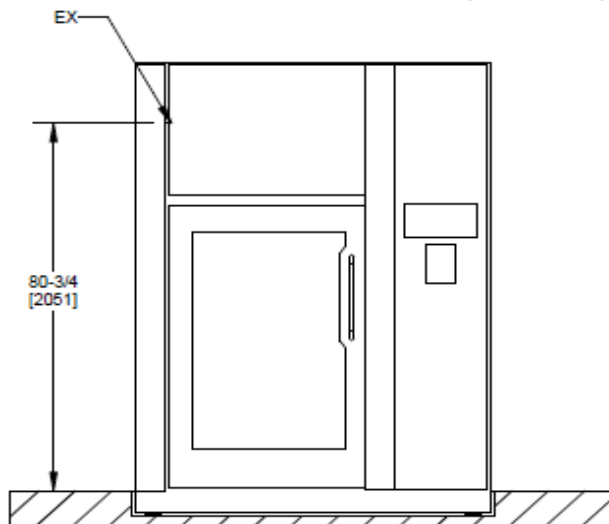

FRONT VIEW

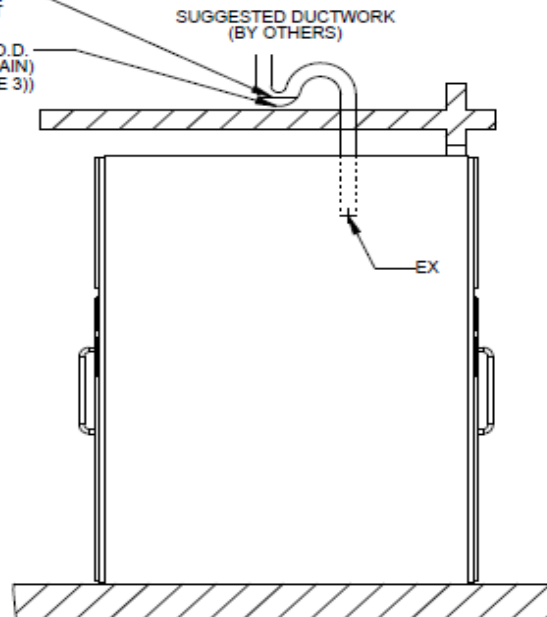

SIDE VIEW

**STERIS**  
  
Corporation


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EQUIPMENT DRAWING OF  
AMSCO® 1215 CART WASHER

STEAM HEATED, W/O ACU-RINSE RES., PIT MOUNTED UNIT

SIZE:  
A

SCALE:  
N/A

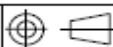

DRAWN BY:  
Michel Blouin

DRAWING NUMBER:  
12225978

PART NUMBER  
& REVISION

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## DOSING STATION

CHEMICAL LINES SHALL NOT BE IN CONTACT WITH HOT SURFACES.

STERIS RECOMMENDS CUSTOMER TO ROUTE CHEMICAL LINES AND SIGNAL CABLE THROUGH A 3 in [76 mm] ID CONDUIT.

EXCESS LENGTH MUST BE CUT BEFORE CONNECTING TO WASHER/STATION TO AVOID FORMING BUNDLES THAT COULD AFFECT THE CHEMICAL INJECTION SYSTEM'S PERFORMANCE.  
(DO NOT CUT SIGNAL CABLE).

—100 ft [30 m] OF INJECTION LINE AND SIGNAL CABLE  
UP TO 150 ft [45 m] WITH CHEMICAL DOSING SYSTEM  
EXTENSION 50' ACCESSORY (FD38-5)

UP TO 4 TUBES

ROUTE CHEMICAL LINES AND  
SIGNAL CABLE TO TOP OF UNIT

CEILING

DOSING STATION  
WEIGHT : 15 lb [6.8 kg]

13-5/8 [346]

12 ft [3.6 m] OF INJECTION LINE  
(FROM CONTAINERS TO  
DOSING STATION)  
\*(NOTE B)

132 [3350]  
MAX.

60 [1524]  
REFCHEMICAL CONTAINERS-  
\*(NOTE A)

FD37-0 ACCESSORY SHOWN  
(ADDITIONAL CHEMICAL PUMP)

\*NOTES:

(A) DOSING STATION AND CHEMICAL CONTAINERS MUST BE ON THE SAME FLOOR OF THE BUILDING AS THE WASHER/DISINFECTOR. CHEMICAL CONTAINER MUST BE LOCATED AT A LOWER HEIGHT THAN THE DOSING STATION.

(B) HP PICKUP TUBE SYSTEM CAN PROVIDE UP TO TWO WASHERS WITH CHEMISTRY FROM THE SAME CONTAINER

		CART CYCLE (With PUC/PUC HP)	DECONTAM CYCLE (With Liquid Descaler / Polystica ® Restore)
CHEMICAL (CH)	NEUTRAL OR ALKALINE DETERGENT CONSUMPTION PER CYCLE	1.8 oz [55 ml]	N/A
	RINSE AID CONSUMPTION PER CYCLE	0.36 oz [10.9 ml]	N/A
	DESCALER CONSUMPTION PER CYCLE	N/A	36 oz [1090 ml]

# STERIS




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EEQUIPMENT DRAWING OF  
AMSCO® 1215 CART WASHER

STEAM HEATED, W/O ACU-RINSE RES., PIT MOUNTED UNIT

SIZE:  
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SCALE  
N/A



DRAWN BY:  
Michel Blouin

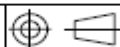DRAWING NUMBER:  
12225978

PART NUMBER  
& REVISION

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## UTILITY REQUIREMENTS CHART (PLUMBING)

UTILITY	PARAMETER	REQUIREMENT	✓	NOTES
HOT WATER (HW)	CONNECTION SIZE / TYPE	3/4 in / FEMALE NPT [3/4 in / MALE BSPT]  WITH FLEXIBLE HOSES ACCESSORY (FD36-7 OR FD36-8) 1 in / FEMALE NPT [1 in / MALE BSPT]		1. STERIS REQUIRES CUSTOMER TO INSTALL WATER HAMMER ARRESTOR, UNION & PRESSURE GAUGE.  2. CUSTOMER MUST PROVIDE UTILITY CONNECTIONS WITH SHUTOFFS DISCONNECTS WITHIN 2 FEET OF THE PERIMETER OF THE EQUIPMENT AND BELOW THE FINISHED CEILING. *STERIS OFFERS FLEXIBLE HOSES ACCESSORY (FD36-7 OR FD36-8) WITH INSTRUCTIONS. THIS ACCESSORY INCLUDES SHUTOFFS VALVES  3. OPTIMAL CLEANING EFFICIENCY WHEN HOT WATER IS AT A MAXIMUM OF 135 F [57.2 C].  4. SAMPLING VALVES INSTALLATION AS CLOSE AS POSSIBLE TO WASHER WATER CONNECTIONS IS RECOMMENDED.
	PRESSURE RANGE	15 - 50 psig DYNAMIC [103-345 kPa] 15 - 90 psig STATIC [103-620 kPa]		
	OPERATING FLOW RATE	17 US GPM [64.4 L/min] TO 34 US GPM [128.7 L/min]		
	TOTAL CONSUMPTION PER CART CYCLE	36.0 US GAL [136.3 L]  WITH ACU-WASH RESERVOIR: n/a		
	TEMPERATURE RANGE	110 °F [43 °C] TO 150 °F [65.5 °C] *(NOTE 3)		
	WATER QUALITY *(NOTE 5)	HARDNESS (CaCO <sub>3</sub> ) : 50-80 ppm (MAX. 120 ppm)		
COLD WATER (CW) *(NOTE 6)	CONNECTION SIZE / TYPE	1 in / FEMALE NPT [1 in / MALE BSPT]		5. STERIS RECOMMENDS THE FOLLOWING WATER QUALITY PARAMETERS: TOTAL DISSOLVED SOLIDS: 100-200 ppm (MAX. 500 ppm) TOTAL ALKALINITY (CaCO <sub>3</sub> ) : 70-120 ppm (MAX. 180 ppm) pH : 6.8-7 (MAX. 7.5) TOTAL SILICA : 0.1-0.5 ppm (MAX. 1 ppm)
	PRESSURE RANGE	30 - 50 psig DYNAMIC [206-345 kPa] 30 - 90 psig STATIC [206-620 kPa]		
	OPERATING FLOW RATE	VENTED CONFIGURATION: 17.5 US GPM [66.1 L/min] TO 22.6 US GPM [85.6 L/min] NON-VENTED CONFIGURATION: 28.4 US GPM [107.4 L/min] TO 36.6 US GPM [138.7 L/min]		
	TOTAL CONSUMPTION PER CART CYCLE	CONDENSATE RETURN COOL DOWN: 4.9 US GAL [18.5 L] NON-VENTED SYSTEM: 88.7 US GAL [335.7 L] DRAIN COOLDOWN: 38.6 US GAL [146.2 L] ACU-COOLDOWN: 20.2 US GAL [76.4 L]		
	TEMPERATURE RANGE	34 °F [1 °C] TO 70 °F [21 °C]		
	WATER QUALITY *(NOTE 5)	HARDNESS (CaCO <sub>3</sub> ) : 50-80 ppm (MAX. 120 ppm)		
PURE WATER (PW) *(NOTE 8)	CONNECTION SIZE / TYPE	3/4 in / FEMALE NPT [3/4 in / MALE BSPT]  WITH FLEXIBLE HOSES ACCESSORY (FD36-7 OR FD36-8) 1 in / FEMALE NPT [1 in / MALE BSPT]		6. BACK FLOW PREVENTER AGAINST BACK SIPHONAGE MAY BE REQUIRED (LOCAL PLUMBING CODE)  7. PW IS OPTIONAL. IF UNAVAILABLE, UNIT WILL PROCESS THERMAL RINSE USING HOT WATER SUPPLY.  8. IF PW IS PRESENT, ONLY CONTAINER AND UTENSIL CYCLE WILL USE PW BY DEFAULT. CART CYCLE WILL STILL USE HW.
	PRESSURE RANGE	5 - 50 psig DYNAMIC [34-345 kPa] 5 - 90 psig STATIC [34-620 kPa]		
	OPERATING FLOW RATE	11 US GPM [41.6 L/min] TO 34 US GPM [128.7 L/min]		
	TOTAL CONSUMPTION PER UTENSIL OR CONTAINER CYCLE *(NOTE 7 AND 8)	18.0 US GAL [68.1 L]		
	TEMPERATURE RANGE	70 °F [21.1 °C] TO 150 °F [65.5 °C]		
	RESISTIVITY (CONDUCTIVITY)	> 0.1 MΩ -cm (< 10 µS/cm)		
	pH	6.8 - 7.5		

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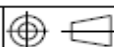
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## UTILITY REQUIREMENTS CHART (PLUMBING)

UTILITY	PARAMETER	REQUIREMENT	✓	NOTES
COMPRESSED AIR (A)	CONNECTION SIZE / TYPE	1/8 in / FEMALE NPT [1/8 in / MALE BSPT]		1. AIR PURITY PER ISO-8573-1: 2010 [7:4:4] MAX. PARTICLE DENSITY: 10 mg/m³ MAX. DEW POINT FOR WATER CONTENT: 37 °F [3 °C] MAX. OIL CONCENTRATION FOR THE OIL CONTENT: 5 mg/m³
	PRESSURE RANGE	80 - 125 psig DYNAMIC [552-860 kPa] 80 - 125 psig STATIC [552-860 kPa]		2. STERIS RECOMMENDS A REFRIGERATED AIR DRYER WHERE ENVIRONMENTAL DEW POINT CONDITIONS ARE HIGHER THAN RECOMMENDED.
	OPERATING FLOW RATE	6 SCFM [170 L/min]		3. CUSTOMER MUST PROVIDE UTILITY CONNECTIONS WITH SHUTOFFS DISCONNECTS WITHIN 2 FEET OF THE PERIMETER OF THE EQUIPMENT AND BELOW THE FINISHED CEILING.
DRAIN (D)	FLOOR DRAIN SIZE	4 in [102 mm] O.D. WITH FLOOR SINK FLOOR SINK WITHOUT SEISMIC: MIN. 6IN X 8IN / MAX. 8IN X 8IN FLOOR SINK WITH SEISMIC: 6IN X 6IN REQUIRED		4. WASHER DRAIN OUTLET SIZE 3 in 5. FOR DRAIN REQUIREMENTS WHEN USING SEISMIC MOUNTS, SEE PAGE 3.
	OPERATING FLOW RATE	GRAVITY DRAIN : Non-vented unit: 72 US GPM [272.5 L/min] Vented unit: 58.6 US GPM [221.9 L/min]		
CHEMICAL DOSING SYSTEM	CEILING ROUTING CONDUIT	3 in CONDUIT		6. STERIS RECOMMENDS TO ROUTE CHEMICAL LINES AND SIGNAL CABLE THROUGH A 3 in [76 mm] ID CONDUIT (BY OTHERS). 100 ft [30 m] OF INJECTION LINE AND SIGNAL CABLE ARE PROVIDED WITH THE UNIT. UP TO 150 ft [45 m] WITH CHEMICAL DOSING SYSTEM EXTENSION 50' ACCESSORY (FD36-5)
STEAM INLET (S)	CONNECTION SIZE / TYPE	1 in / FEMALE NPT [1 in / MALE BSPT]		7. STERIS REQUIRES AT LEAST 97% SATURATED DRY PLANT STEAM, FREE OF DIRT, RESIDUES AND CONTAMINANTS.
	PRESSURE RANGE	30 - 50 psig DYNAMIC [206-345 kPa] 30 - 90 psig STATIC [206-620 kPa]		8. STERIS RECOMMENDS TO INSTALL A STEAM TRAP AS CLOSE AS POSSIBLE TO UNIT CONNECTION.
	OPERATING MASS FLOW RATE	771.1 lb/h [350.5 kg/h] AT 30 psig [207 kPa] 1056.5 lb/h [480.2 kg/h] AT 50 psig [345 kPa]		9. PROPER OPERATION OF THE WASHER REQUIRES A MINIMUM PRESSURE DIFFERENTIAL OF 21.5 psig [148 kPa] BETWEEN STEAM INLET AND CONDENSATE RETURN. IN CASES OF LOW STEAM INLET PRESSURE, CONDENSATE CAN BE ROUTED TO DRAIN TO INCREASE DIFFERENTIAL.
	TOTAL CONSUMPTION PER CART CYCLE	27.8 lb [12.6 kg]		*STERIS OFFERS CONDENSATE RETURN TO DRAIN ACCESSORY (FD36-4)
CONDENSATE RETURN (CR)	PRESSURE RANGE	0 - 8.5 psig [0 - 68.9 kPa] BACK PRESSURE (17 ft [5.2 m] ELEVATION) (FOR 30 psig OF STEAM INLET PRESSURE) SEE *NOTE 9		10. CUSTOMER MUST PROVIDE UTILITY CONNECTIONS WITH SHUTOFFS DISCONNECTS WITHIN 2 FEET OF THE PERIMETER OF THE EQUIPMENT AND BELOW THE FINISHED CEILING.
	OPERATING FLOW RATE	PEAK : 2.1 US GPM [8 L/min]		11. STERIS REQUIRES TO INSTALL PRESSURE GAUGE.
	CONNECTION SIZE / TYPE	1 in / FEMALE NPT [1 in / MALE BSPT]		12. STERIS REQUIRES A LOW PRESSURE CONDENSATE RETURN SYSTEM ON STEAM AND CONDENSATE LINES.




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## UTILITY REQUIREMENTS CHART (ELECTRIC)

UTILITY		PARAMETER AND REQUIREMENT			NOTES
		CONNECTION SIZE/TYPE	NOMINAL AMPERAGE	RECOMMENDED CIRCUIT	
ELECTRICITY (EL)	200-208V 60 Hz, 3-Ph	1 1/4 in [35] 2 in [53] CONDUIT	23.1 A	30 A	1. ALL CONNECTIONS SHOULD BE IN ACCORDANCE WITH LOCAL CODES. 2. NEUTRAL WIRE NOT REQUIRED, EXCEPT FOR 380-400-415V 50Hz, 380-400V 60Hz AND 400V 60Hz. 3. ALWAYS FOLLOW LOCAL ELECTRICAL CODES AND SAFETY-RELATED WORK PRACTICES TO DETERMINE THE VALUE OF PROTECTION. 4. WIRING ON THE EQUIPMENT TERMINATES AT A JUNCTION BOX. WIRING BETWEEN JUNCTION BOX AND BUILDING SERVICE LINES ARE NOT SUPPLIED BY STERIS. 5. A DISCONNECT SWITCH MEETING THE LOCAL ELECTRICAL CODES REQUIREMENTS MUST BE INSTALLED IN ELECTRICAL SUPPLY LINES NEAR WASHER/DISINFECTOR. THE DISCONNECT DEVICE OF THE EQUIPMENT MUST BE WITHIN SIGHT AND REACH OF THE OPERATOR, NO MORE THAN 1 m (39 in) AWAY FROM EQUIPMENT AND BELOW FINISHED CEILING. DISCONNECT SWITCH SHALL BE LOCKOUT CAPABLE. 6. STERIS RECOMMENDS A LIGHT IN SERVICE AREA.
	380-400V 60 Hz, 3-Ph	1 1/4 in [35] 2 in [53] CONDUIT	12.2 A	20 A	
	400V 60 Hz, 3-Ph	1 1/4 in [35] 2 in [53] CONDUIT	11.6 A	15 A	
	460-480V 60 Hz, 3-Ph	1 1/4 in [35] 2 in [53] CONDUIT	11 A	15 A	
	600V 60 Hz, 3-Ph	1 1/4 in [35] 2 in [53] CONDUIT	8.1 A	15 A	
	380-400-415V 50 Hz, 3-Ph	1 1/4 in [35] 2 in [53] CONDUIT	12.6 A	20 A	
NETWORK (N) OPTIONAL		100/1000 BASE T SUPPORTING TCP/IP PROTOCOL RJ45F CONNECTION			7. NETWORK CONNECTION (IF APPLICABLE): - ACTIVE NETWORK DROP WITH CAT 5/6 CABLE WITHIN 10FT [3m] OF UNIT - STATIC OR DHCP RESERVED IP ADDRESS (FOR EACH UNIT) - NETWORK CABLE SUPPLIED BY FACILITY.




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## UTILITY REQUIREMENTS CHART

UTILITY	PARAMETER	REQUIREMENT	✓	NOTES
VENTILATION EXHAUST (EX)	CONNECTION SIZE	6 in [152 mm] OUTSIDE DIAMETER		1. NOT REQUIRED WITH NON VENTED UNIT.
	PRESSURE RANGE	1/2 inH <sub>2</sub> O [13 mmH <sub>2</sub> O] VACUUM AT CONNECTION		2. STERIS REQUIRES CORROSION-RESISTANT AND WATER-TIGHT DUCT: - MIN OPERATING TEMPERATURE 210 °F [99 °C] - SLOPED TOWARDS THE WASHER AND NO DEAD LEGS - INSTALL DRAIN PART AT LOWEST POINT NEAR UNIT
	OPERATING FLOW RATE	350 SCFM [9.9 m <sup>3</sup> /min]		3. EXHAUST FAN NORMALLY OPEN-AUXILIARY CONTACTS IS AVAILABLE TO SUPPLY A SIGNAL TO THE FACILITY HVAC CONTROL SYSTEM WHENEVER THE WASHER VENTILATION EXHAUST FAN IS IN OPERATION.
	TEMPERATURE RANGE	MAX. 210 °F [99 °C]		
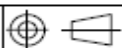
## TYPICAL HEAT LOSS AT 75 °F [24 °C] CONTINUOUS OPERATION

	NON-VENTED UNIT WITHOUT ACU-RINSE RES.	VENTED UNIT WITHOUT ACU-RINSE RES.
CLEAN SIDE	1313 Btu/h [385 Wh]	1313 Btu/h [385 Wh]
SOILED SIDE	8587 Btu/h [2511 Wh]	2488 Btu/h [729 Wh]
TOTAL	9880 Btu/h [2896 Wh]	3801 Btu/h [1114 Wh]

VALUES INCLUDE HEAT LOSS DURING DOOR OPENING FOR LOADING AND UNLOADING OPERATIONS. "TOTAL" WILL VARY DEPENDING ON DISINFECTION TIME AND TEMPERATURE, DRYING TIME AND TEMPERATURE AND USE RATE OF UNIT.  
AN ADDITIONAL HEAT LOSS FOR LOAD COOL DOWN IN CLEAN SIDE CAN BE ADDED TO THE TOTAL HEAT LOSS OF THE WASHER.  
MAXIMUM 793 Btu [836 kJ]

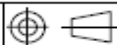


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## PHYSICAL SPECIFICATIONS

VERIFY THAT HALLS, DOORS, ELEVATORS AND ALL OTHER ENTRANCES MEET WEIGHT AND DIMENSIONAL CLEARANCE SPECIFICATIONS:		1. LEVELING FEET ARE PROVIDED FOR PROPER INSTALLATION.
ACCESS TO INSTALLATION SITE	ACCESSIBLE BY PALLET JACK AND/OR FORK LIFT.	2. PERMISSIBLE ENVIRONMENTAL CONDITIONS. THIS EQUIPMENT IS DESIGNED TO GIVE OPTIMAL RESULTS UNDER THE FOLLOWING CONDITIONS: - INDOOR USE ONLY; - ALTITUDE OF OPERATION UP TO 8562 ft [2000 m]; - TEMPERATURE OF 41 TO 104 °F [5 to 40 °C]; - MAXIMUM RELATIVE HUMIDITY IS 80% FOR TEMPERATURE UP TO 88 °F [31 °C], DECREASING LINEARLY TO 50% RELATIVE HUMIDITY AT 104 °F [40 °C]; - POLLUTION DEGREE 2: EQUIPMENT MUST BE INSTALLED IN AN ENVIRONMENT WHERE NORMALLY ONLY NON-CONDUCTIVE POLLUTION OCCURS BUT WHERE OCCASIONAL, TEMPORARY CONDUCTIVITY CAUSED BY CONDENSATION CAN BE EXPECTED (AS DETERMINED ACCORDING TO INTERNATIONAL STANDARD EN/IEC 61010-1).
SHIPPING WEIGHT AND DIMENSIONS (W x H x L)	CRATE A: 575 lb [260 kg] 37 x 56 x 83 in [940 x 1530 x 2110 mm]	3. STERIS ASSUMES NO RESPONSIBILITY FOR CHANGES MADE TO, OR FAILURE TO OBSERVE THE SPECIFICATIONS ON EQUIPMENT DRAWING AND NOTE PAGES. SPECIFICATIONS AND DESCRIPTIONS ARE SUBJECT TO CHANGE WITHOUT NOTICE.
	CRATE B: 945 lb [430 kg] 37 x 81 x 83 in [940 x 2080 x 2110 mm]	
	CRATE C: 510 lb [232 kg] 38 x 83 x 61 in [970 x 2110 x 1550 mm]	
	CRATE D: 400 lb [181 kg] 38 x 83 x 61 in [970 x 2110 x 1550 mm]	
	CRATE E: 410 lb [186 kg] 38 x 83 x 61 in [970 x 2110 x 1550 mm]	
	CRATE F: 900 lb [408 kg] 37 x 45 x 83 in [940 x 1150 x 2110 mm]	
	CRATE G: 840 lb [381 kg] 37 x 45 x 106 in [940 x 1150 x 2700 mm]	
	CRATE H: 660 lb [299 kg] 37 x 78 x 61 in [940 x 1990 x 1550 mm]	
LARGEST UNCRATED PIECE: WEIGHT AND DIMENSIONS (W x H x L)	CHAMBER CENTRAL PART (CRATE C): WEIGHT: 204 LB [93 kg] 33-3/4 x 72 x 50 in [860 x 1830 x 1270 mm]	
HEAVIEST UNCRATED PIECE: WEIGHT AND DIMENSIONS (W x H x L)	SUMP (CRATE B): WEIGHT: 337 lb [153 kg] 69 x 8 x 77 in [1753 x 203 x 1956 mm]	
OPERATING DIMENSION W x H x L	W 70" x H 94-1/4" x L 74" [1778 mm x 2394 mm x 1880 mm]	
MAXIMUM OPERATING WEIGHT WATER, RACK AND LOAD	3203 lb [1453 kg]	
AVERAGE FLOOR LOAD OVER WASHER FOOTPRINT	0.57 psi [3.93 kPa]	
MAX. FLOOR LOAD AT WASHER FOOT PADS (3 in [76 mm] DIAMETER PADS)	154 psi [1062 kPa]	
NOISE LEVEL: A-WEIGHTED EQUIVALENT SURFACE SOUND PRESSURE LEVEL	65.0 dB(A) CALCULATED AS DESCRIBED IN ISO 3746.	
OPENING AREA FROM CLEAN SIDE TO SOILED SIDE	40 in² [25806mm²]	
CHAMBER DIMENSION W x H x L VOLUME	W 37-1/8" X H 60" X D 66-1/8" [943 mm x 1524 mm x 1679 mm] 85.2 ft³ [2.41 m³]	
FIRE PREVENTION DEVICES	STERIS DOES NOT RECOMMEND INSTALLATION OF SPRINKLER OVER THE UNIT BUT IF REQUIRED BY LOCAL CODE IT MUST BE FUSE TO 260 F (126 C) OR ABOVE. ANY SPRINKLER HEADS IN FRONT OF THE LOAD/UNLOAD DOORS MUST ALSO BE FUSE TO 260 F (126 C) OR ABOVE.	




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Issue Date:

3/6/2024

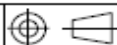Expansion and Renovation

Decorah, IA 52101

Furniture Specifications

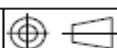CONTACT:

Ben Stevens - CFO

PHONE NUMBER:

563-387-3109

ITEM NUMBER:

2

ITEM NAME:

Triple Bay Reprocessing Sink

ROOM NUMBER:

QUANTITY:

## SPECIFICATION INFORMATION

MANUFACTURER:

Steris

MODEL #:

SINK50120

DIMENSIONS:

120" W x 28 1/16" D x 33"-42" Working H

DESCRIPTION:

3 Basin adjustable height reprocessing sink; bay dimensions 30" w x 17" H x 10" D; (1) air pistol w/ tip attachment; (1) water pistol w/ tip attachment; (2) back splash-mounted pre-rinse/ faucet comb; (1) back splash-mounted treated water faucet and magnetic back splash; 120 V; 15A GFCI protected outlet requirement; Draws 3 amps; External Drain Lever Handles


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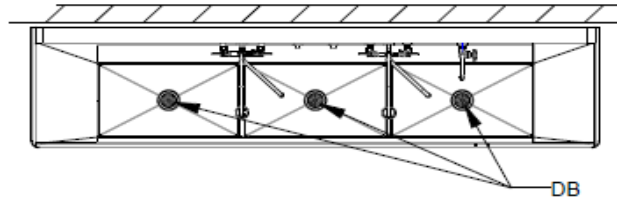
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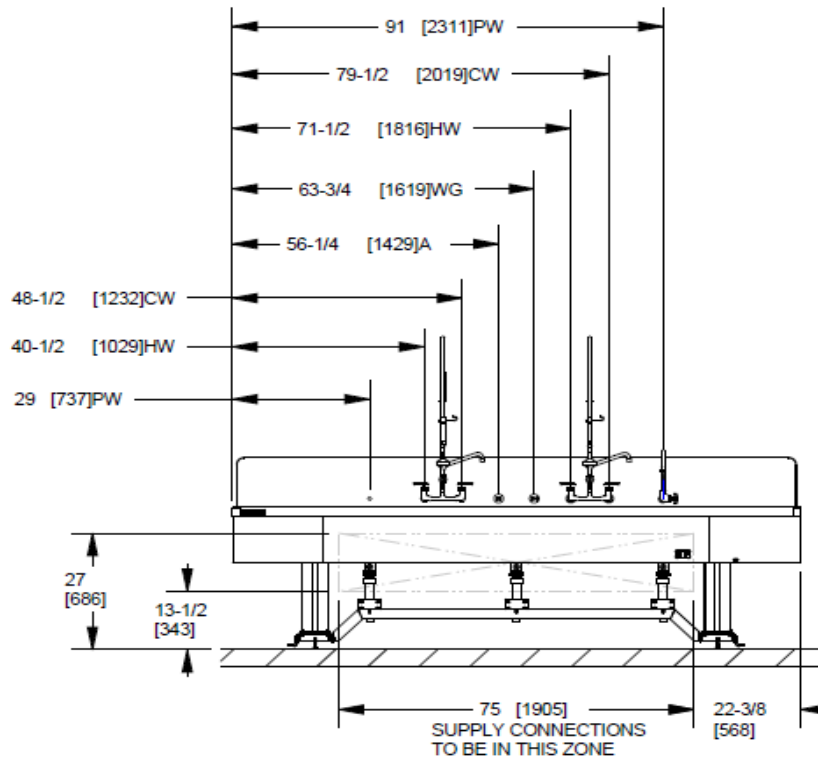
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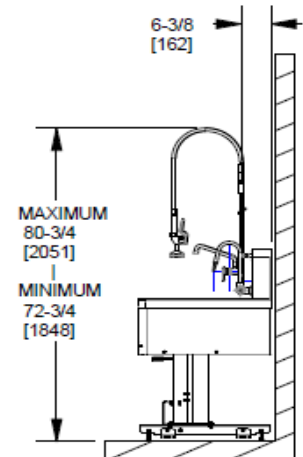
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HW	HOT WATER
CW	COLD WATER
PW	PURE WATER
WG	WATER GUN
A	COMPRESSED AIR
DB	DRAIN BASKET (BASIN)
D	DRAIN



FRONT VIEW



RIGHT SIDE VIEW  
SHOWN AT  
MAX HEIGHT

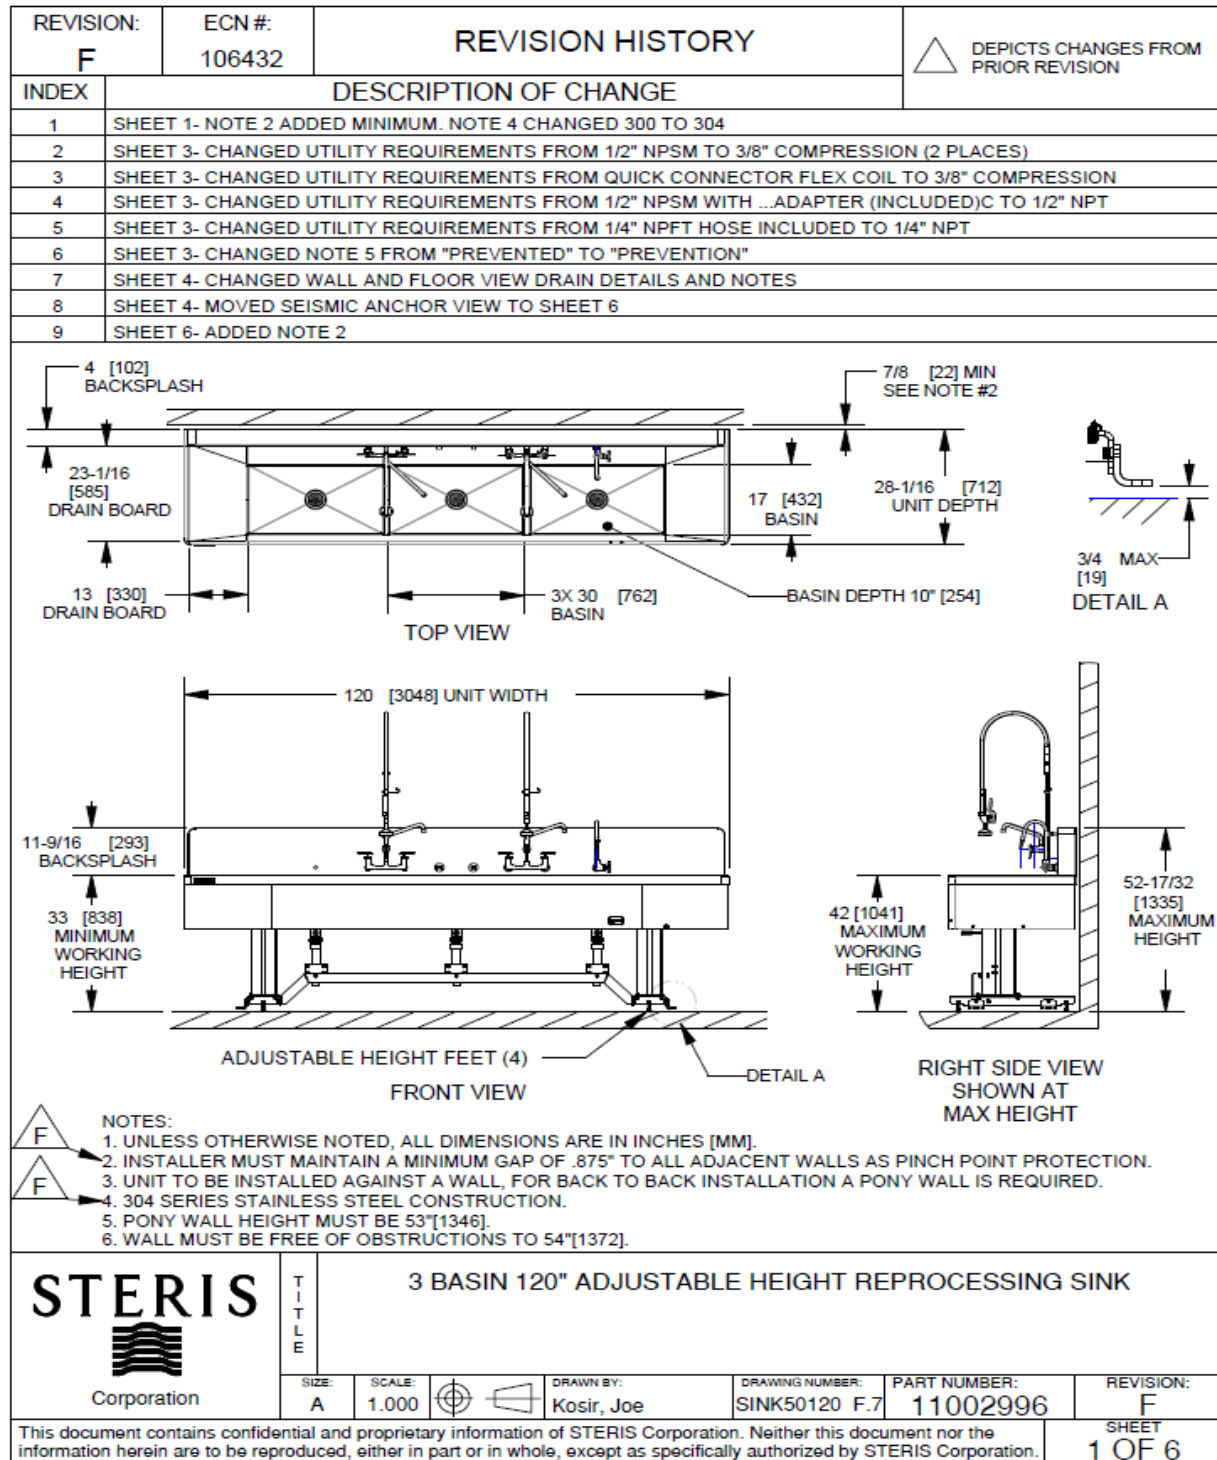NOTE: WORKFLOW CAN BE REVERSED BY MOVING PURE WATER FAUCET FROM RIGHT SIDE TO HOLE ON LEFT THAT IS CAPPED. ADDITIONALLY THE COMPRESSED AIR AND WATER GUN FIXTURES SHOULD BE SWAPPED.




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3 BASIN 120" ADJUSTABLE HEIGHT REPROCESSING SINK

SIZE:  
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SCALE:  
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DRAWN BY:  
Kosir, Joe

DRAWING NUMBER:  
SINK50120 F.7

PART NUMBER:  
11002996

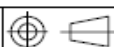REVISION:  
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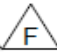
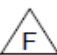
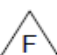
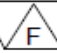
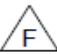
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SHEET  
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## ADJ. HEIGHT PROCESSING TRIPLE SINK 120" X 28" X 33"-41"

### UTILITY REQUIREMENTS CHART (PLUMBING)

UTILITY	PARAMETER	REQUIREMENT	NOTES
HOT WATER (HW)	CONNECTION TYPE/SIZE	3/8" COMPRESSION ←	
	PRESSURE RANGE	15 TO 125 PSI	
	OPERATING FLOW RATE	1.6 GPM @ MAX PSI	
	TEMPERATURE RANGE	40° F TO 180° F	
	WATER QUALITY	SEE NOTE #2	
COLD WATER (CW)	CONNECTION TYPE/SIZE	3/8" COMPRESSION ←	
	PRESSURE RANGE	15 TO 125 PSI	
	OPERATING FLOW RATE	1.6 GPM @ MAX PSI	
	TEMPERATURE RANGE	70° F MAX	
	WATER QUALITY	SEE NOTE #2	
PURE WATER (PW)	CONNECTION TYPE/SIZE	1/2" NPT ←	
	PRESSURE RANGE	20 TO 125 PSI	
	OPERATING FLOW RATE	.25 TO 2.00 GPM ±15%	
	TEMPERATURE RANGE	40° F TO 140° F	
	WATER QUALITY		
WATER GUN (WG)	CONNECTION TYPE/SIZE	3/8" COMPRESSION ←	 
	PRESSURE RANGE	0 TO 44 PSI	
	OPERATING FLOW RATE		
	TEMPERATURE RANGE	40° F TO 125° F	
	WATER QUALITY	SEE NOTE #2	
AIR GUN (A)	CONNECTION TYPE/SIZE	1/4" NPT ←	CONNECTION MUST BE MADE PER LOCAL CODE
	PRESSURE	30 PSI MAX	
	TIP 1	CONSUMPTION AT 30 PSI	2 SCFM
	TIP 2		
	TIP 3		
	TIP 4		
	TIP 5		
	TIPS 4 & 5 MUST BE OPERATED AT 30 PSI OR LESS TO COMPLY WITH OSHA DIRECTIVE		
BASIN DRAIN (BD)	CONNECTION TYPE	Ø 1-1/2" ABS P-TRAP (INCLUDED) Ø 2" COPPER P-TRAP (ACCESSORY)	DRAIN RATE AT 20 GPM EACH BASIN (ESTIMATED)

#### NOTES:

- SUPPLY LINES FOR EACH CONNECTION ARE SHIPPED WITH EACH SINK.
- STERIS RECOMMENDS THE FOLLOWING WATER QUALITY PARAMETERS:
  - 100-200 PPM (500PPM MAX) TOTAL DISSOLVED SOLIDS.
  - 70-120 PPM (180PPM MAX) TOTAL ALKALINITY.
  - 6.8-7.0PH (7.5 MAX).
  - 0.1-0.5PPM (1.0PPM MAX) TOTAL SILICA.
- STERIS DOES NOT SUPPLY A PRESSURE REGULATOR FOR USE WITH AIR GUN.
- STERIS DOES NOT SUPPLY A PRESSURE REDUCING VALVE FOR USE WITH WATER GUN.
- BACK FLOW PREVENTION BY CUSTOMER AGAINST BACK SIPHONAGE MAY BE REQUIRED (CHECK LOCAL PLUMBING CODE).
- FLOOR SINK OUTLET NEEDS TO BE ABLE TO ACCOMMODATE WASTE FROM ALL BAYS (CHECK LOCAL PLUMBING CODE).
- REFERENCES FOR PARAMETERS ARE TO MANUFACTURER'S RECOMMENDATION AND SHOULD BE FOLLOWED ACCORDINGLY.

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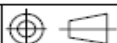
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3 BASIN 120" ADJUSTABLE HEIGHT REPROCESSING SINK

SIZE:  
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SCALE:  
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DRAWN BY:  
Kosir, Joe

DRAWING NUMBER:  
SINK50120 F.7

PART NUMBER:  
11002996



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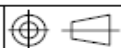
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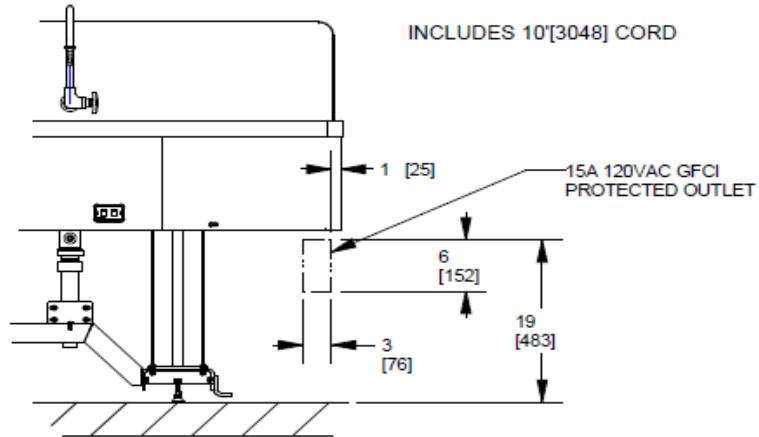
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4 OF 6

# WinnMed

## UTILITY (ELECTRICITY) CONNECTION POSITION RECOMMENDED



PARTIAL FRONT VIEW
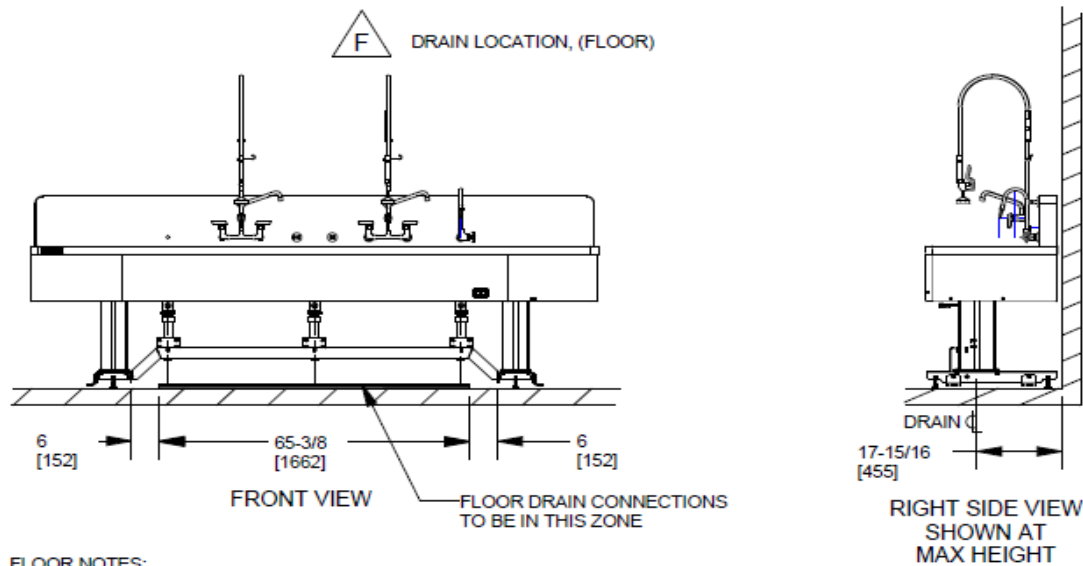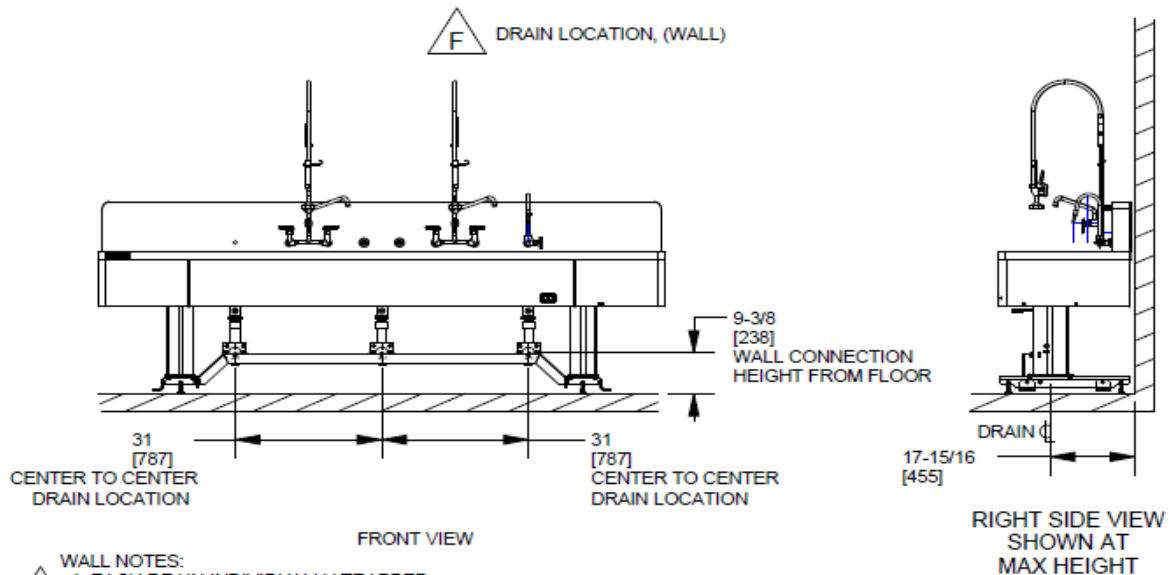
## ADJ. HEIGHT REPROCESSING TRIPLE SINK 120" X 28" X 33" TO 41"

### UTILITY SPECIFICATIONS CHART (ELECTRICAL)

#### ELECTRICITY

UTILITY	PARAMETER	REQUIREMENT	NOTES
ELECTRICITY	120V	15A GFCI PROTECTED OUTLET	
LINAK DL2 LIFT SYSTEM			
LINAK DL2 LIFT SYSTEM	WEIGHT CAPACITY	562LBS [2500 N] EACH	WITH OVERLOAD PROTECTION
	ADJUSTMENT RANGE	8.0" [203,2]	
	LIFT SPEED	UP TO 3/8"[10] PER SECOND	
	VOLTAGE	120VAC, 3A	




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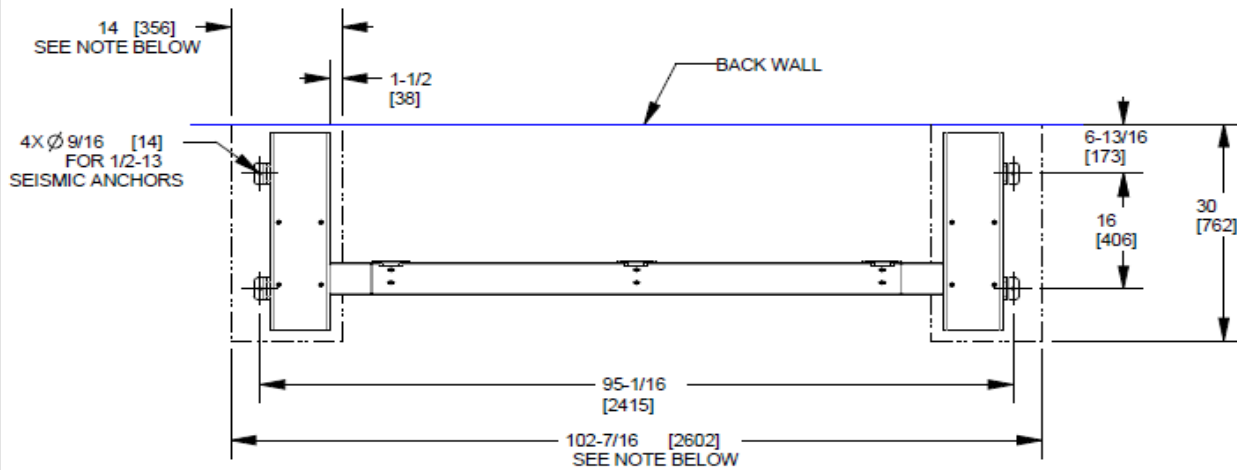
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5 OF 6



# WinnMed

## SEISMIC ANCHOR HOLE POSITIONS

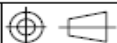

### NOTE:



1. CONCRETE FLOOR MUST REMAIN FREE OF DEFECTS IN THESE AREAS FOR INSTALLATION OF SEISMIC ANCHORS (NOT PROVIDED BY STERIS).
2. REFER TO EQUIPMENT SPECIFIC SEISMIC DRAWING FOR MORE INFORMATION.

## PHYSICAL SPECIFICATIONS

SHIPPING DIMENSIONS L X W X H	132L X 36W X 48H
SHIPPING WEIGHT	690 LBS
OPERATING DIMENSIONS L X W X H	120" X 28" X 44-9/16" TO 52-9/16" [3048 X 711 X 1132 TO 1412]
OPERATING WEIGHT EMPTY	490 LBS
WORKING HEIGHT	33"[838] TO 41"[1041]




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6 OF 6

# WinnMed

WinnMed

Issue Date:

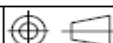3/6/2024

Expansion and Renovation

Decorah, IA 52101

Furniture Specifications

CONTACT:

Ben Stevens - CFO

PHONE NUMBER:

563-387-3109

ITEM NUMBER:	3
--------------	---

ITEM NAME:	InnoWave ProSonic Irrigator		
------------	-----------------------------	--	--

ROOM NUMBER:		QUANTITY:	
--------------	--	-----------	--

SPECIFICATION INFORMATION	
---------------------------	--

MANUFACTURER: Steris

MODEL #: IWPRO60

DIMENSIONS: 50" W x 36" D x 43.5" H

DESCRIPTION: Ultrasonic cleaning w/ up to 60 lumened devices or 66 lbs instrument capacity; multiple cycle phases, air-purge; elevator loading/unloading; touch-screen control panel

FURNITURE & EQUIPMENT IMAGE
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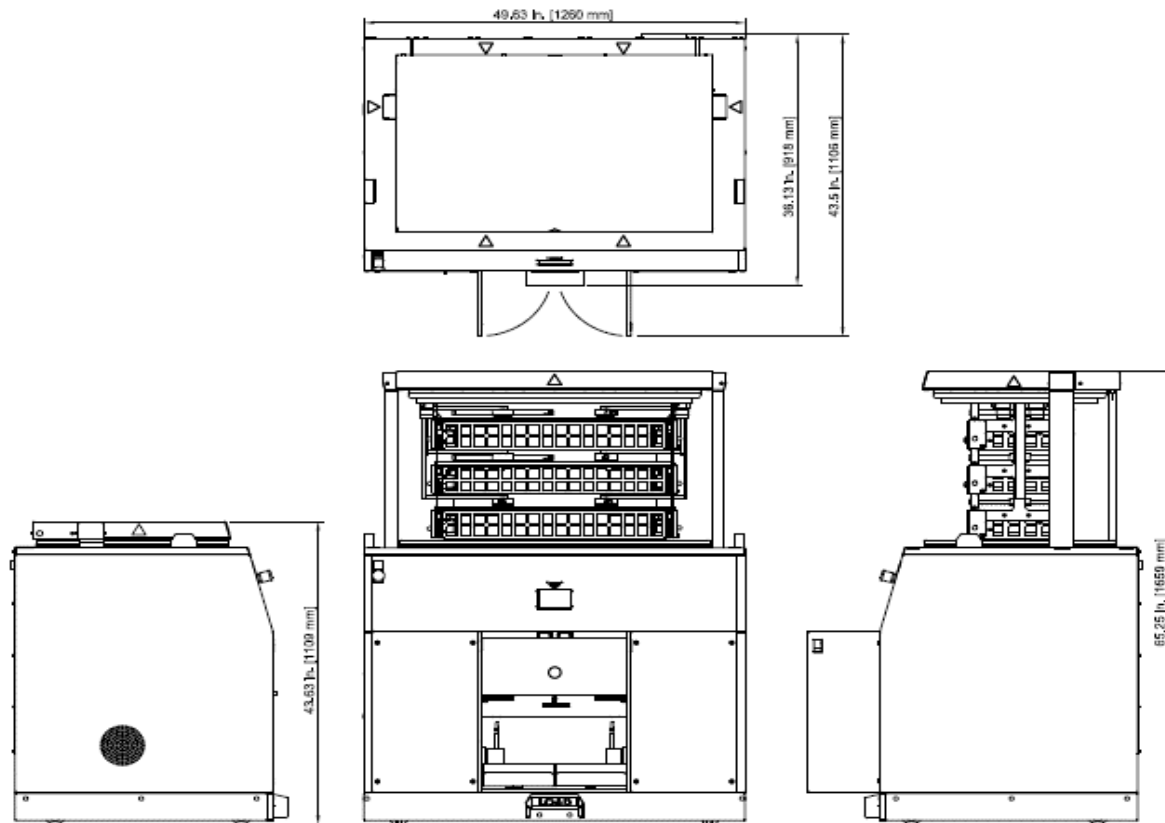


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## External Dimension



## Physical dimensions and weight

External height (lid closed)	43.6 in.	1109 mm
External height (lid open)	65.3 in.	1659 mm
External width	49.6 in.	1260 mm
External depth	36.1 in.	918 mm
Net weight (dry)	905 lbs	410 kg
Operating weight (tank filled)	380 lbs	172 kg
Max. operating weight (Incl. filled tank, chemicals, and instruments to be cleaned)	1162 lbs	527 kg



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InnoWave Pro, Equipment Specification Built after SN 11189855522 and up to 0922 2027900 and WITHOUT Internal drain cooling.

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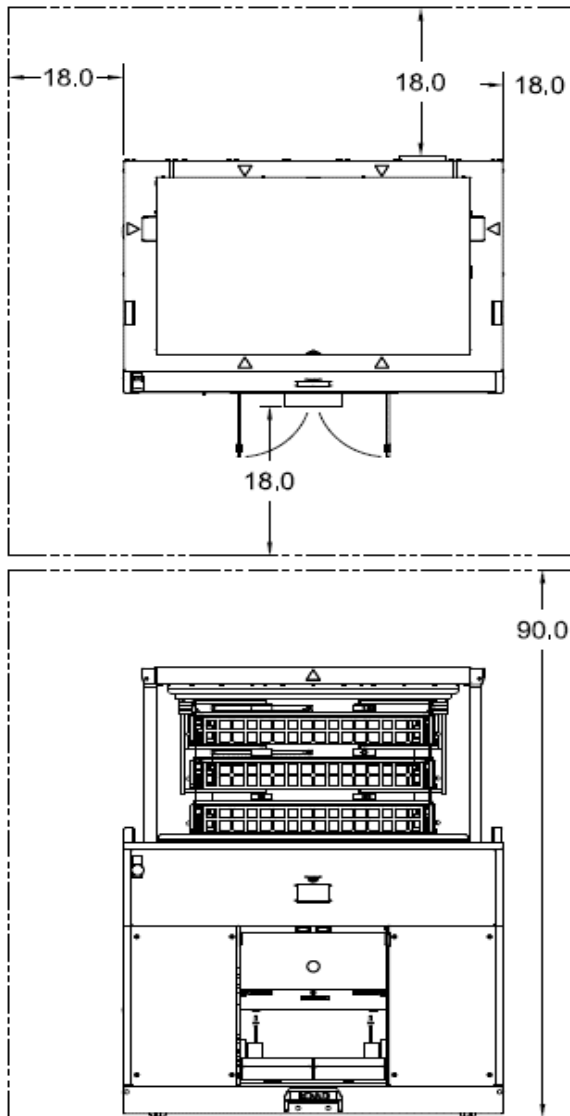
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1 OF 10

# WinnMed

## Suggested Clearances When Servicing Machine



### Notes:

1. Clearances are in INCHES
2. Machine should be moved to a position with minimum clearances shown for servicing.
3. Space for service clearances are not required while the unit is in the installed position.
4. Adequate space should be provided in the room for servicing the machine, so it can be wheeled or moved to accommodate servicing.
5. Reference other pages for installation clearances.




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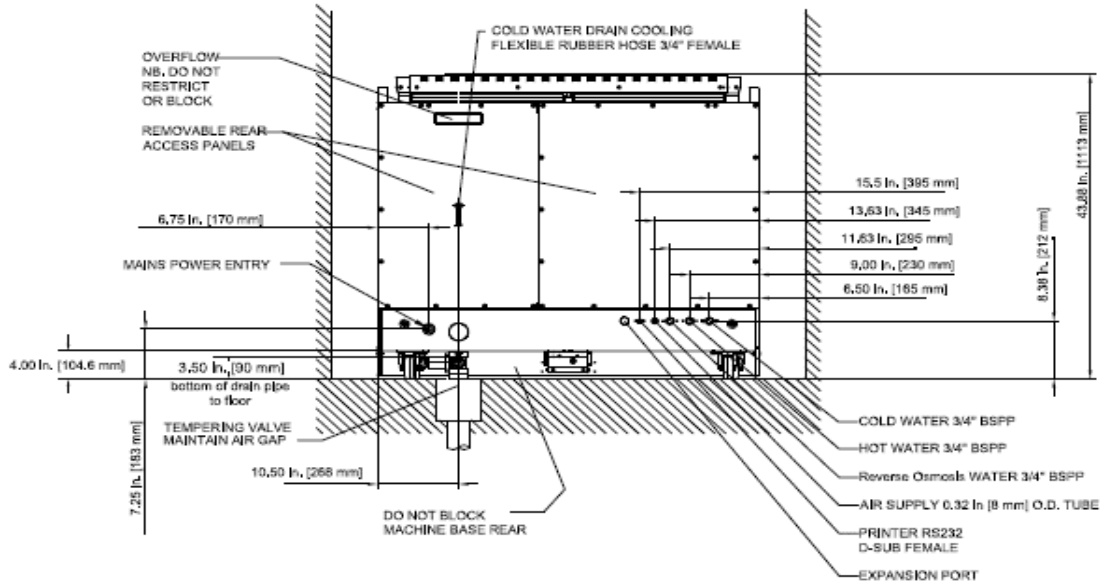
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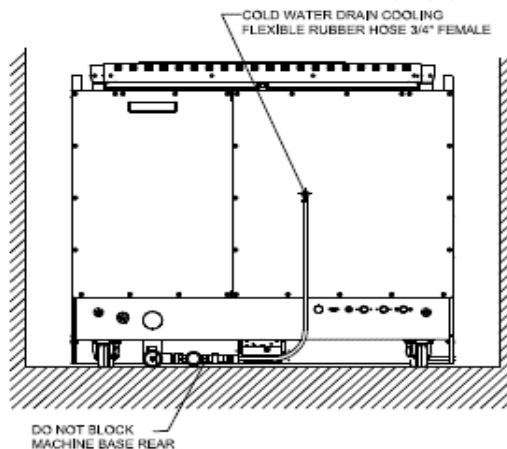
SHEET  
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## Utility Connections REAR VIEW WITH LID CLOSED, SHOWING SERVICES



## DRAIN OUTSIDE OF MACHINE'S FOOTPRINT REAR VIEW WITH LID CLOSED

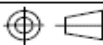

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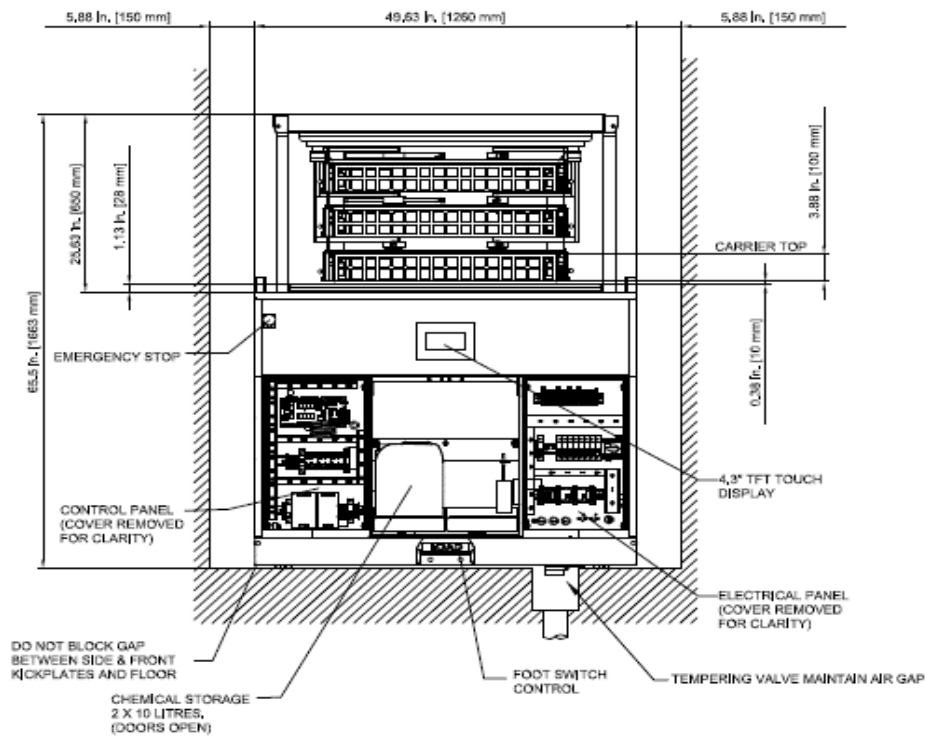
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## Installed Operation Clearances DRAIN WITHIN OR OUTSIDE MACHINE'S FOOTPRINT FRONT VIEW WITH LID OPEN




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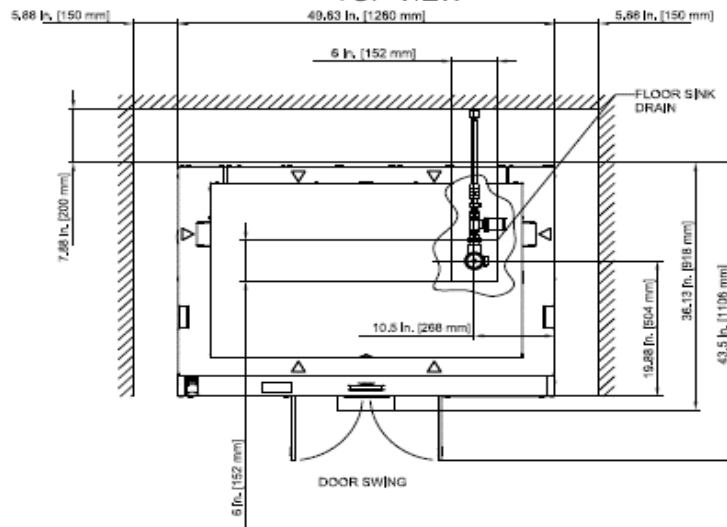
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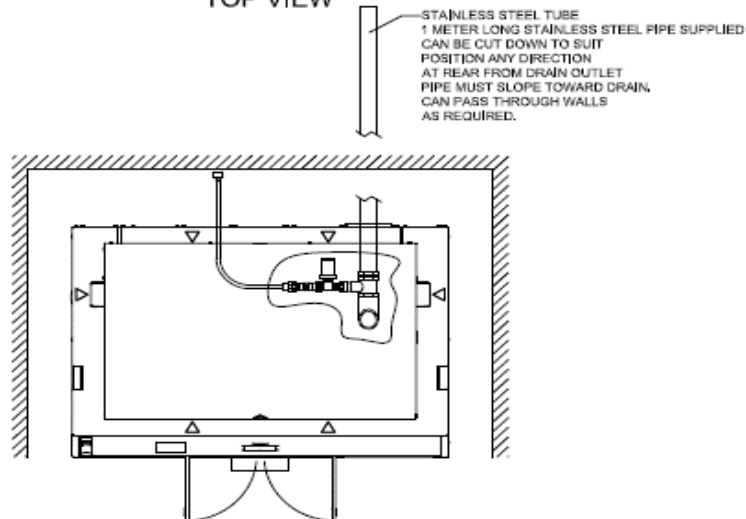
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**3 OF 10**

# WinnMed

## Installed Operation Clearances DRAIN WITHIN MACHINE'S FOOTPRINT TOP VIEW

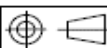

## Installed Operation Clearances DRAIN OUTSIDE OF MACHINE'S FOOTPRINT TOP VIEW




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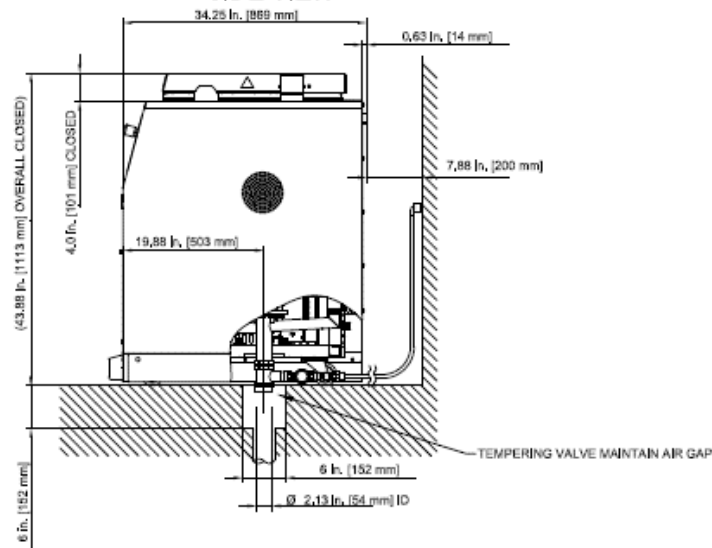
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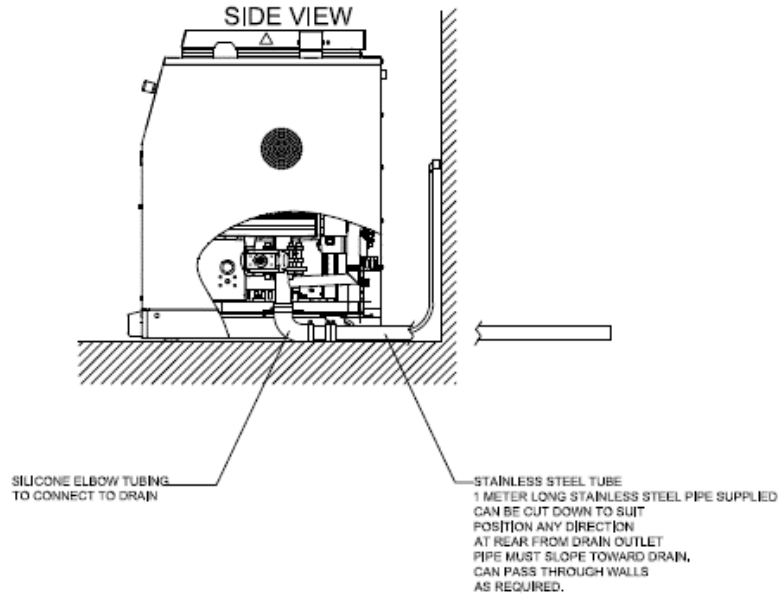


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## Installed Operation Clearances DRAIN WITHIN MACHINE'S FOOTPRINT SIDE VIEW



## Installed Operation Clearances DRAIN OUTSIDE OF MACHINE'S FOOTPRINT SIDE VIEW

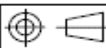


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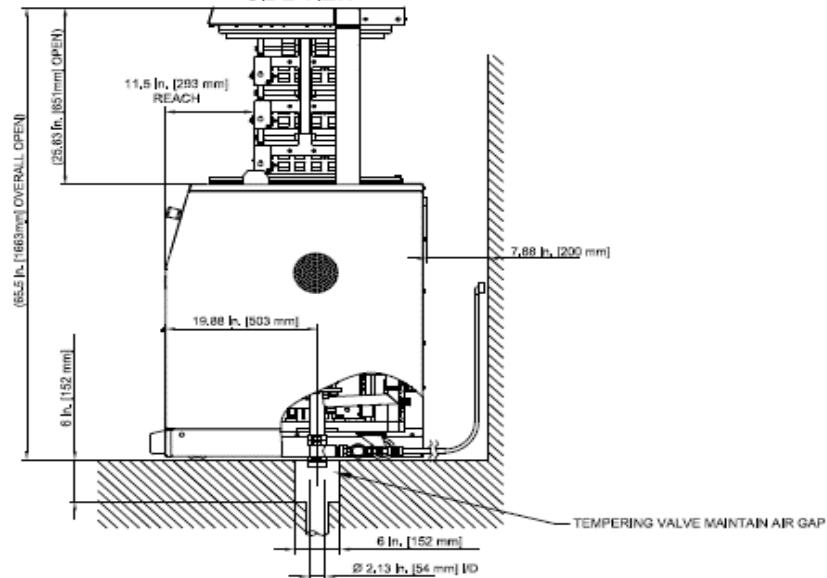
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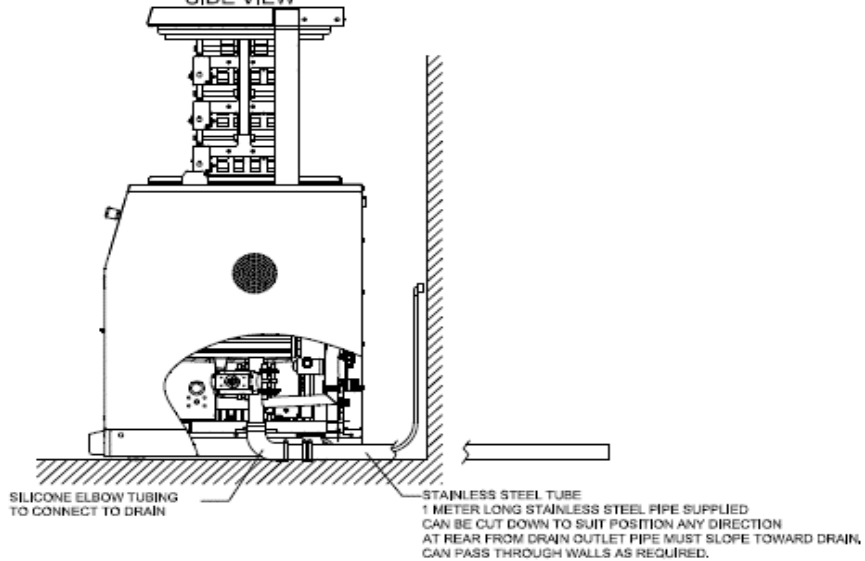
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5 OF 10

# WinnMed

## Installed Operation Clearances DRAIN WITHIN MACHINE'S FOOTPRINT SIDE VIEW

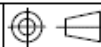

## Installed Operation Clearances DRAIN OUTSIDE OF MACHINE'S FOOTPRINT SIDE VIEW




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# WinnMed

## Water supply requirements:

Water hardness (CaCO <sub>3</sub> ), quality and purity, hot and cold supplies	< 125 ppm with water quality and purity tested and approved for disinfection as per ANSI/AAMI ST 15883-1:2009 (Item 6.4.1 and 6.4.2) or AAMI TIR 34
Pressure (hot and cold), Static	30 to 70 psi (2.0 to 5.0 Bar)
Flow rate (hot and cold)	3 to 8 gal/min. (11 to 30 litres/min.)
Temperature (hot and cold)	Cold: +41 to 86 °F (+5 to 30 °C) Hot: +122 to 176 °F (+50 to 80 °C)*
Connections	3/4 in. BSP male thread Rubber gasket is required. Do not use tape or any sealant, 3/4" NPT facility connections required. Hose connections will not work. Do not hard pipe water connections. Machine must be easily movable for service and maintenance.

\*The unit is able to operate without hot water connection or with hot water supply cooler than recommended minimum temperature of +122 °F (+50 °C). Using only cold water or low-temperature hot water will result in longer cycle operation as water takes longer to heat up in unit.
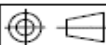
### Typical water consumption per wash

Water consumption will vary depending on volume of Instruments loaded and temperature of Inlet water supply. The water consumption below describes complete wash cycle at +104 °F (+40 °C), with no instruments loaded.

### Maximum water consumption for complete wash cycle

Stage	Cold water	Hot water	RO Water *	Total for stage
Pre-wash	10.6 gallons (40 litres)	nil	nil	10.6 gallons (40 litres)
Wash	1 gallon (3.7 litres)	65 gallons (246 litres)	nil	66 gallons (250 litres)
Rinse	10.6 gallons (40 litres)	nil	nil	10.6 gallons (40 litres)
Disinfection	10.6 gallons (40 litres)	nil	10.6 gallons (40 litres)	21.2 gallons (40 litres)
Disinfection Condensate	43.5 gallons (165 litres)	nil	nil	43.5 gallons (165 litres)
Cooling	28 gallons (105 litres)	nil	nil	28 gallons (105 litres)
Total water consumption	104.3 gallons (393 litres)	65 gallons (247 litres)	10.6 gallons (40 litres)	180 gallons (681 litres) includes 38 gallons R.O.

\*If RO is used, cold water is not used during disinfection




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# WinnMed

## Site drain requirements The site drain should meet the following requirements:

Drain connection	2.125 in. (54 mm) outlet from unit. Drain must be fitted with suitable traps. Remote drain must slope to floor drain. Air gap must be maintained per local code. Do not hard pipe drain connection. The machine must be easily movable for service and maintenance.
Position	Unit should be positioned so that the centerline of the unit is aligned with the center of the floor sink outlet. If remote drain is used, drain line must be level or sloping away from unit. Remote drain also requires a floor sink. Adhere to local code.
Capacity	47.5 gallons/minute, (30 litres/minute) Maximum discharge to drain including overflow, (minimum drain capacity of 8 gallons/minute). When drain tempering valve is installed, maximum flow to drain is 8 gallons/minute including DTV cooling water flow rate.
Overflow Drain	Internally connected within the machine to the drain pipe, downstream of the drain valve. Maximum overflow drain is 8 gallons per minute.
Effluent temperature	up to +140 °F (+60 °C) Max. and +203 °F (+95 °C) without DTV kit. DTV is required in North America. Other locations refer to local or national codes.
Floor Sink Dimensions	6.0 in x 6.0 (152 mm x 152mm) in with a 3.0 in. (76 mm) minimum drain outlet at bottom of floor sink.
Compressed Air Supply	<b>Pressure:</b> 5.5 bar to 7.0 bar (80 to 100 psi). <b>Quality:</b> If medical grade compressed air is not used, and Elimizer filter needs to be included at time of order. <b>Connection:</b> 8mm (0.315 in) dia, Quick fit hose connector, <b>Air Flow Rate:</b> 19SCFM.

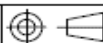


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# WinnMed

The disconnect switch must:

- Isolate all poles simultaneously
- Be lockable in the off position
- Comply with standards IEC/EN 61058-1 and IEC 60447 (creepage and clearances for 4kV transient voltage)
- Be situated close to the equipment for ease of accessibility, and in a position where the operator can turn it off in an emergency without leaning over the machine.
- Marked as the disconnection device for this equipment
- Disconnect device off-position should be clearly marked (O) and the on-position should be marked (I)
- Hard wiring power cable to disconnect switch is recommended. Use of an electrical plug is not recommended.

## Electrical connections

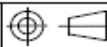Model	Conductor	Color and Marking
<b>IWPRO60</b> (208 V AC 3P+PE) supplied with 6 ft (1.8 m) 4-core power cable.	Protective earth	Green/Yellow
	Live 1	Black 1
	Live 2	Black 2
	Live 3	Black 3

## Electrical power supply requirements:

Requirement	Model
	<b>IWPRO60</b>
Electrical supply voltage	200-230 V AC 3P+PE (Three-phase and protective earth) Frequency: 60 Hz
Supply current	Site Current Capacity Current Capacity: $\geq 48$ A per phase Dedicated circuit is required with a minimum circuit breaker rating of 63A or greater. Refer to local codes
Electrical power requirement	18 kW
Allowable supply voltage fluctuation	$\pm 10\%$ of nominal voltage
Over-voltage category II	Transient over-voltages typically present on mains supply

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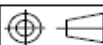
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# WinnMed

Electrical connections		
Model	Conductor	Color and Marking
IW532055NPR(380-415VAC 3P+N+PE) supplied with 9.84 ft (3 m) 5-core power cable	Protective earth	Green/Yellow
	Live 1	Brown
	Live 2	Black
	Live 3	Grey
	Neutral	Blue

Electrical power supply requirements:	
Requirement	Model
	IW532055NPR
Electrical supply voltage	380V-415V 3P+N+PE (Three-phase, neutral and protective earth) Frequency: 50 Hz
Supply current	Site Current Capacity: >33 A per phase Dedicated circuit is required with a circuit breaker rating of 40A or greater. Refer to local codes.
Electrical power requirement	22 kW
Allowable supply voltage fluctuation	±10% of nominal voltage
Over-voltage category II	Transient over-voltages typically present on mains supply

## Typical power consumption per wash

Power consumption will vary depending on cycle settings and temperature of inlet water supply. The power consumption below describes complete wash cycle at +104 °F (+40 °C).

Maximum power consumption for complete wash cycle	
Phase	Power consumption kWh
Pre-wash	11.9
Wash	2.6
Rinse 1	0.6
Rinse 2	0.6
Disinfection	3.6
Total power consumption	9.3




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InnoWave Pro, Equipment Specification Built after SN 11189855522  
and up to 0922 2027900 and WITHOUT internal drain cooling.

SIZE:  
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SCALE:  
NTS



DRAWN BY:  
TJ

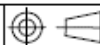DRAWING NUMBER:  
11393356

PART NUMBER:  
11018262

REVISION:  
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SHEET  
9B OF 10

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## Operating / Working environment location requirements

General and environmental requirements

Proposed operating location for unit must meet or exceed following requirements

Description	Requirements
Operating surface	On level floor, capable of supporting a weight of at least 1200 lb (545 kg).
Location requirement Altitude	Indoors only, altitude up to 6562 ft (2000 m)
Ambient operating temperature range	+41 °F to 104 °F (+5 °C to 40 °C)
Maximum humidity	80% relative humidity for up to +88 °F (+31 °C) decreasing linearly to 50% relative humidity at +104 °F (+40 °C)
Site services	Within 6 ft (1.8 m) of electrical isolator. Within 6 ft (1.8 m) of hot and cold water connections. Within 3 ft (1.0 m) of external site drain for effluent.
Ambient lighting	500 lux (46.5 foot-candle) minimum room lighting
Noise generated during operation	69 dBA at distance of 6 ft (1.8 m) from front of unit
Heat output during operation	7200 BTU/hr during cycle

## Shipping Information

Shipping crate dimensions and weight		
Shipping crate height	59.1 in.	1501 mm
Shipping crate width	59.5 in.	1511 mm
Shipping crate depth	45.3 in.	1151 mm
Shipping crate gross weight	1135 lb	515 kg

Transportation and storage:


Make sure package marking instructions and environmental conditions are always followed during transport and storage of InnoWave™ Pro.

Lifting:

Lifting and maneuvering the InnoWave™ Pro in shipping crate must be done with pallet truck or forklift truck able to carry load in excess of 1135 lb (515 kg).

Storage markings:

The markings on shipping crate stipulate unit's storage conditions and handling information.

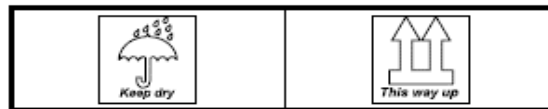


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InnoWave Pro, Equipment Specification Built after SN 11189855522 and up to 0922 2027900 and WITHOUT internal drain cooling.

SIZE:  
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SHEET  
10 OF 10

# WinnMed

WinnMed

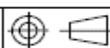Issue Date:

3/6/2024

Expansion and Renovation

Decorah, IA 52101

Furniture Specifications

CONTACT:

Ben Stevens - CFO

PHONE NUMBER:

563-387-3109

ITEM NUMBER:

4

ITEM NAME:

Rack Washer/Disinfector

ROOM NUMBER:

QUANTITY:

## SPECIFICATION INFORMATION

MANUFACTURER:

Steris

MODEL #:

FH19042

DIMENSIONS:

42" W x 40" D x 80.75" H

DESCRIPTION:

Washer/Disinfector, 460-480V, 3 Phase, 60 Hz, Steam heated, 15 DIN/10 US tray capacity; daVinci instrument compatible

## FURNITURE & EQUIPMENT IMAGE






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## TYPICAL INSTALLATION




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EQUIPMENT DRAWING OF  
AMSCO® 7053HP SINGLE-CHAMBER WASHER/DISINFECTOR  
STEAM HEATED, W/O ACU-RINSE RES., UNIT FLUSH TO WALL

SIZE:  
A

SCALE:  
N/A

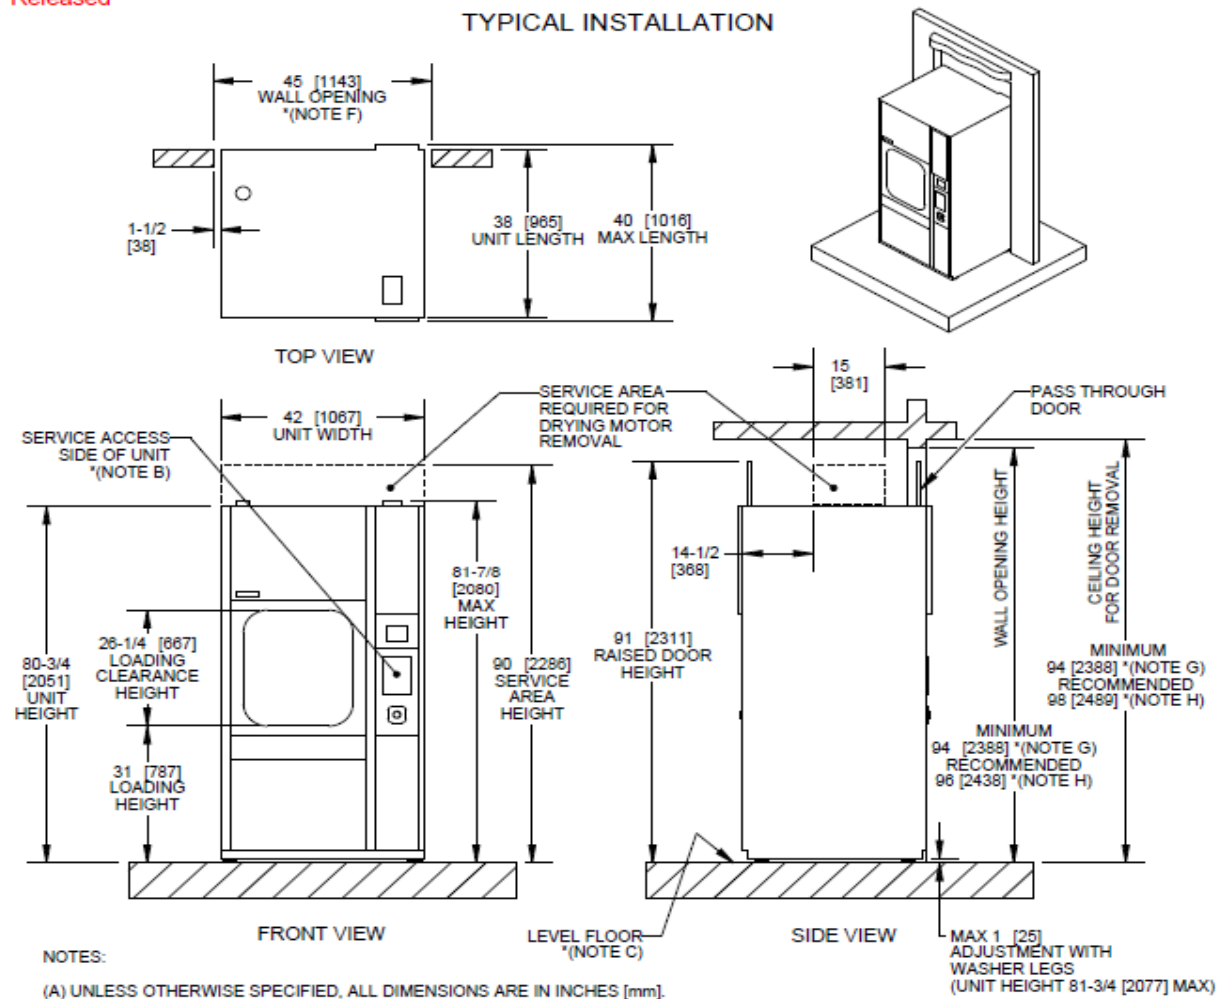

DRAWN BY:  
Jean Tanguay

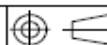DRAWING NUMBER:  
10288795

PART NUMBER  
& REVISION

Page 1 of 10


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## SEISMIC MOUNTS



### \*NOTES:

- (A) CONCRETE FLOOR MUST REMAIN FREE OF DEFECTS IN THESE AREA, AS PER ESR-1917 & ESR-3187.  
 (B) THE FLOOR SINK AND DRAIN SHALL NOT OCCUPY THESE AREAS. 5 in x 5 in [127 mm x 127 mm] FLOOR SINK WITH Ø4 in [102 mm] DRAIN IS RECOMMENDED WHEN USING SEISMIC MOUNTS.

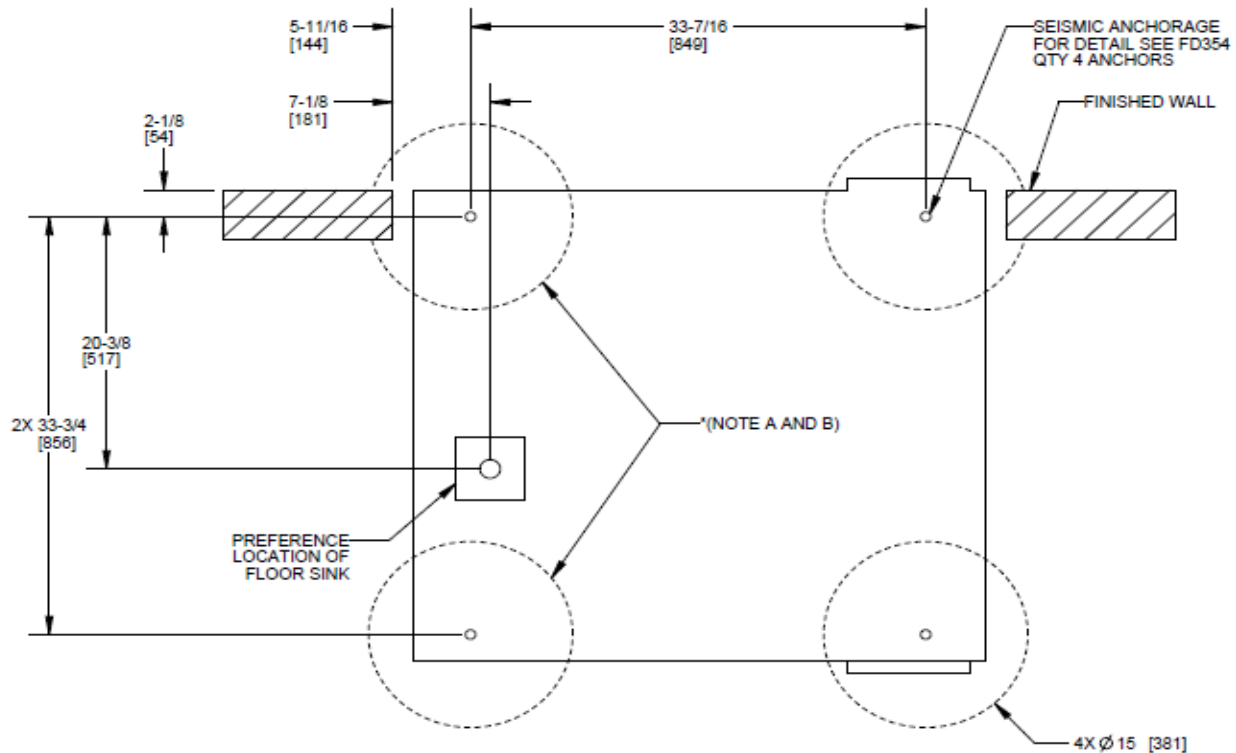


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EQUIPMENT DRAWING OF  
 AMSCO® 7053HP SINGLE-CHAMBER WASHER/DISINFECTOR  
 STEAM HEATED, W/O ACU-RINSE RES., UNIT FLUSH TO WALL

SIZE:  
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SCALE:  
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DRAWN BY:  
Jean Tanguay

DRAWING NUMBER:  
10288795

PART NUMBER  
& REVISION

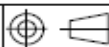
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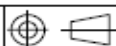


TITLE

EQUIPMENT DRAWING OF  
AMSCO® 7053HP SINGLE-CHAMBER WASHER/DISINFECTOR  
STEAM HEATED, W/O ACU-RINSE RES., UNIT FLUSH TO WALL

SIZE:  
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SCALE:  
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Page 3 of 10


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## UTILITY (ELECTRICITY) CONNECTION POSITION

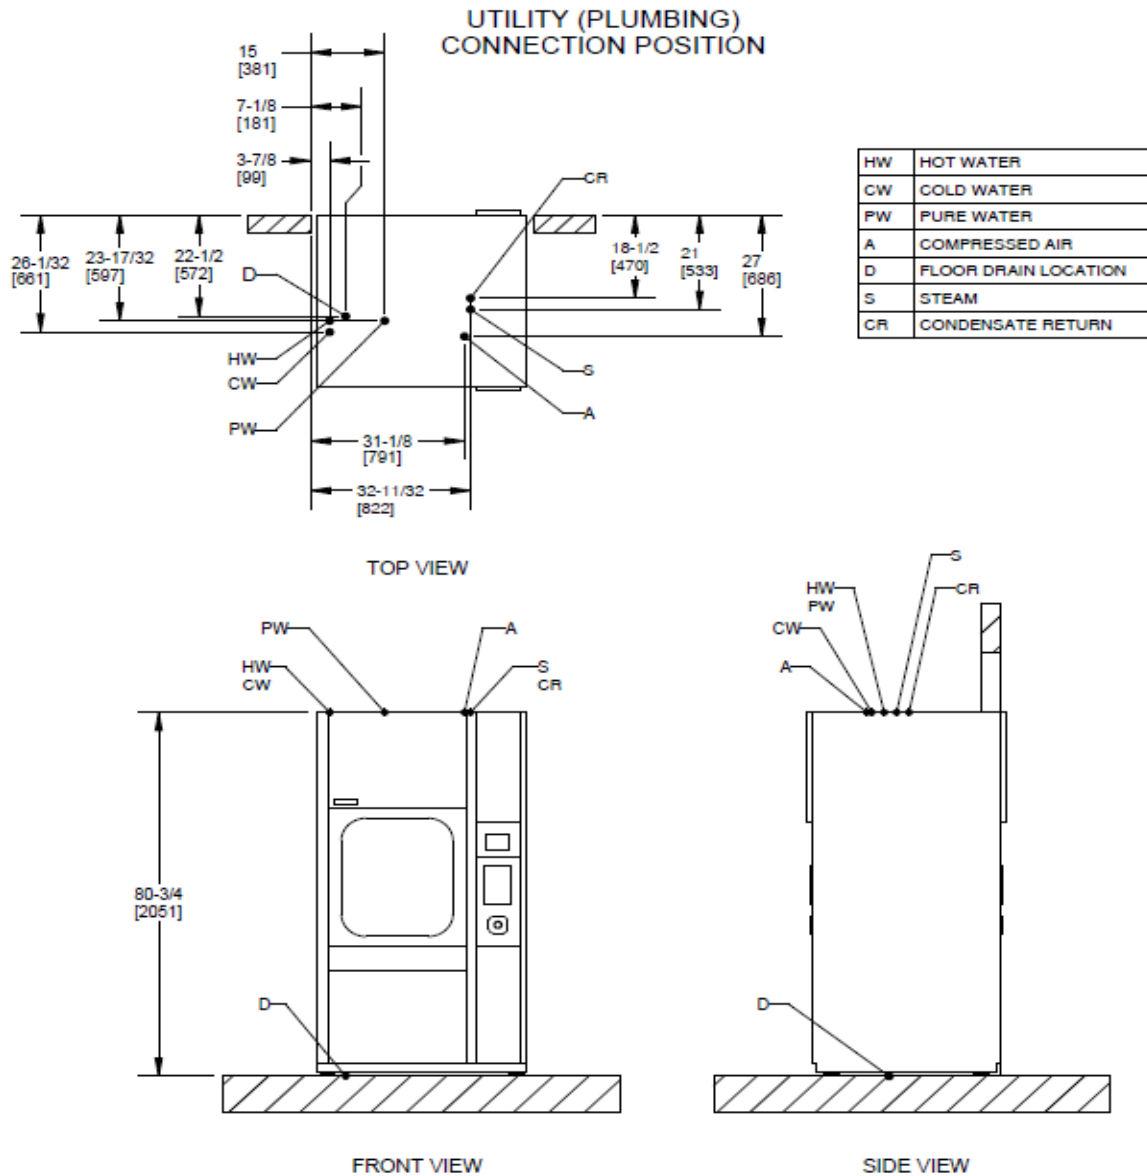


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EQUIPMENT DRAWING OF  
AMSCO® 7053HP SINGLE-CHAMBER WASHER/DISINFECTOR  
STEAM HEATED, W/O ACU-RINSE RES., UNIT FLUSH TO WALL

SIZE:  
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SCALE:  
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DRAWN BY:  
Jean Tanguay

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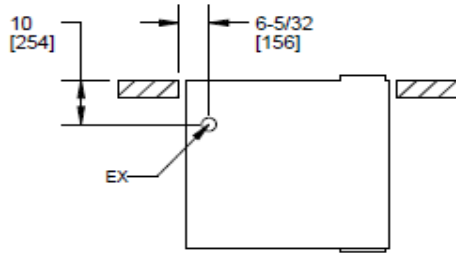
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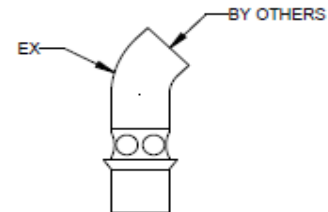
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## UTILITY (VENTILATION) CONNECTION POSITION (OPTIONAL)

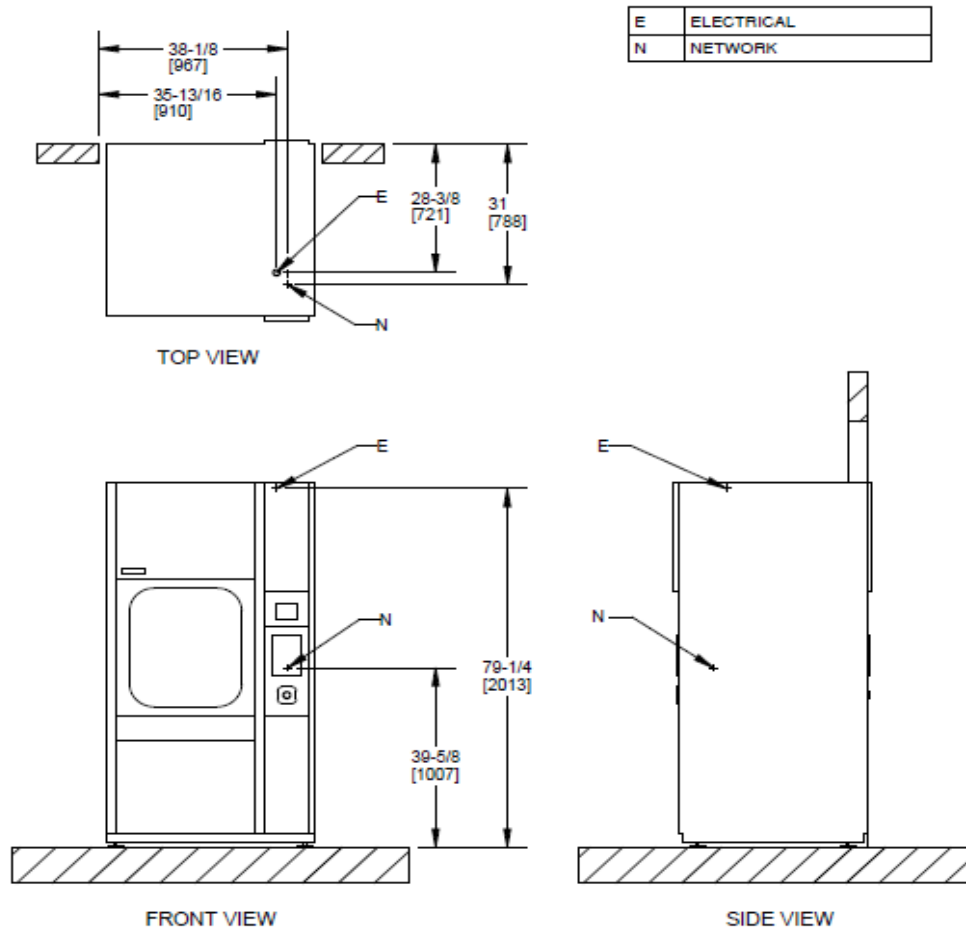


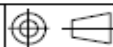TOP VIEW


EX VENTILATION EXHAUST



VENTILATION CONNECTION (OPTIONAL)  
(SEE PAGE 9 (NOTE 1))  
DRY CONTACT (SEE PAGE 10 (NOTE 3))

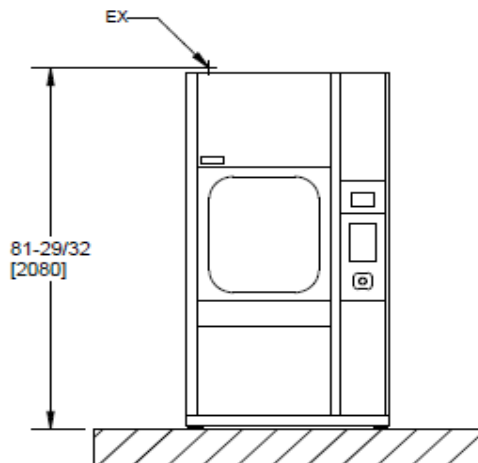

FRONT VIEW

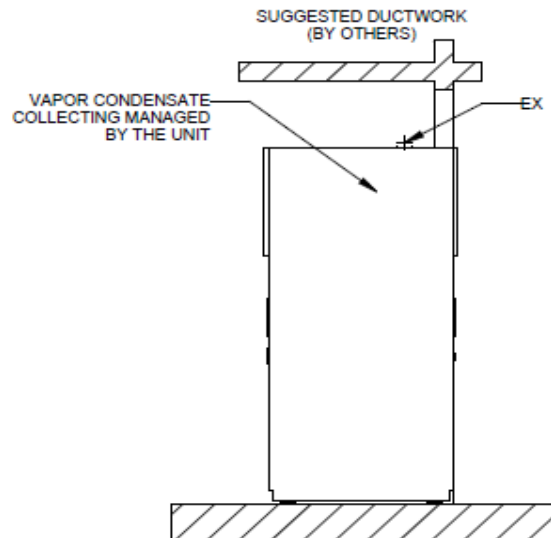

SIDE VIEW


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EQUIPMENT DRAWING OF  
AMSCO® 7053HP SINGLE-CHAMBER WASHER/DISINFECTOR  
STEAM HEATED, W/O ACU-RINSE RES., UNIT FLUSH TO WALL

SIZE:  
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SCALE:  
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Jean Tanguay

DRAWING NUMBER:  
10288795

PART NUMBER  
& REVISION

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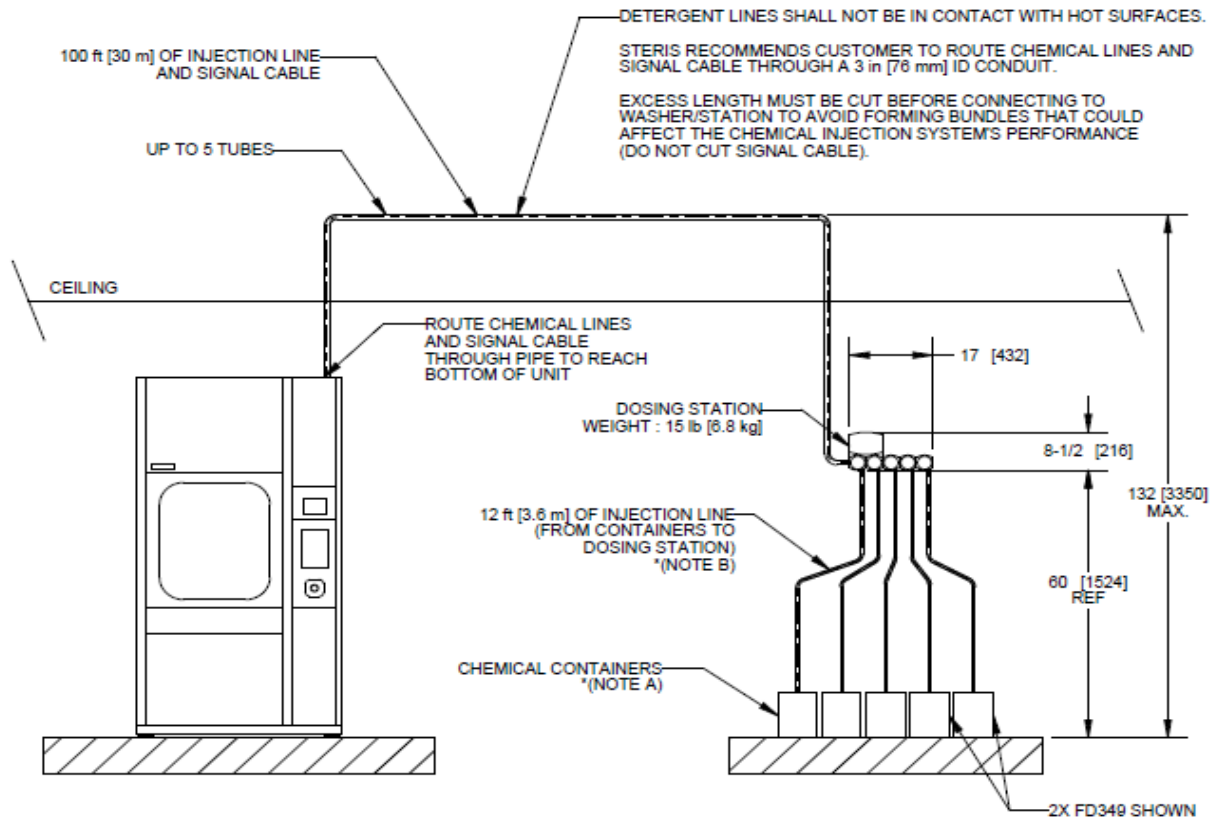
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## DOSING STATION

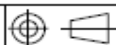

### \*NOTES:

- (A) DOSING STATION AND CHEMICAL CONTAINERS MUST BE ON THE SAME FLOOR OF THE BUILDING AS THE WASHER/DISINFECTOR. CHEMICAL CONTAINER MUST BE LOCATED AT A LOWER HEIGHT THAN DOSING STATION. MAXIMUM CONTAINER INCLINATION IS 15 DEG FROM FLOOR. AMBIENT TEMPERATURE SHALL NOT EXCEED 32 °C [90 °F]
- (B) HP PICKUP TUBE SYSTEM CAN PROVIDE UP TO TWO WASHERS WITH CHEMISTRY FROM THE SAME CONTAINER.

CHEMICAL (CH)	INSTRUMENT (With PUC HP)		UTENSIL (With PUC HP)	
	ENZYME CONSUMPTION PER CYCLE (SEE PAGE 7; *(NOTE 4))	0.74 oz [22 ml]	0.74 oz [22 ml]	0.74 oz [22 ml]
	DETERGENT CONSUMPTION PER CYCLE (SEE PAGE 7; *(NOTE 4))	0.74 oz [22 ml]	0.74 oz [22 ml]	0.74 oz [22 ml]
	LUBRICANT CONSUMPTION PER CYCLE (SEE PAGE 7; *(NOTE 4))	0.2 oz [6 ml]	N/A	N/A




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EQUIPMENT DRAWING OF  
AMSCO® 7053HP SINGLE-CHAMBER WASHER/DISINFECTOR  
STEAM HEATED, W/O ACU-RINSE RES., UNIT FLUSH TO WALL

SIZE:  
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SCALE:  
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DRAWN BY:  
Jean Tanguay

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& REVISION


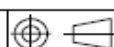
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Released		UTILITY REQUIREMENTS CHART (PLUMBING)					
UTILITY	PARAMETER	REQUIREMENT	✓	NOTES			
HOT WATER (HW)	CONNECTION SIZE / TYPE	1/2 in / FEMALE NPT [1/2 in / MALE BSPT]		1. STERIS REQUIRES TO INSTALL WATER HAMMER ARRESTOR, UNION & PRESSURE GAUGE.  2. CUSTOMER MUST PROVIDE UTILITY CONNECTIONS WITH SHUTOFFS/DISCONNECTS WITHIN 2 FEET OF THE PERIMETER OF THE EQUIPMENT AND BELOW THE CEILING DECK. *STERIS OFFERS FLEXIBLE HOSES ACCESSORY (FD088 OR FD037) WITH INSTRUCTIONS.  3. SAMPLING VALVES INSTALLATION AS CLOSE AS POSSIBLE TO WASHER WATER CONNECTION IS RECOMMENDED.			
	PRESSURE RANGE	15 - 50 psig DYNAMIC [103-345 kPa] MAX. 90 psig STATIC [620 kPa]					
	OPERATING FLOW RATE	6.8 US GPM [25.7 L/min] TO 14.1 US GPM [53.4 L/min]					
	TOTAL CONSUMPTION PER INSTRUMENT CYCLE *(NOTE 4)	9.9 US GAL [37.5 L]  WITH ACU-WASH RESERVOIR: 6.6 US GAL [25.0 L]					
	TEMPERATURE RANGE	110 °F [43 °C] TO 150 °F [65.5 °C]					
	WATER QUALITY *(NOTE 5)	HARDNESS (CaCO <sub>3</sub> ) : 50-80 ppm (MAX. 120 ppm)					
COLD WATER (CW) *(NOTES 6)	CONNECTION SIZE / TYPE	1/2 in / FEMALE NPT [1/2 in / MALE BSPT]		4. CONSUMPTION BASED ON INSTRUMENT CYCLE WITH PROLYSTICA ULTRA CONCENTRATE HIGH PERFORMANCE CHEMICALS (PUC HP) WITH THE FOLLOWING UTILITY CONDITIONS:  THREE-LEVEL MANIFOLD RACK (CW) COLD WATER PRESSURE: 30 psig DYNAMIC [207 kPa] (CW) COLD WATER TEMPERATURE: 70 °F [21 °C] (HW) HOT WATER TEMPERATURE: 150 °F [65 °C] (PW) PURE WATER TEMPERATURE 70 °F [21 °C] (S) STEAM SUPPLY: 80 psig DYNAMIC [552 kPa]  UTENSIL CYCLE CONSUMPTION: TWO-LEVEL MANIFOLD RACK CW: 10.4 US GAL [39.4 L] HW: 9.6 US GAL [36.3 L] PW: 6.4 US GAL [24.2 L] S: 19.3 lb [8.8 kg]			
	PRESSURE RANGE	30 - 50 psig DYNAMIC [206-345 kPa] MAX. 90 psig STATIC [620 kPa]					
	OPERATING FLOW RATE	10.7 US GPM [40.5 L/min] TO 14.1 US GPM [53.4 L/min]					
	TOTAL CONSUMPTION PER INSTRUMENT CYCLE *(NOTE 4)	FOR SUMP FILLING: 18.9 US GAL [71.5 L] (ADD THE FOLLOWING CONSUMPTION FOR OPTIONS/CONFIGURATIONS)  CONDENSATE RETURN COOL DOWN: 8.1 US GAL [30.7 L] NON-VENTED SYSTEM: 13.3 US GAL [50.3 L] DRAIN COOLDOWN: 15.8 US GAL [59.8 L] DRAIN ACU-COOLDOWN: 12.1 US GAL [45.8 L]					
	TEMPERATURE RANGE	70 °F [21 °C] MAXIMUM					
	WATER QUALITY *(NOTE 5)	HARDNESS (CaCO <sub>3</sub> ) : 50-80 ppm (MAX. 120 ppm)					
PURE WATER (PW)	CONNECTION SIZE / TYPE	1/2 in / FEMALE NPT [1/2 in / MALE BSPT]		6. BACK FLOW PREVENTER AGAINST BACK SIPHONAGE MAY BE REQUIRED (LOCAL PLUMBING CODE)  7. PW IS OPTIONAL. IF UNAVAILABLE, UNIT WILL PROCESS THERMAL RINSE USING HOT WATER SUPPLY.			
	PRESSURE RANGE	5 - 30 psig DYNAMIC [30 - 206 kPa] MAX. 90 psig STATIC [620 kPa]					
	OPERATING FLOW RATE	5.5 US GPM [21 L/min] TO 12.6 US GPM [48 L/min]					
	TOTAL CONSUMPTION PER INSTRUMENT CYCLE *(NOTE 4 AND NOTE 7)	6.6 US GAL [25.0 L]					
	TEMPERATURE RANGE	70 °F [21.1 °C] TO 150 °F [65.5 °C]					
	RESISTIVITY (CONDUCTIVITY)	0.1-0.5 MΩ -cm (2-10 µS/cm)					
	pH	6.8 - 7.5					
		EQUIPMENT DRAWING OF					
		AMSCO® 7053HP SINGLE-CHAMBER WASHER/DISINFECTOR					
		STEAM HEATED, W/O ACU-RINSE RES., UNIT FLUSH TO WALL					
SIZE: A SCALE: N/A 		DRAWN BY: Jean Tanguay		DRAWING NUMBER: 10288795			
Page 7 of 10					PART NUMBER & REVISION 10288795.D		
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## UTILITY REQUIREMENTS CHART (PLUMBING)

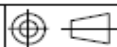UTILITY	PARAMETER	REQUIREMENT	✓	NOTES
COMPRESSED AIR (A)	CONNECTION SIZE / TYPE	1/8 in / FEMALE NPT [1/8 in / MALE BSPT]		1. AIR PURITY PER ISO-8573-1: 2010 [7:4:4] MAX. PARTICLE DENSITY: 10 mg/m <sup>3</sup> MAX. DEW POINT FOR WATER CONTENT: 37 °F [3 °C] MAX. OIL CONCENTRATION FOR THE OIL CONTENT: 5 mg/m <sup>3</sup>
	PRESSURE RANGE	MIN 80 psig DYNAMIC [552 kPa] MAX. 125 psig STATIC [860 kPa]		2. STERIS RECOMMENDS A REFRIGERATED AIR DRYER WHERE ENVIRONMENTAL DEW POINT CONDITIONS ARE HIGHER THAN RECOMMENDED.
	OPERATING FLOW RATE	1.75 SCFM [50 L/min]		3. CUSTOMER MUST PROVIDE UTILITY CONNECTIONS WITH SHUTOFFS DISCONNECTS WITHIN 2 FEET OF THE PERIMETER OF THE EQUIPMENT AND BELOW THE CEILING DECK.
DRAIN (D)	FLOOR DRAIN SIZE	MIN 4 in [102 mm] O.D. WITH 8 in x 8 in [204 mm x 204 mm] FLOOR SINK		4. WASHER DRAIN OUTLET SIZE 1-1/2 in / MALE NPT 5. MAX OFFSET OF ± 3/4 in [19 mm] FROM OUTLET (PAGE 3, D). 6. FOR DRAIN REQUIREMENTS WHEN USING SEISMIC MOUNTS, SEE PAGE 2.
	OPERATING FLOW RATE	GRAVITY DRAIN : 50 US GPM [189.3 L/min]		
STEAM INLET (S)	CONNECTION SIZE / TYPE	1/2 in / FEMALE NPT [1/2 in / MALE BSPT]		7. STERIS REQUIRES AT LEAST 97% SATURATED DRY PLANT STEAM, FREE OF DIRT, RESIDUES AND CONTAMINANTS.
	PRESSURE RANGE	30 - 80 psig DYNAMIC [206-552 kPa] MAX. 90 psig STATIC [620 kPa]		8. STERIS RECOMMENDS TO INSTALL A STEAM TRAP AS CLOSE AS POSSIBLE TO UNIT CONNECTION.
	OPERATING MASS FLOW RATE	169 lb/h [76.5 kg/h] AT 30 psig [207 kPa] 271 lb/h [123 kg/h] AT 80 psig [550 kPa]		9. PROPER OPERATION OF THE WASHER REQUIRES A MINIMUM PRESSURE DIFFERENTIAL OF 21.5 psig [148 kPa] BETWEEN STEAM INLET AND CONDENSATE RETURN. IN CASES OF LOW STEAM INLET PRESSURE, CONDENSATE CAN BE ROUTED TO DRAIN TO INCREASE DIFFERENTIAL.
	TOTAL CONSUMPTION PER INSTRUMENT CYCLE (SEE PAGE 7, *(NOTE 4))	19.3 lb [8.8 kg]		*STERIS OFFERS CONDENSATE RETURN TO DRAIN ACCESSORY (FD353)
CONDENSATE RETURN (CR)	PRESSURE RANGE	MAX. 8.5 psig [68.9 kPa] BACK PRESSURE (17 ft [5.2 m] ELEVATION)		10. CUSTOMER MUST PROVIDE UTILITY CONNECTIONS WITH SHUTOFFS DISCONNECTS WITHIN 2 FEET OF THE PERIMETER OF THE EQUIPMENT AND BELOW THE CEILING DECK.
	OPERATING FLOW RATE	PEAK : 0.54 US GPM [2.05 L/min]		
	CONNECTION SIZE / TYPE	1/2 in / FEMALE NPT [1/2 in / MALE BSPT]		
CHEMICAL DOSING SYSTEM	CEILING ROUTING CONDUIT	3 in CONDUIT		11. STERIS RECOMMENDS TO ROUTE CHEMICAL LINES AND SIGNAL CABLE THROUGH A 3 in [76 mm] ID CONDUIT (BY OTHERS). 100 ft [30 m] OF INJECTION LINE AND SIGNAL CABLE ARE PROVIDED WITH THE UNIT.




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EQUIPMENT DRAWING OF  
AMSCO® 7053HP SINGLE-CHAMBER WASHER/DISINFECTOR  
STEAM HEATED, W/O ACU-RINSE RES., UNIT FLUSH TO WALL

SIZE:  
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SCALE:  
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DRAWN BY:  
Jean Tanguay

DRAWING NUMBER:  
10288795

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## UTILITY REQUIREMENTS CHART (ELECTRIC)

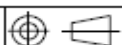UTILITY		PARAMETER AND REQUIREMENT			NOTES
		CONNECTION SIZE/TYPE	NOMINAL AMPERAGE	RECOMMENDED CIRCUIT	
ELECTRICITY (EL)	200-208V 60 Hz, 3-Ph	1 in [27 mm] 1-1/4 in [35 mm] CONDUIT	36 A	50 A	1. ALL CONNECTIONS SHOULD BE IN ACCORDANCE WITH LOCAL CODES. 2. NEUTRAL WIRE NOT REQUIRED. 3. ALWAYS FOLLOW LOCAL ELECTRICAL CODES AND SAFETY-RELATED WORK PRACTICES TO DETERMINE THE VALUE OF PROTECTION. 4. WIRING ON THE EQUIPMENT TERMINATES AT A JUNCTION BOX. WIRING BETWEEN JUNCTION BOX AND BUILDING SERVICE LINES ARE NOT SUPPLIED BY STERIS. 5. DISCONNECT SWITCHES WITH OFF POSITION LOCKOUT (SUPPLIED BY OTHERS) MUST BE INSTALLED IN ELECTRIC SUPPLY LINES NEAR THE EQUIPMENT. 6. STERIS RECOMMENDS A LIGHT IN SERVICE AREA.
	200-208V 60 Hz, 3-Ph WITH 40A MIN. CIRCUIT PROTECTION	1 in [27 mm] 1-1/4 in [35 mm] CONDUIT	28.5 A	40 A	
	200-208V 50 Hz, 3-Ph	1 in [27 mm] 1-1/4 in [35 mm] CONDUIT	35 A	50 A	
	460-480V 60 Hz, 3-Ph	1 in [27 mm] 1-1/4 in [35 mm] CONDUIT	16.5 A	30 A	
	380-400V 60 Hz, 3-Ph	1 in [27 mm] 1-1/4 in [35 mm] CONDUIT	19 A	30 A	
	380-400-415V 50 Hz, 3-Ph	1 in [27 mm] 1-1/4 in [35 mm] CONDUIT	18.5 A	30 A	
NETWORK (N) OPTIONAL		100/1000 BASE T SUPPORTING TCP/IP PROTOCOL RJ45F CONNECTION			7. NETWORK CONNECTION (IF APPLICABLE) - ACTIVE NETWORK DROP WITH CAT 5/6 CABLE WITHIN 10 ft [3 m] OF UNIT - STATIC OR DHCP RESERVED IP ADDRESS (FOR EACH UNIT) - NETWORK CABLE (SUPPLIED BY OTHER)




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EQUIPMENT DRAWING OF  
AMSCO® 7053HP SINGLE-CHAMBER WASHER/DISINFECTOR  
STEAM HEATED, W/O ACU-RINSE RES., UNIT FLUSH TO WALL

SIZE:  
A

SCALE:  
N/A

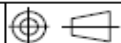

DRAWN BY:  
Jean Tanguay

DRAWING NUMBER:  
10288795

PART NUMBER  
& REVISION

Page 9 of 10

10288795.D

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# WinnMed

Released

## UTILITY REQUIREMENTS CHART

UTILITY	PARAMETER	REQUIREMENT	✓	NOTES
VENTILATION EXHAUST (EX) OPTIONAL	CONNECTION SIZE	3 in [76 mm] OUTSIDE DIAMETER		1. NOT REQUIRED WITH NON VENTED UNIT.
	PRESSURE RANGE	1/2 in [50 mm] VACUUM AT CONNECTION		2. STERIS REQUIRES CORROSION-RESISTANT AND WATER-TIGHT DUCT: - MIN OPERATING TEMPERATURE 210 °F [99 °C] - SLOPED TOWARDS THE WASHER AND NO DEAD LEGS - INSTALL DRAIN PART AT LOWEST POINT NEAR UNIT
	OPERATING FLOW RATE	60 SCFM [1.7 m³/min]		3. EXHAUST FAN NORMALLY OPEN-AUXILIARY CONTACTS IS AVAILABLE TO SUPPLY A SIGNAL TO THE FACILITY HVAC CONTROL SYSTEM WHENEVER THE WASHER VENTILATION EXHAUST FAN IS IN OPERATION.
	TEMPERATURE RANGE	MAX. 240 °F [116 °C]		

## PHYSICAL SPECIFICATIONS

SHIPPING DIMENSION W x H x L	50 in x 91 in x 48 in [1270 mm x 2311 mm x 1219 mm]	1. LEVELING FEET ARE PROVIDED FOR PROPER INSTALLATION.
SHIPPING WEIGHT	1350 lb [612 kg]	2. PERMISSIBLE ENVIRONMENTAL CONDITIONS. THIS EQUIPMENT IS DESIGNED TO GIVE OPTIMAL RESULTS UNDER THE FOLLOWING CONDITIONS: - INDOOR USE ONLY; - ALTITUDE OF OPERATION UP TO 6562 ft [2000 m]; - TEMPERATURE OF 41 TO 104 °F [5 to 40 °C]; - MAXIMUM RELATIVE HUMIDITY IS 80% FOR TEMPERATURE UP TO 88 °F [31 °C], DECREASING LINEARLY TO 50% RELATIVE HUMIDITY AT 104 °F [40 °C]; - POLLUTION DEGREE 2: EQUIPMENT MUST BE INSTALLED IN AN ENVIRONMENT WHERE NORMALLY ONLY NON-CONDUCTIVE POLLUTION OCCURS BUT WHERE OCCASIONAL, TEMPORARY CONDUCTIVITY CAUSED BY CONDENSATION CAN BE EXPECTED (AS DETERMINED ACCORDING TO INTERNATIONAL STANDARD EN/IEC 61010-1).
OPERATING DIMENSION W x H x L	42 in x 80.75 in x 38 in [1067 mm x 2051 mm x 965 mm]	3. STERIS ASSUMES NO RESPONSIBILITY FOR CHANGES MADE TO, OR FAILURE TO OBSERVE THE SPECIFICATIONS ON EQUIPMENT DRAWING AND NOTE PAGES. SPECIFICATIONS AND DESCRIPTIONS ARE SUBJECT TO CHANGE WITHOUT NOTICE.
OPERATING WEIGHT (WITH WATER AND FULLY LOADED)	1336 lb [606 kg]	
AVERAGE FLOOR LOAD OVER WASHER FOOTPRINT	0.84 psi [5.77 kPa]	4. OPENING AREA CAN BE REDUCED TO 13 in² [84 cm²] WITH INSTALLATION OF AIR MANAGEMENT PANELS ACCESSORY (FD352)
MAX. FLOOR LOAD AT WASHER FOOTPADS (3 in [76.2 mm] DIAMETER PADSD)	71 psi [491 kPa]	
NOISE LEVEL: A-WEIGHTED EQUIVALENT SURFACE SOUND PRESSURE LEVEL	60.6 dB(A) CALCULATED AS DESCRIBED IN ISO 3746.	
OPENING AREA FROM CLEAN SIDE TO SOILED SIDE	46.5 in² [300 cm²] *(NOTE 4)	
CHAMBER DIMENSION W x H x L VOLUME	26.5 in x 26.25 in x 31.5 in [673 mm x 667 mm x 800 mm] 12.7 ft³ [0.36 m³]	

## TYPICAL HEAT LOSS AT 75 °F [24 °C] CONTINUOUS OPERATION

	NON-VENTED UNIT WITHOUT ACU-RINSE RES.	VENTED UNIT (OPTIONAL) WITHOUT ACU-RINSE RES.
CLEAN SIDE	2186 Btu/h [640 W]	2186 Btu/h [640 W]
SOILED SIDE	7069 Btu/h [2070 W]	5259 Btu/h [1540 W]
TOTAL	9255 ± 854 Btu/h [2710 ± 250 W]	7445 ± 854 Btu/h [2180 ± 250 W]

VALUES INCLUDE HEAT LOSS DURING DOOR OPENING FOR LOADING AND UNLOADING OPERATIONS. "TOTAL" WILL VARY DEPENDING ON DISINFECTION TIME AND TEMPERATURE, DRYING TIME AND TEMPERATURE AND USE RATE OF UNIT. AN ADDITIONAL HEAT LOSS FOR LOAD COOL DOWN IN CLEAN SIDE CAN BE ADDED TO THE TOTAL HEAT LOSS OF THE WASHER: MAXIMUM 1713 Btu [1807 kJ]




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EQUIPMENT DRAWING OF  
AMSCO® 7053HP SINGLE-CHAMBER WASHER/DISINFECTOR  
STEAM HEATED, W/O ACU-RINSE RES., UNIT FLUSH TO WALL

SIZE:  
A

SCALE:  
N/A

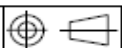

DRAWN BY:  
Jean Tanguay

DRAWING NUMBER:  
10288795

PART NUMBER  
& REVISION

Page 10 of 10

10288795.D

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# WinnMed

WinnMed

Issue Date:

3/6/2024

Expansion and Renovation

Decorah, IA 52101

Furniture Specifications

CONTACT:

Ben Stevens - CFO

PHONE NUMBER:

563-387-3109

ITEM NUMBER:	5
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ITEM NAME:	Auto Docking Transfer Cart		
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ROOM NUMBER:		QUANTITY:	
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SPECIFICATION INFORMATION	
---------------------------	--

MANUFACTURER: Steris

MODEL #: FD179

DIMENSIONS:

DESCRIPTION: Auto docking transfer cart for Long Chamber Washer/Disinfector; includes bottle collection kit

FURNITURE & EQUIPMENT IMAGE
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# WinnMed



# WinnMed

WinnMed

Issue Date:

3/6/2024

Expansion and Renovation

Decorah, IA 52101

Furniture Specifications

CONTACT:

Ben Stevens - CFO

PHONE NUMBER:

563-387-3109

ITEM NUMBER:	6
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ITEM NAME:	Work Table		
ROOM NUMBER:		QUANTITY:	


## SPECIFICATION INFORMATION

MANUFACTURER: Steris  
MODEL #: CG5  
DIMENSIONS: 36" W x 72" L x 26.5" - 41.5" H  
DESCRIPTION: Adjustable Height work table (no shelf or accessories); electric height adj; 120V; 15 A

## FURNITURE & EQUIPMENT IMAGE



# WinnMed

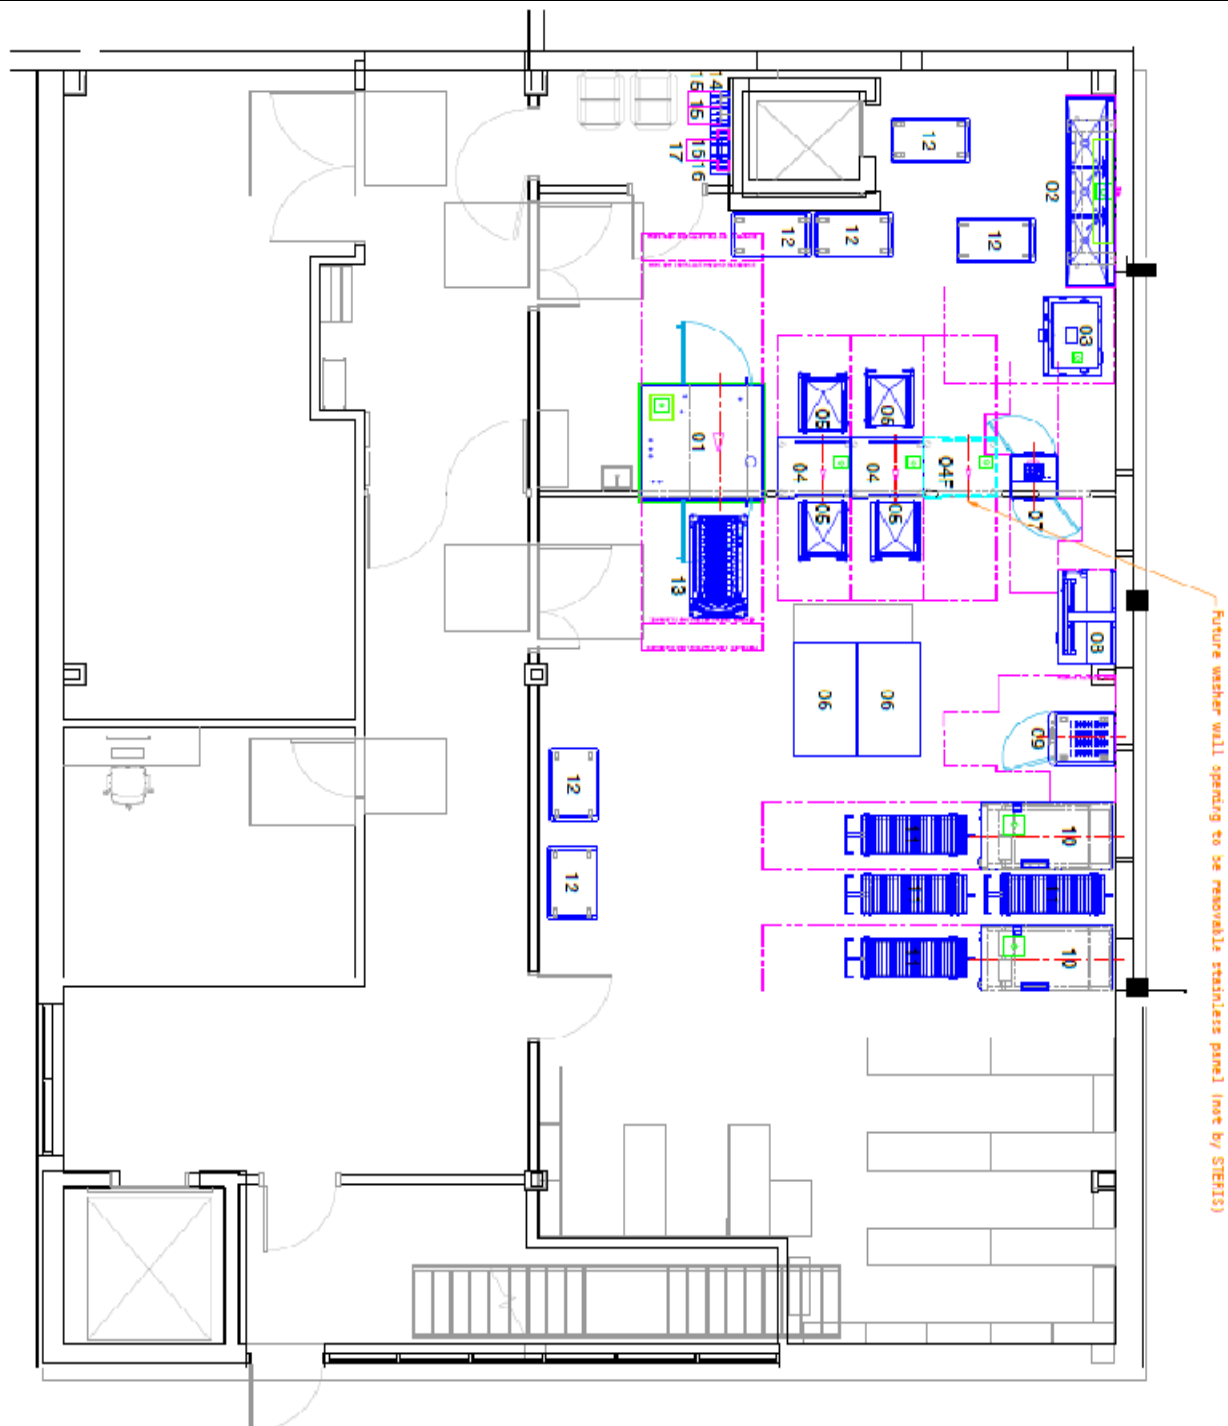



# WinnMed

WinnMed

Issue Date:

3/6/2024

Expansion and Renovation

Decorah, IA 52101

Furniture Specifications

CONTACT:

Ben Stevens - CFO

PHONE NUMBER:

563-387-3109

ITEM NUMBER:

7

ITEM NAME:

Drying Pass Through Cabinet

ROOM NUMBER:

QUANTITY:

## SPECIFICATION INFORMATION

MANUFACTURER:

Steris

MODEL #:

DCR101101XL

DIMENSIONS:

29" W x 27.5" D x 78.5" H

DESCRIPTION:


Drying cabinet; Qty 9 XL Full width shelves; pass through; two doors with inter-lockout design; touch screen controls; air purge system; trim kit included

## FURNITURE & EQUIPMENT IMAGE






# WinnMed

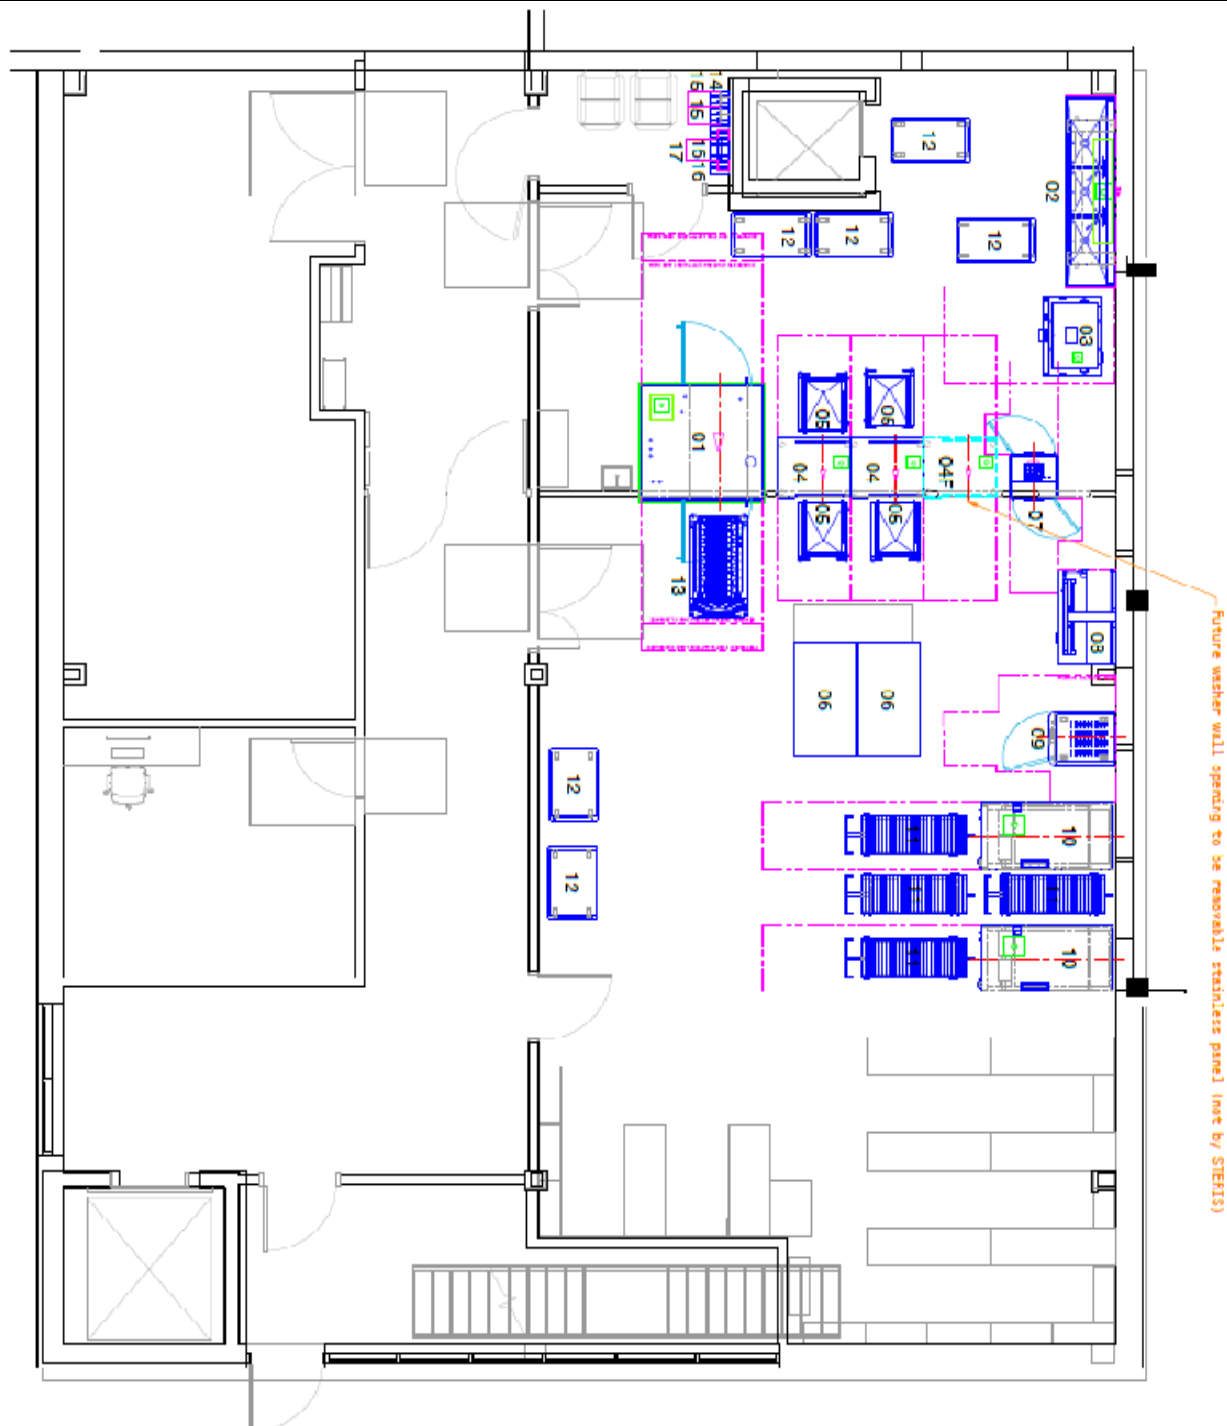

# WinnMed

## 29" DRYING CABINET TYPICAL INSTALLATION (FREESTANDING)

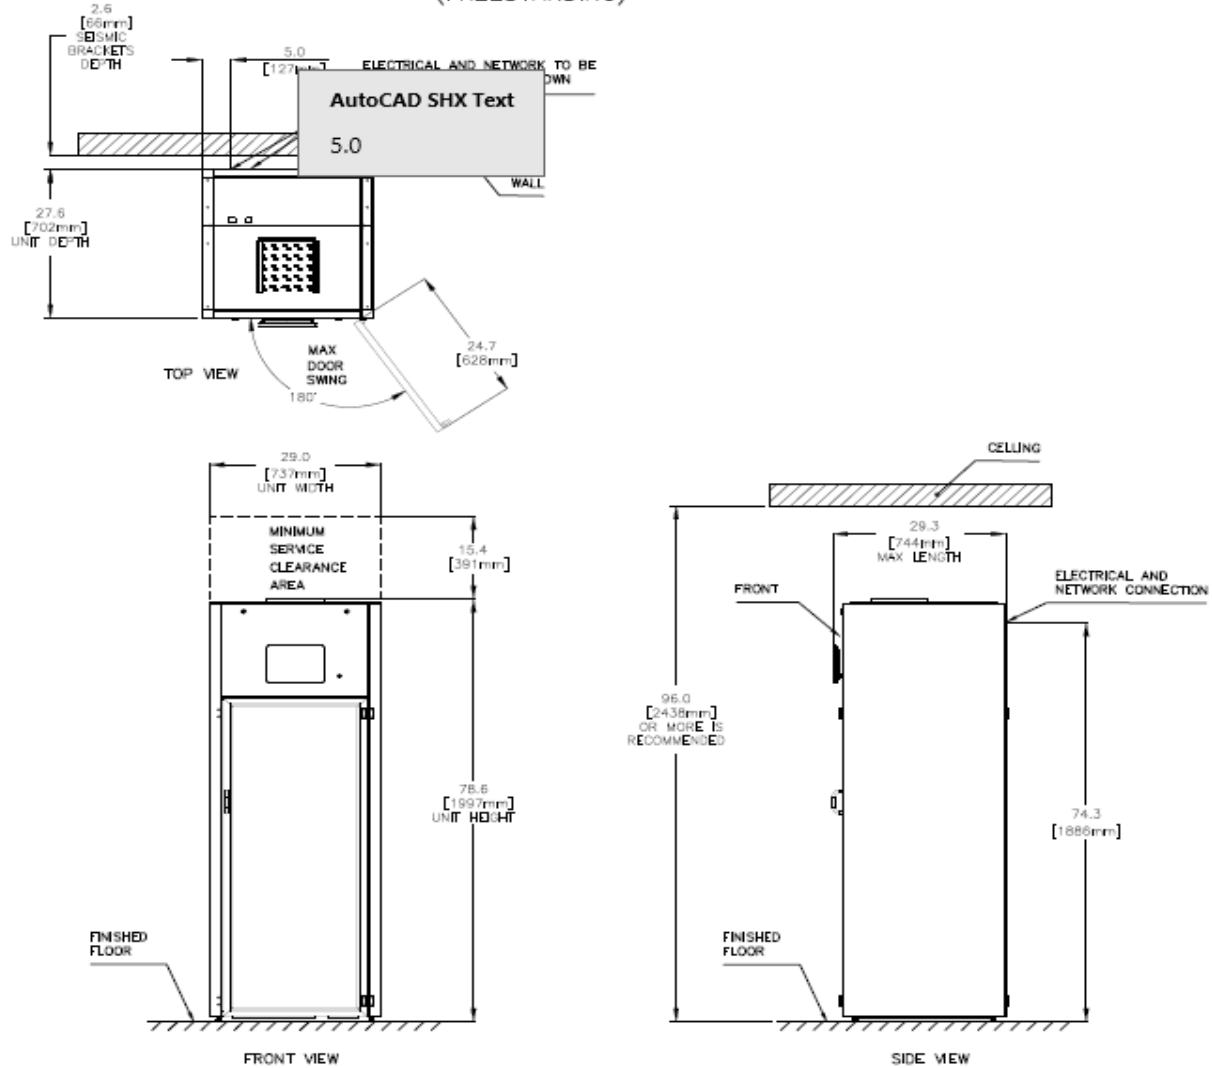


**STERIS**  
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### EQUIPMENT\_DRAWING AMSCO\_DRYING\_CABINET\_29" INSTALLATION

SIZE:  
**A**

SCALE:  
**NTS**



DRAWN BY:  
**TYLER BASCH**

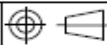DRAWING NUMBER:  
**11003253**


PART NUMBER:  
**11003253**

REVISION:  
**B**

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SHEET  
**1 OF 6**

## 38" DRYING CABINET TYPICAL INSTALLATION (FREESTANDING)

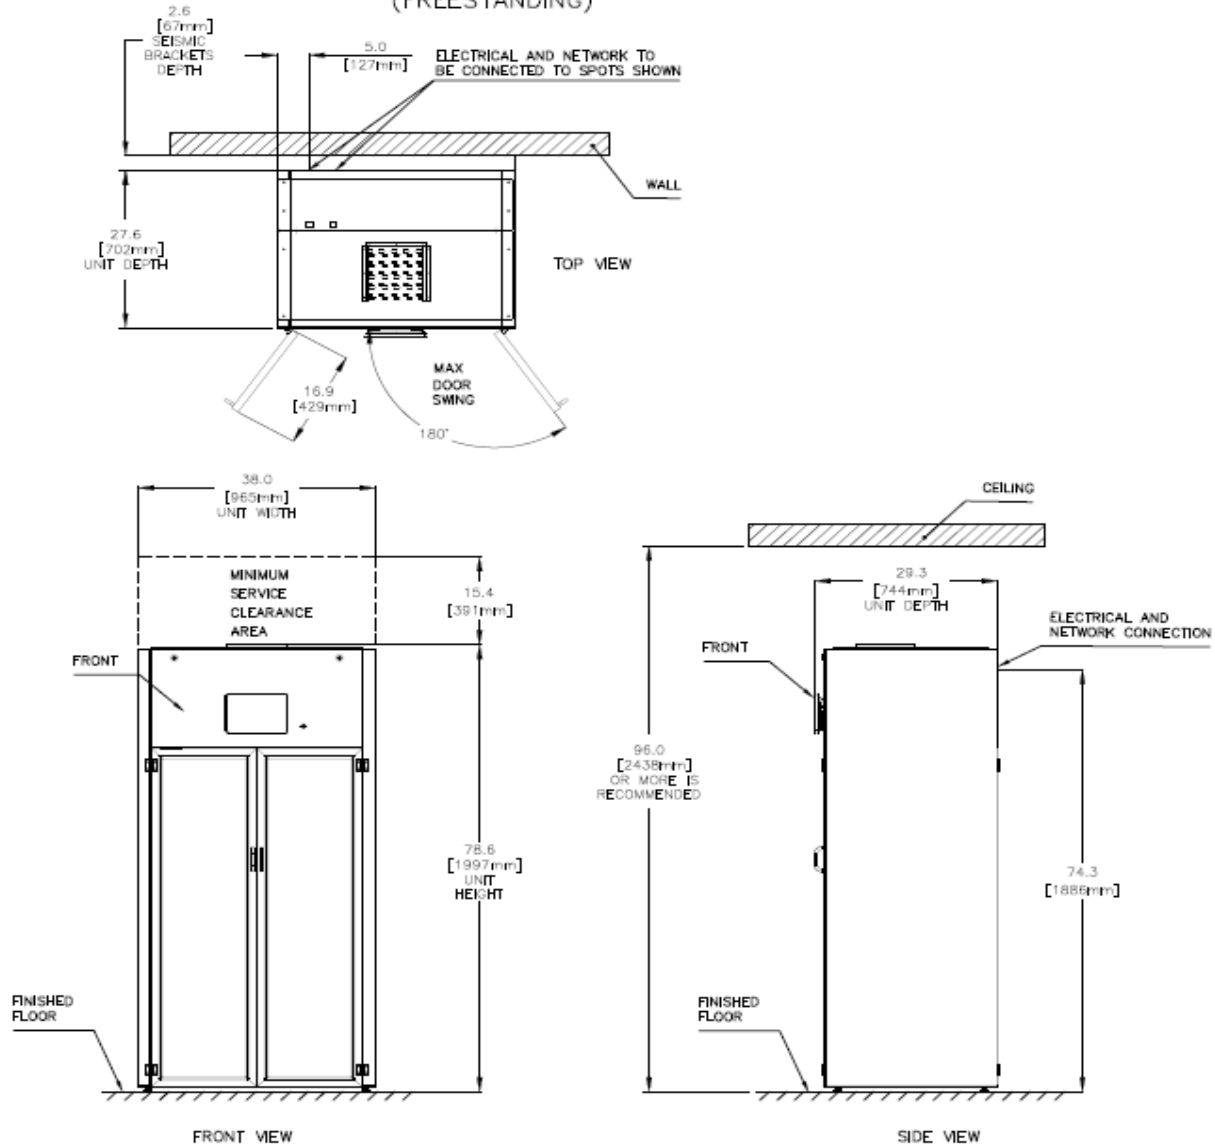


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### EQUIPMENT DRAWING AMSCO DRYING CABINET 38" INSTALLATION

SIZE:  
**A**

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DRAWN BY:  
**TYLER BASCH**

DRAWING NUMBER:  
**11003253**

PART NUMBER:  
**11003253**

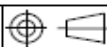
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SHEET  
**2 OF 6**

# WinnMed

## 29" PASS THROUGH DRYING CABINET TYPICAL INSTALLATION




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### EQUIPMENT DRAWING AMSCO DRYING CABINET 29" PASS THROUGH INSTALLATION

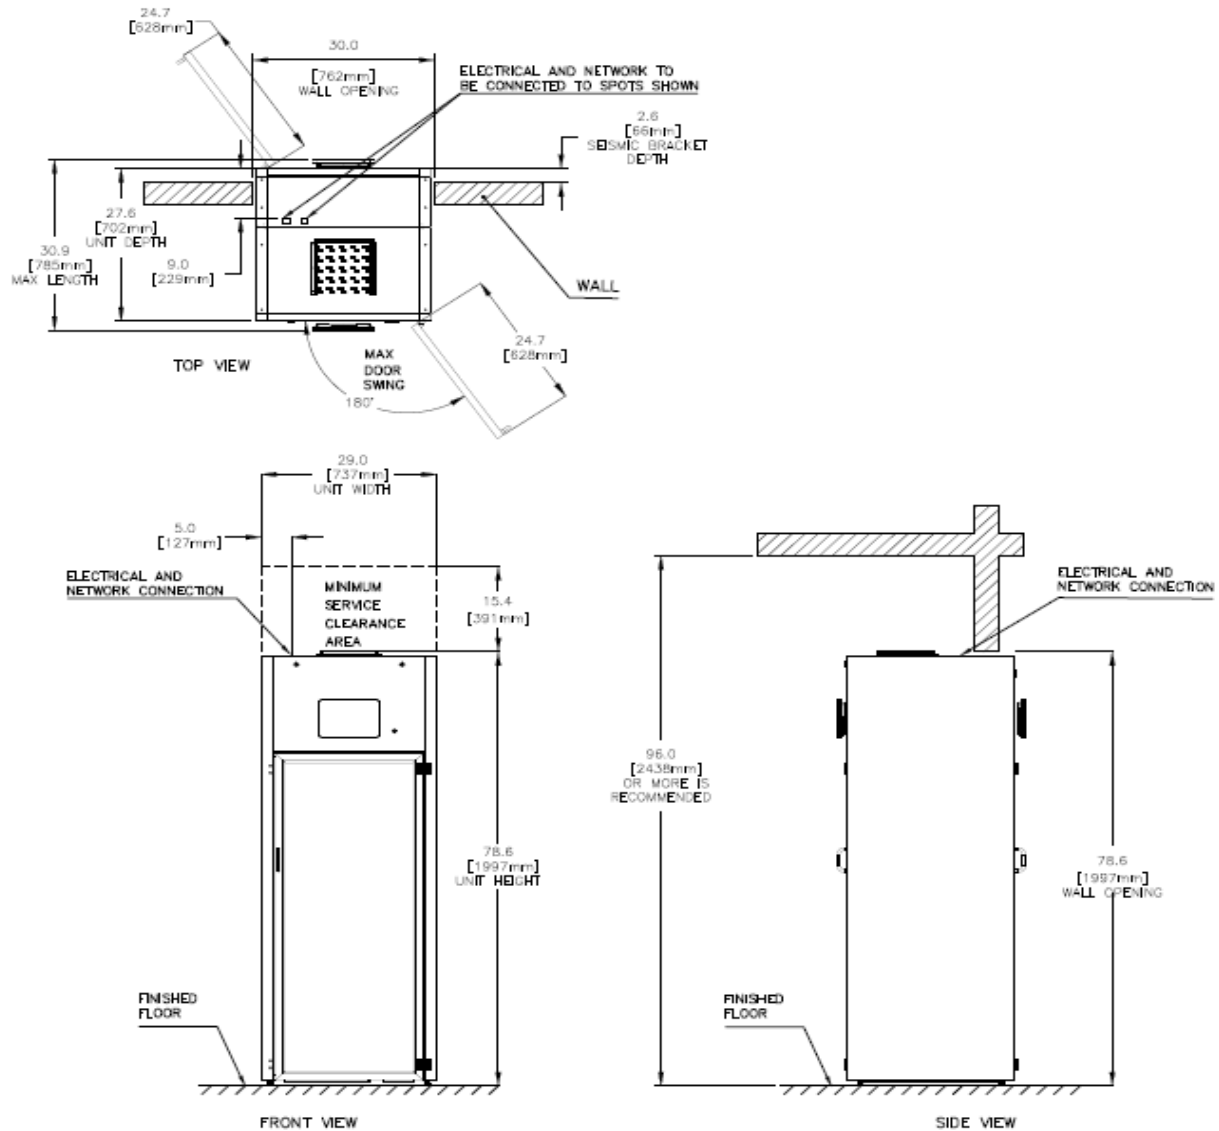SIZE:  
**A**

SCALE:  
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DRAWN BY:  
**TYLER BASCH**

DRAWING NUMBER:  
**11003253**

PART NUMBER:  
**11003253**

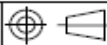
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SHEET  
**3 OF 6**

# WinnMed

## 38" PASS THROUGH DRYING CABINET TYPICAL INSTALLATION




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### EQUIPMENT DRAWING AMSCO\_DRYING\_CABINET\_38" PASS THROUGH INSTALLATION

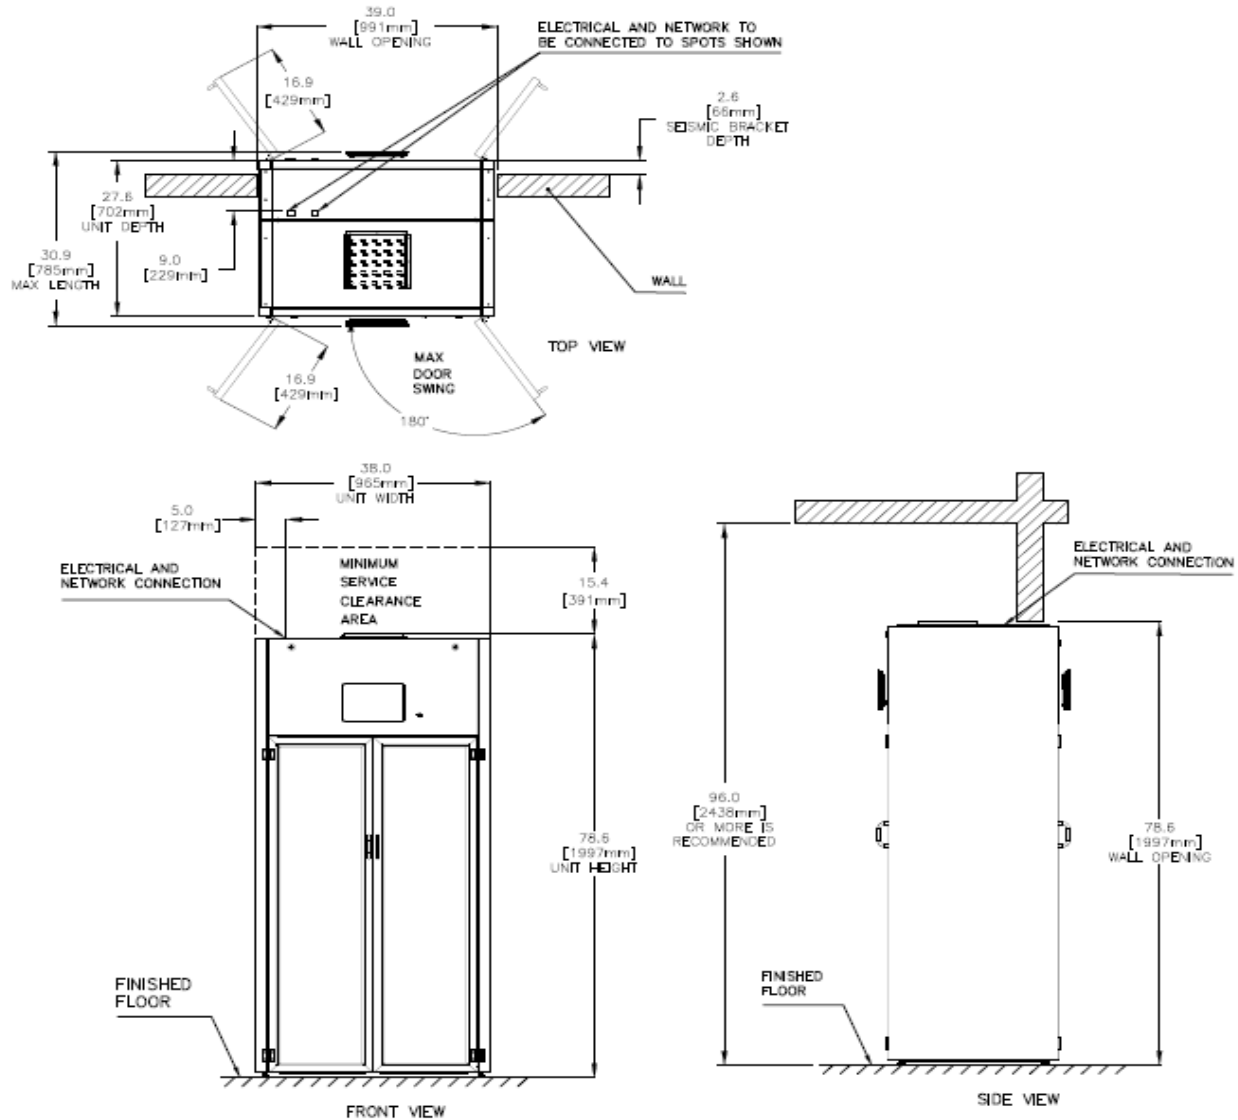SIZE:  
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DRAWN BY:  
**TYLER BASCH**

DRAWING NUMBER:  
**11003253**

PART NUMBER:  
**11003253**

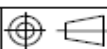
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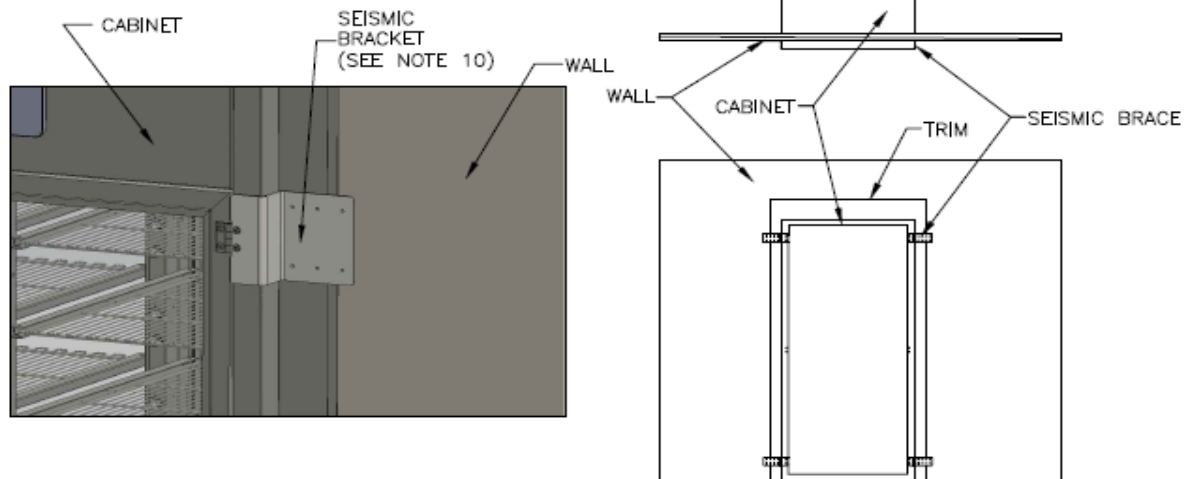
SHEET  
**4 OF 6**

# WinnMed

## METHOD #1



## METHOD #2

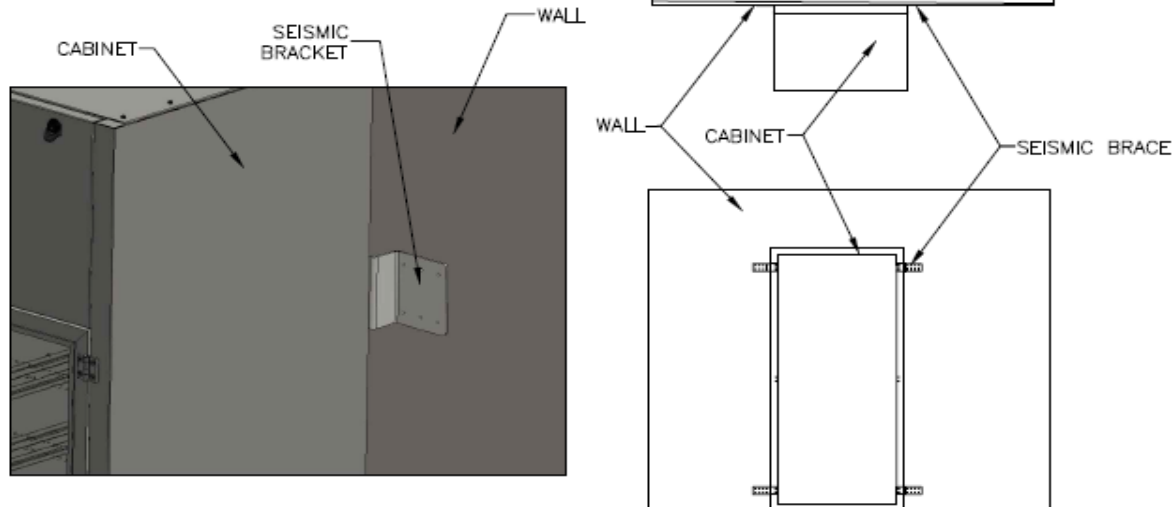


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EQUIPMENT\_DRAWING  
AMSCO\_DRYING\_CABINET  
SEISMIC\_INSTALLATION

SIZE:  
**A**

SCALE:  
NTS

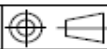

DRAWN BY:  
**TYLER BASCH**

DRAWING NUMBER:  
**11003253**

PART NUMBER:  
**11003253**

REVISION:  
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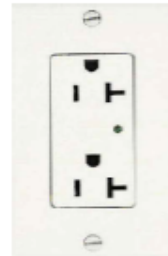
SHEET  
**5 OF 6**

# WinnMed

PHYSICAL SPECIFICATIONS		
SHIPPING DIMENSIONS	34 in x 53 in x 96in [0.86 m x 1.35 m x 2.44 m]	
SHIPPING WEIGHT	29 INCH UNIT	38 INCH UNIT
	750 LB [340 KG]	850 LB [386 KG]
OPERATING WEIGHT (LOADED)	29 INCH UNIT	38 INCH UNIT
	650 LB [295 KG]	750 LB [340 KG]
OPERATING CONDITIONS	63°F - 77°F (17°C - 25°C) at 20% - 60% RH	
A-WEIGHTED SOUND POWER LEVEL	53 dBa	
HEAT LOSS	2500 BTU/HR at 70°F (21°C)	
ELECTRICAL	110 - 120VAC 20AMP DEDICATED WALL PLUG (AS SHOWN)	



CORD



WALL PLUG

## INSTALLATION NOTES:

1. ALL DIMENSIONS ARE IN INCHES AND [MM].
2. THE INSTALLATION OF THE HEATING CABINET MUST MEET ALL FEDERAL, STATE AND LOCAL REGULATIONS (NEC IN U.S., IEC IN EU AND CEC IN CANADA).
3. INSTALLATION SPECIFICATIONS IS LISTED AS ENGINEERING AND INSTALLATION GUIDES.
4. REFERENCED COMPONENTS AND SERVICE CONNECTIONS ARE NOT FURNISHED AS PART OF EQUIPMENT UNLESS UNDER WRITTEN AGREEMENT WITH STERIS.
5. IT IS RECOMMENDED THAT THE HEATING CABINET BE INSTALLED IN AN AREA WITH A VENTILATION SYSTEM.
6. POWER CORD GRAY NEMA 5-20P TO IEC 320-C15 SJT TO BE INCLUDED WITH CABINET 10.0FT LONG.
7. FOR PASS THROUGH UNITS, WALL THICKNESS IS AT 3.5-6" (8.5" MAX WITHOUT SEISMIC KIT OR 6.5" MAX WITH SEISMIC KIT).
8. PASS-THROUGH CABINETS WITHOUT SEISMIC KITS MAY BE MOUNTED FLUSH WITH WALL.
9. SEISMIC BRACKETS COME WITH 1" SCREWS TO ATTACH TO CABINET. HARDWARE TO ATTACH TO WALL IS NOT INCLUDED.
10. IF TRIM KIT IS USED, TRIM MAY NEED TO BE CUT AROUND SEISMIC BRACKETS.
11. LEVELING FEET ARE PROVIDED FOR PROPER INSTALLATION.
12. SERVICE CLEARANCE MUST BE MAINTAINED TO ALLOW ACCESS TO HEATING CABINET FOR SERVICEABILITY.
13. STERIS ASSUMES NO RESPONSIBILITY FOR CHANGES MADE NECESSARY THROUGH FAILURE TO OBSERVE THE SPECIFICATIONS ON EQUIPMENT DRAWING AND NOTE PAGES. SPECIFICATIONS AND DESCRIPTIONS ARE SUBJECT TO CHANGE WITHOUT NOTICE.




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## EQUIPMENT\_DRAWING AMSCO\_DRYING\_CABINET GENERAL\_NOTES

SIZE:  
**A**

SCALE:  
**NTS**

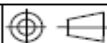

DRAWN BY:  
**TYLER BASCH**

DRAWING NUMBER:  
**11003253**

PART NUMBER:  
**11003253**

REVISION:  
**B**

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SHEET  
**6 OF 6**

# WinnMed

WinnMed

Issue Date:

3/6/2024

Expansion and Renovation

Decorah, IA 52101

Furniture Specifications

CONTACT:

Ben Stevens - CFO

PHONE NUMBER:

563-387-3109

ITEM NUMBER:	8
--------------	---

ITEM NAME:	Prep & Pack Table		
ROOM NUMBER:		QUANTITY:	

## SPECIFICATION INFORMATION

MANUFACTURER: Steris

MODEL #: PREP63

DIMENSIONS: 60" W x 30" D x 26.5" - 41.5" H

DESCRIPTION: Height Adjustable Prep and Pack table; deluxe accessories include drawer, magnification light; Shelf; light; back rails

## FURNITURE & EQUIPMENT IMAGE





# WinnMed



# WinnMed

WinnMed

Issue Date:

3/6/2024

Expansion and Renovation

Decorah, IA 52101

Furniture Specifications

CONTACT:

Ben Stevens - CFO

PHONE NUMBER:

563-387-3109

ITEM NUMBER:

9

ITEM NAME:

Low Temp Electric Sterilizer

ROOM NUMBER:

QUANTITY:

## SPECIFICATION INFORMATION

MANUFACTURER:

Steris

MODEL #:

VP500002101

DIMENSIONS:

33" W x 38.25" D x 72" H

DESCRIPTION:

Free-standing low temp electric sterilizer; 50 lbs capacity; daVinci compatible;  
200-230 V; 50/60 Hz; 3 Phase; 16 amps


## FURNITURE & EQUIPMENT IMAGE




# WinnMed




# WinnMed

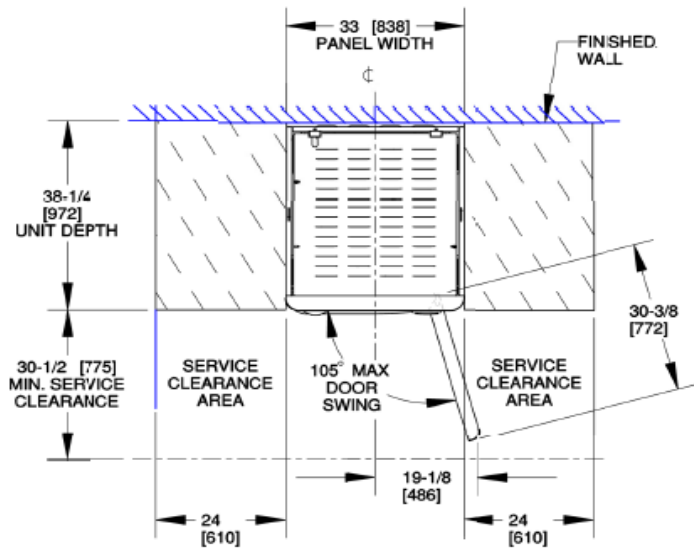

TOP VIEW

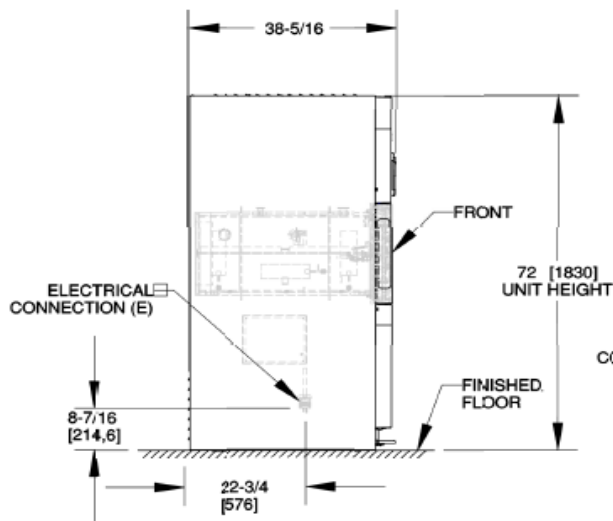

SIDE VIEW

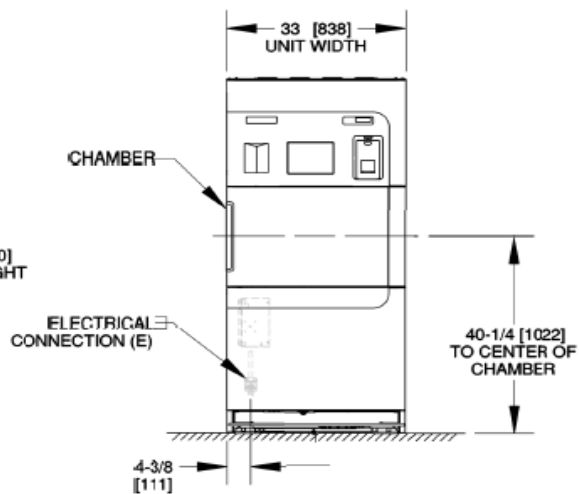

FRONT VIEW



## SINGLE DOOR CABINET EQUIPMENT DRAWING □ AMSCO V-PRO MAX 2

SIZE: A	SCALE: NTS	DRAWN BY: Lambert, Sean	DRAWING NUMBER: 10251899 D.5	PART NUMBER: 10091243	REVISION: D
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SHEET  
1 OF 3

# WinnMed

## AMSCO V-PRO MAX 2

### UTILITY REQUIREMENTS CHART

UTILITY	PARAMETER	REQUIREMENT	NOTES
ELECTRICAL (E)	DOMESTIC 200-230 VOLTS, 50/60HZ THREE PHASE	CURRENT 16 AMPS, MIN. CIRCUIT BREAKER 20 AMPS, USE NEMA L15-20R PLUG	1. PROVIDE GROUPED OR GANGED CIRCUIT PROTECTION AND DISCONNECT FOR (3) PHASE POWER AS REQUIRED BY NEC AND LOCAL CODES. INDIVIDUAL POWER SHUTOFFS RECOMMENDED NEAR EACH MACHINE FOR SERVICING.
	INTERNATIONAL 380-415 VOLTS, 50/60HZ THREE PHASE	CURRENT 10 AMPS, MIN. CIRCUIT BREAKER 12 AMPS, USE NEMA L15-20R PLUG	2. PROVIDE GROUNDED METAL CONDUIT AND WIRING BETWEEN EQUIPMENT TERMINALS AND STUB OUTS OR DISCONNECTS. 14 AWG MINIMUM SIZE RECOMMENDED. 3. 10 FT. POWER CORD INCLUDED

### PHYSICAL SPECIFICATIONS

SHIPPING WEIGHT, (APPROX)	1020 LBS. (463 KG.)	1. LEVELING FEET ARE PROVIDED FOR PROPER INSTALLATION.
MAXIMUM OPERATING WEIGHT, BASED ON CHAMBER FULLY LOADED	920 LBS. (417 KG.)	2. UNIT WIDTH IS 33". DOOR OPENINGS IN FACILITY MUST BE 36" WIDE OR LARGER TO ACCOMMODATE STERILIZER.
SHIPPING DIMENSIONS W x L x H	49-1/2 X 61 X 87-3/4 (1257.3 X 1549.4 X 2228.85)	3. ALL DIMENSIONS IN INCHES AND [MM].
OUTSIDE DIMENSIONS W x L x H	33 X 38-5/16 X 72 (838 X 973 X 1829)	4. FLOOR SPACE IN LOADING/UNLOADING AREAS OF EQUIPMENT TO BE LEVEL WITHIN 1/16". FOR INSTANCES OF MULTIPLE INSTALLATIONS THIS TOLERANCE SHOULD BE HELD FOR THE ENTIRE SPAN OF INSTALLED EQUIPMENT.
CHAMBER DIMENSIONS W x L x H	17 X 32-1/2 X 15 (432 X 381 X 825)	5. SERVICE CLEARANCE MUST BE MAINTAINED TO ALLOW ACCESS TO STERILIZER FOR SERVICEABILITY.
HEAT LOSS AT 70° F (21° C)	1500 BTU/HR	6. STERIS ASSUMES NO RESPONSIBILITY FOR CHANGES MADE NECESSARY THROUGH FAILURE TO OBSERVE THE SPECIFICATIONS ON EQUIPMENT DRAWING AND NOTE PAGES. SPECIFICATIONS AND DESCRIPTIONS ARE SUBJECT TO CHANGE WITHOUT NOTICE.
A-WEIGHTED SOUND POWER LEVEL	72.90dB (A) CALCULATED PER ISO 3746	

#### INSTALLATION SPECIFICATIONS:

- THE INSTALLATION OF THE AMSCO V-PRO MAX 2 LOW TEMPERATURE STERILIZATION SYSTEMS MUST MEET ALL FEDERAL, STATE AND LOCAL REGULATIONS (NEC IN U.S., IEC IN EU, AND CEC IN CANADA).
- INSTALLATION SPECIFICATION IS LISTED AS ENGINEERING AND INSTALLATION GUIDES. REFERENCED COMPONENTS AND SERVICE CONNECTIONS ARE NOT FURNISHED AS PART OF EQUIPMENT UNLESS UNDER WRITTEN AGREEMENT WITH STERIS.
- PER ANSI/AAMI ST58:2013 OR SUBSEQUENT, THE STERILIZER SHALL BE INSTALLED AND OPERATED IN AN AREA WITH A VENTILATION SYSTEM CAPABLE OF AT LEAST 10 AIR EXCHANGES PER HOUR.
- STERILIZER MUST BE INSTALLED AND OPERATED IN AN AREA WHERE THE TEMPERATURE IS BETWEEN 59° F AND 86° F (15° C AND 30° C), AND THE RELATIVE HUMIDITY RANGE IS BETWEEN 20% AND 55%.
- UNIT SHOULD NOT BE INSTALLED IN AN AREA WHICH IS NOT COMPATIBLE WITH OXIDIZERS. CONSULT THE MSDS FOR ANY CHEMICALS THAT MAY BE PRESENT IN ADDITION TO THE MSDS FOR THE HYDROGEN PEROXIDE STERILANT.



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### SINGLE DOOR CABINET EQUIPMENT DRAWING AMSCO V-PRO MAX 2

SIZE:  
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DRAWN BY:  
Lambert, Sean

DRAWING NUMBER:  
10251899 D.5

PART NUMBER:  
10091243


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SHEET  
2 OF 3

# WinnMed

## SEISMIC MOUNTS



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Corporation
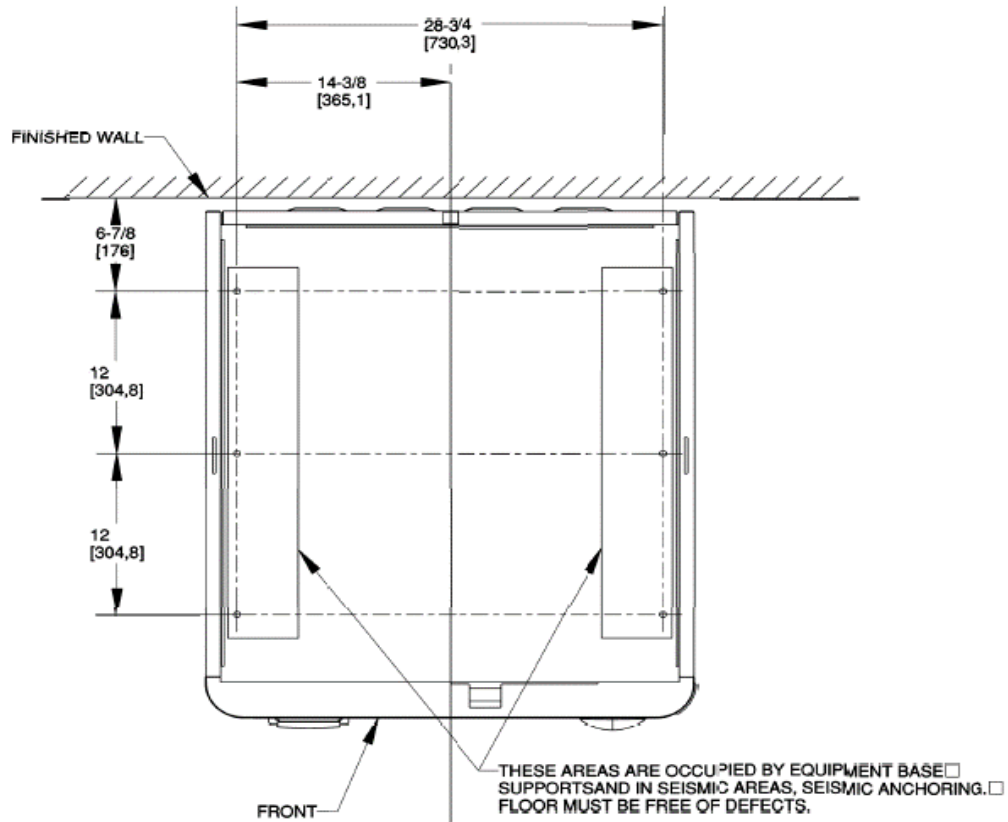
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SINGLE DOOR CABINET EQUIPMENT DRAWING  
AMSCO V-PRO MAX 2

SIZE:  
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SCALE:  
NTS



DRAWN BY:  
Lambert, Sean

DRAWING NUMBER:  
10251899 D.5

PART NUMBER:  
10091243

REVISION:  
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SHEET  
3 OF 3

# WinnMed

WinnMed

Issue Date:

3/6/2024

Expansion and Renovation

Decorah, IA 52101

Furniture Specifications

CONTACT:

Ben Stevens - CFO

PHONE NUMBER:

563-387-3109

ITEM NUMBER:	10
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ITEM NAME:	Prevac Steam Sterilizer		
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ROOM NUMBER:		QUANTITY:	
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SPECIFICATION INFORMATION	
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MANUFACTURER: Steris

MODEL #: EF1301242

DIMENSIONS: 42.25" W x 76.5" D x 89" H

DESCRIPTION: Electric Prevac Steam Sterilizer; Single Door; Vertical Slide; 480V; 45kW Integral Steam Generator; 375 lbs. capacity; touch screen controls; thermal printer; Flush and drain kit; chamber rails; 26.5" W x 26.5" D x 63" H Chamber Dimensions

FURNITURE & EQUIPMENT IMAGE
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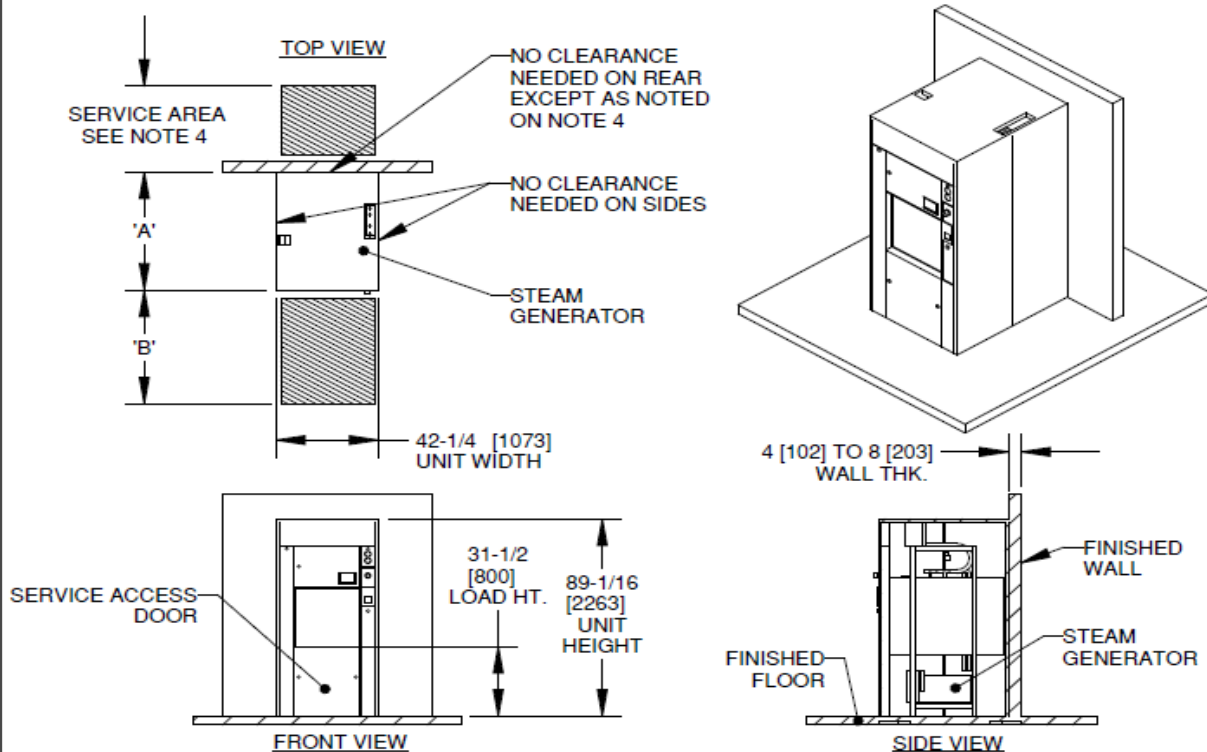
# WinnMed





# WinnMed

STERILIZER MODEL	CHAMBER LENGTH	UNIT LENGTH DIM. 'A'	MINIMUM SERVICE AND LOAD AREA - DIM. 'B'	
			WITHOUT ALUS	WITH ALUS
939V-1	39"	52-7/8" [1343]	78" [1981]	147-1/16" [3735]
1251V-1	51"	64-11/16" [1643]	102" [2591]	182-7/8" [4645]
1563V-1	63"	76-1/2" [1943]	126" [3200]	218-11/16" [5555]



## NOTES:

1. THE FLOOR AREA (IN SERVICE AND LOAD/UNLOAD AREAS) MUST BE SMOOTH AND HAVE A LEVEL TOLERANCE WITHIN  $\pm 1/2$  DEG OR  $\pm 1/16"$  PER FOOT, WITHOUT ANY OBSTRUCTIONS SUCH AS PIPING, WIRING, FLOOR SINKS, ETC.
2. SERVICE AND LOADING AREA CLEARANCE OF UNIT SHOULD BE AT UNIT WIDTH.
3. SERVICE AREAS SHOWN ARE SOLELY REPRESENTATIVE OF THE MANUFACTURER'S RECOMMENDED CLEARANCE TO SAFELY PERFORM PREVENTATIVE MAINTENANCE AND REPAIR SERVICES. CUSTOMER IS RESPONSIBLE TO ENSURE CLEARANCES MEET OR EXCEED LOCAL AND NATIONAL CODE REQUIREMENTS. ADHERENCE TO LOCAL AND NATIONAL CODES AND PROCUREMENT OF PERMITS IS THE RESPONSIBILITY OF THE CUSTOMER UNLESS AGREED TO IN WRITING WITH STERIS.
4. PROVIDE 30" TALL SERVICE ACCESS THROUGH WALL FROM BACK OF UNIT IF EQUIPPED WITH FOLLOWING ACCESSORIES:
  - a. 30" [760] IF EQUIPPED WITH STERI-GREEN PLUS.
  - b. 18" [460] IF EQUIPPED WITH STERI-GREEN.
5. ZERO CLEARANCE NEEDED OUTSIDE OF SERVICE AND LOADING AREAS.
6. CONFIGURATION SHOWN INCLUDES BACK PANEL, WITH PROTRUDING THICKNESS OF 3/16" [5].
7. AUTOMATIC LOAD AND UNLOAD SYSTEM (ALUS) EQUIPMENT DRAWING P/N: 11028378.
8. LOADING EQUIPMENT CART AND TRANSFER CARRIAGE EQUIPMENT DRAWING P/N: 11012876.
9. ALL DIMENSIONS ARE INCHES AND MILLIMETERS [MM].
10. FACILITY DOOR OPENINGS IN PATH TO POINT OF INSTALLATION SHALL BE AT MINIMUM 80" x 40" [2032 x 1016] (HxW).
11. FOR MULTIPLE SIDE BY SIDE STERILIZER INSTALLATIONS, ADD 1/8" PER STERILIZER TO THE TOTAL WALL OPENING TO ALLOW FOR PROPER FIT UP.

**STERIS**


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EQUIPMENT DRAWING, AMSCO 600, 26.5" X 26.5" X 39", 51" & 63" LG. SLIDING, SD, CABINET, ELECTRIC STEAM GENERATOR

SIZE  
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SCALE  
-



DRAWN BY:  
Gosha, Deon

DRAWING NUMBER:  
10778442

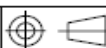
PART NUMBER:  
11008531

REVISION:  
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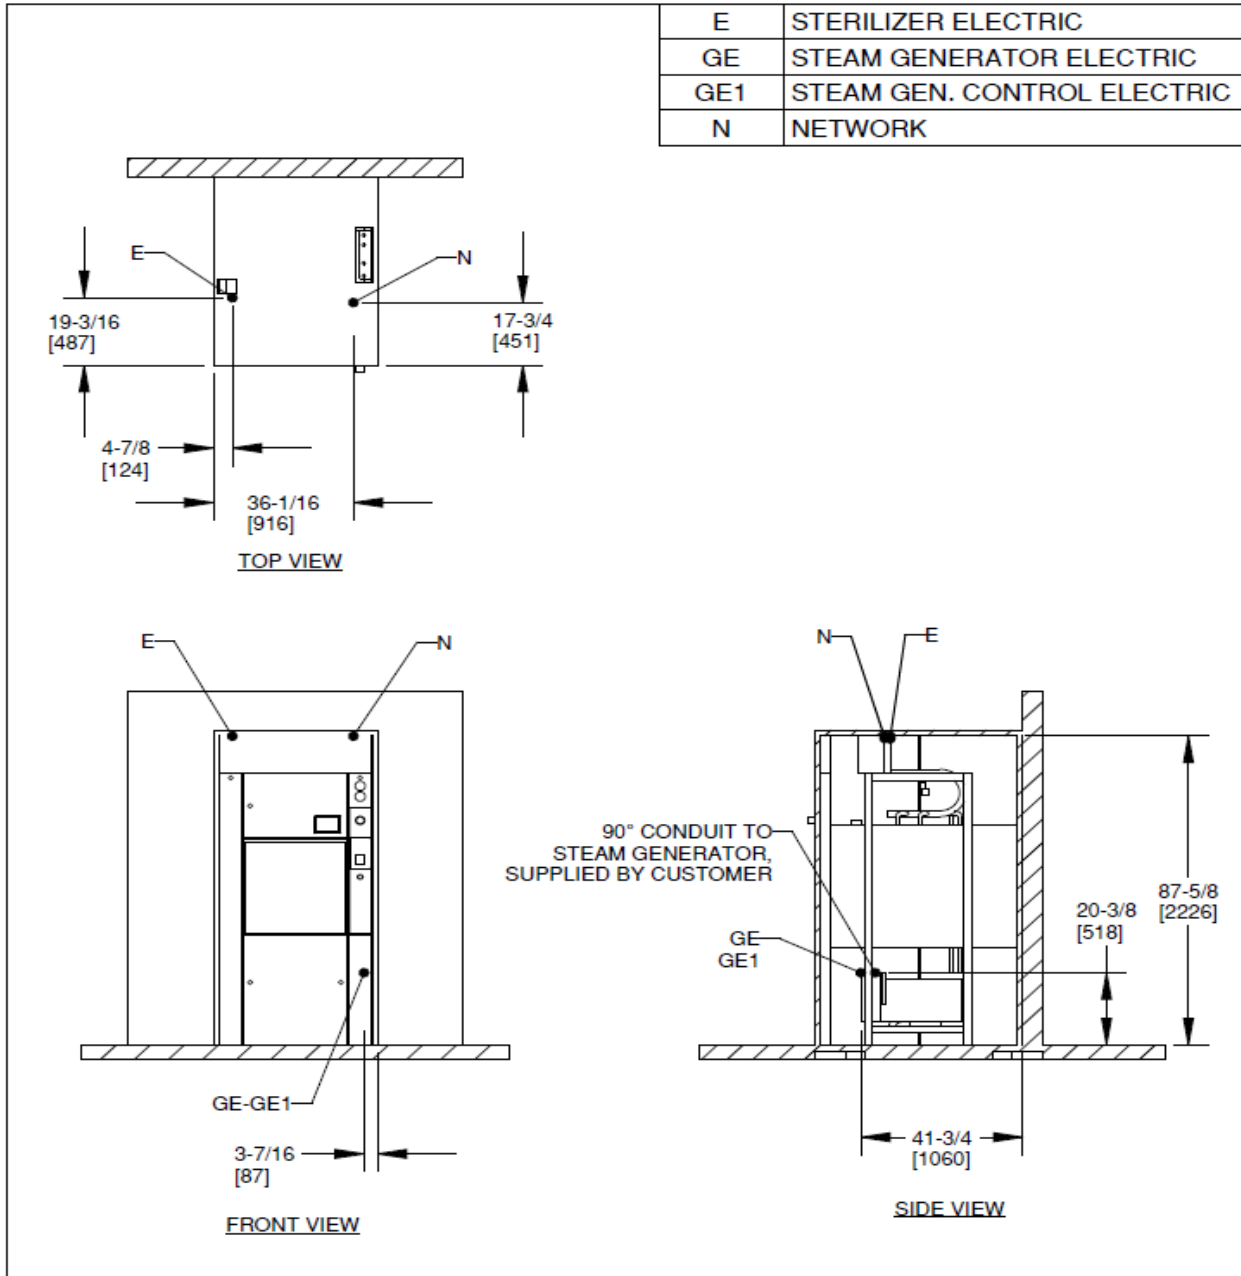
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SHEET  
1 OF 8

# WinnMed



# WinnMed

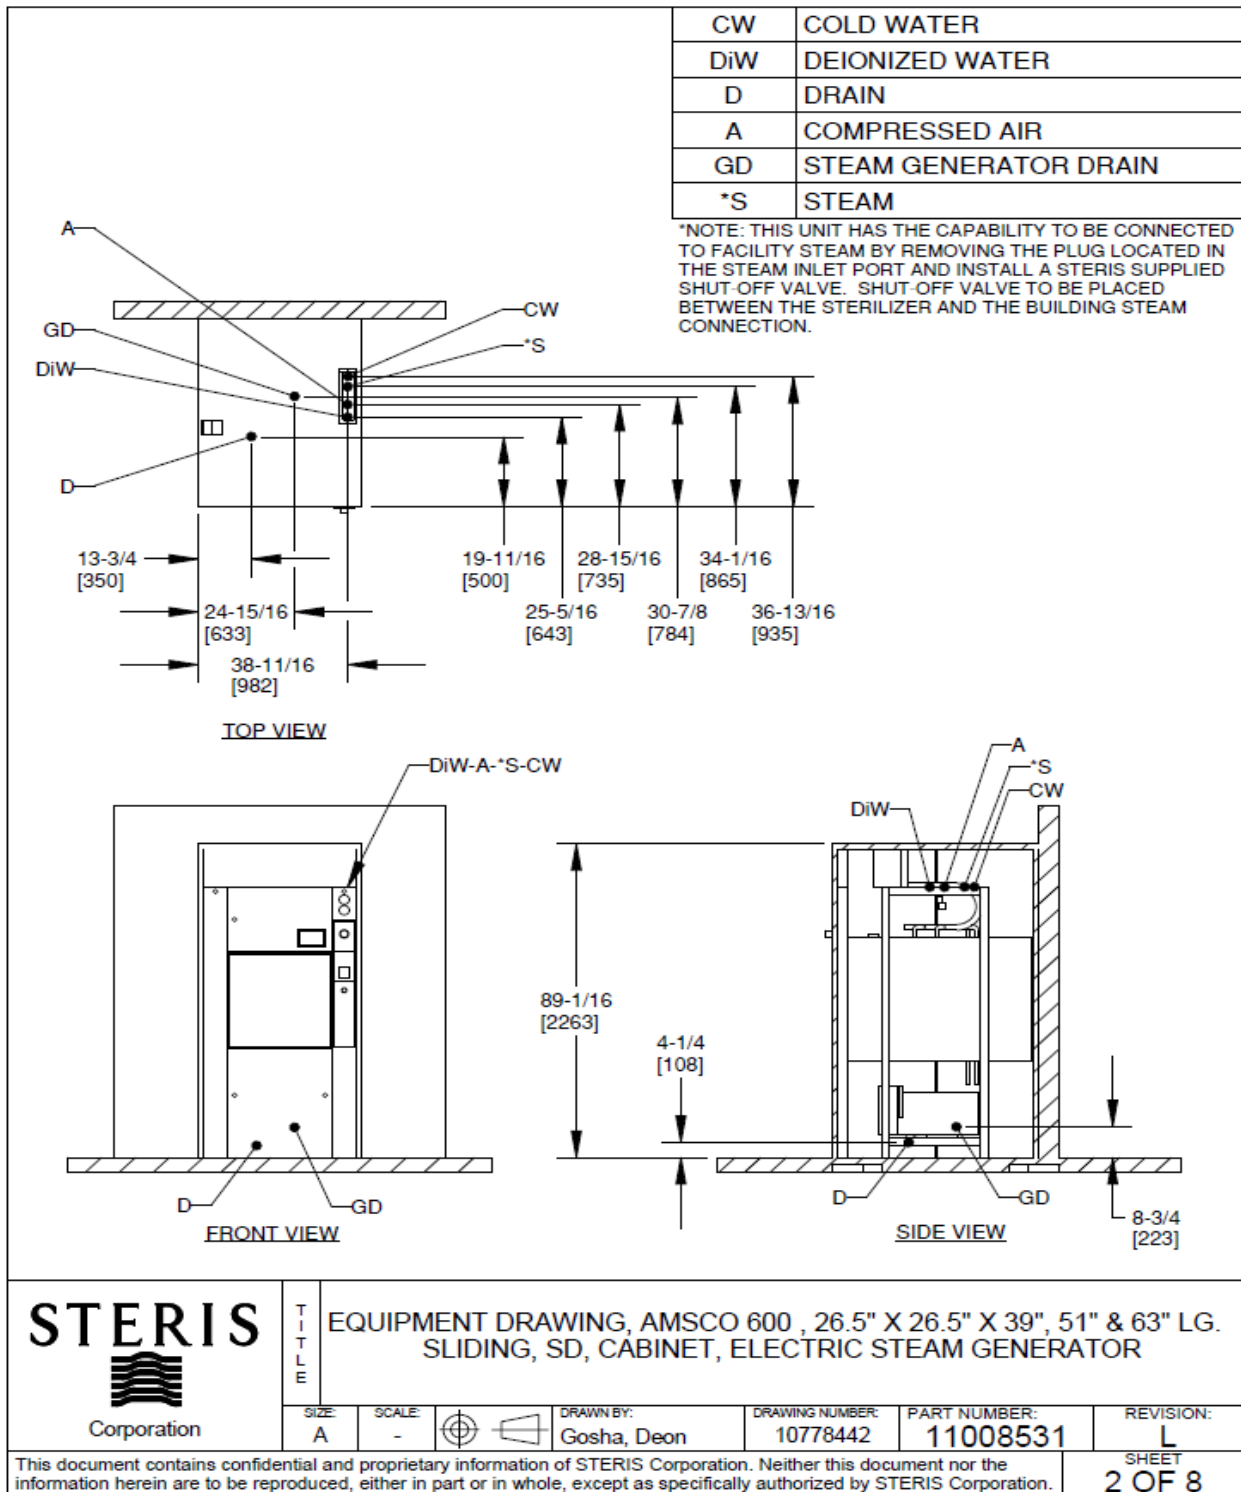

**TITLE**  
EQUIPMENT DRAWING, AMSCO 600 , 26.5" X 26.5" X 39", 51" & 63" LG.  
SLIDING, SD, CABINET, ELECTRIC STEAM GENERATOR

SIZE A	SCALE -	DRAWN BY: Gosha, Deon	DRAWING NUMBER: 10778442	PART NUMBER: 11008531	REVISION: L
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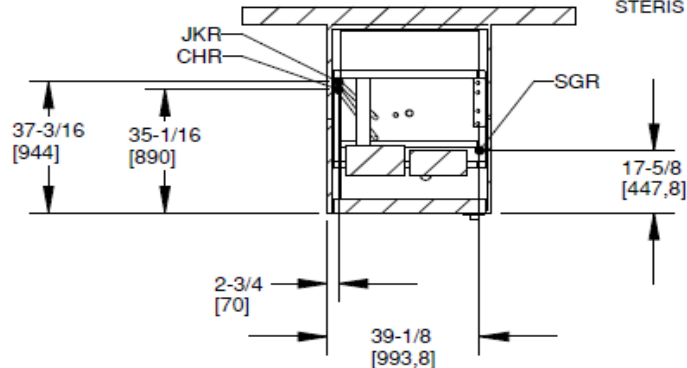
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SHEET  
3 OF 8


# WinnMed

JKR	JACKET RELIEF VALVE DISCHARGE PIPE - 1-1/8 ODT
CHR	CHAMBER RELIEF VALVE DISCHARGE PIPE - 1-1/8 ODT
SGR	STEAM GENERATOR RELIEF VALVE DISCHARGE PIPE - 1-1/8 ODT


IMPORTANT: FOR OPTIMAL INSTALLATION, COMPRESSED AIR, WATER, STEAM, NETWORK, & POWER UTILITIES SHOULD BE SUPPLIED BY CUSTOMER FROM ABOVE THE UNIT IN THE LOCATION INDICATED ON THE DRAWING. CONSULT WITH STERIS IF A DEVIATION IS REQUIRED.



TOP VIEW  
(FRONT OF UNIT)

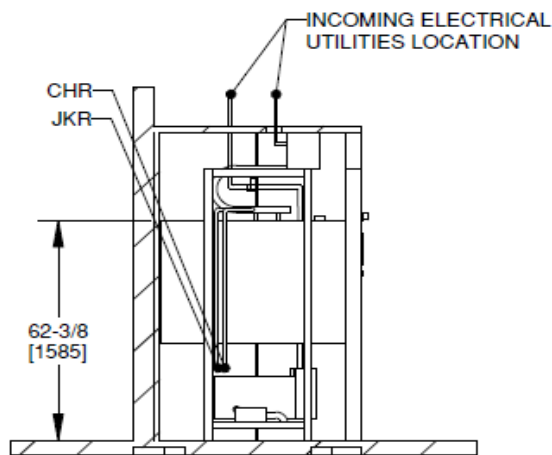

LEFT SIDE VIEW

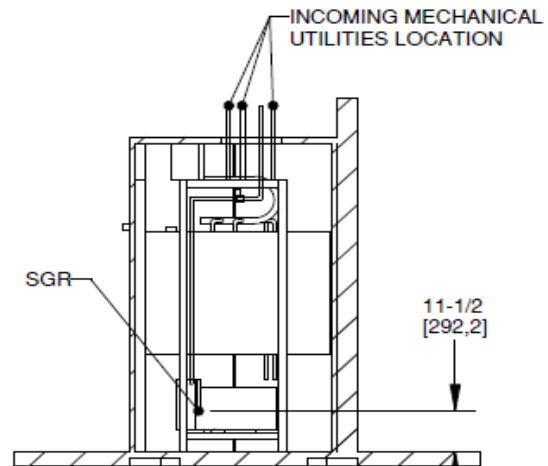

RIGHT SIDE VIEW




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EQUIPMENT DRAWING, AMSCO 600, 26.5" X 26.5" X 39", 51" & 63" LG.  
SLIDING, SD, CABINET, ELECTRIC STEAM GENERATOR

SIZE  
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SCALE  
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DRAWN BY:  
Gosha, Deon

DRAWING NUMBER:  
10778442


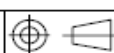
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SHEET  
4 OF 8
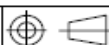
# WinnMed

MECHANICAL						
UTILITY REQUIREMENTS CHART						
UTILITY	PARAMETER	SPECIFICATIONS			NOTES	
STERILIZER COLD WATER (CW) SEE NOTE 10	CONNECTION SIZE/TYPE	3/4" NPT			INSTALLATION SPECIFICATIONS:  1. PIPE SIZES LISTED UNDER PLUMBING REQUIREMENTS INDICATE THE EQUIPMENT TERMINATION SIZES ONLY. SIZE PIPING TO EQUIPMENT DEPENDING ON LENGTH OF PIPE RUN FROM PRESSURE REGULATING STATION FOR THE STEAM LINE AND MAIN WATER HEADERS. SUPPLY THE SPECIFIED SERVICE PRESSURE AND FLOW RATE AT EQUIPMENT TERMINALS, INCLUDE EFFECT OF COINCIDENT DRAW OF MULTIPLE UNIT INSTALLATIONS.  2. PROVIDE PIPING, SHUTOFF VALVE, PIPE PLUGGED TEE, AND UNION IN STEAM AND WATER SUPPLY CONNECTIONS BETWEEN EQUIPMENT AND STUB OUTS. PLUGGED TEE CAN LATER BE USED FOR TEST PRESSURE GAUGE CONNECTION. ARRANGE CONNECTION PIPING TO ALLOW ACCESS TO MACHINE COMPONENTS AND ELECTRICAL CONTROL PANEL.  3. RECOMMENDED PROVISION OF BLOW DOWN VALVE AT EACH STEAM AND WATER STRAINER TO ENABLE STRAINER CLEAN OUT.  4. BLOW DOWN BUILDING (FACILITY) AIR STEAM AND WATER SUPPLY LINES BEFORE FINAL CONNECTION TO THE EQUIPMENT.  5. THE STERILIZER IS NOT SUPPLIED WITH A VACUUM BREAKER OR BACKFLOW PREVENTER. WHERE REQUIRED BY LOCAL CODES, INSTALLATION OF A VACUUM BREAKER IN THE WATER LINE IS SUPPLIED BY OTHER PARTIES. STERIS OFFERS A BACKFLOW PREVENTER AS AN OPTION.  6. PLACEMENT OF PIPING SHUTOFFS, WHEN INSTALLING. SHUTOFF VALVES MUST BE LOCATED IN A SUITABLE POSITION WITHIN THE LINE OF SIGHT, AND CLEAR OF ANY OBSTRUCTIONS THAT PLACE THE SERVICE PERSONNEL IN HARMS WAY, IN ORDER TO TURN THE VALVE OFF.  7. REQUIRED PIPING PRACTICES FOR RELIEF VALVE PIPING CAN BE FOUND IN ASME BOILER CODE AND PRESSURE VESSEL CODE, SECTION VIII (8), PER PARAGRAPH UG-135.  8. FOR GENERAL INSTALLATION INFORMATION SEE STERIS DRAWING NUMBER 62941-091.  9. FOR MULTIPLE UNITS INSTALLATION, SET LOAD HEIGHT (DISTANCE BETWEEN FLOOR TO BOTTOM OF CHAMBER) WITHIN ±1/16" FOR ALL UNITS.  10. FOR FEED WATER AND STEAM QUALITY SEE STERIS DRAWING NUMBER 62941-091.  11. MINIMUM RESISTIVITY: 1 MΩ*cm (1 MEGA-OHM * cm). PER ASME PEB-5.3. MINIMUM CONDUCTIVITY:1µS/CM.  12. OPTIONAL AIR COMPRESSOR IS AVAILABLE. CONTACT STERIS FOR MORE INFORMATION.  13. FOR UNITS WITHOUT FLUSH AND DRAIN OPTION, PLUMB STEAM GENERATOR DRAIN "GD" TO FLOOR SINK ON SITE. PIPING PROVIDED BY CUSTOMER.  14. CUSTOMER SUPPLIED DRAIN EXTENSION SHOULD BE ANCHORED.  15. IN CYCLE CONSUMPTION DATA BASED ON PREVAC OF 270°F, 4 MINUTE STERILIZE, 30 MINUTE DRY WITH METAL LOAD.	
	PRESSURE RANGE	20-50 DYNAMIC PSIG (1.4-3.4 BARG)				
	TEMPERATURE RANGE	40°-70°F (4°-21°C)				
	MIN. FLOW RATE	12 GPM (45 LPM)				
	AVERAGE CONSUMPTION	39" LG - PEAK: 12 GPM (45 LPM) PER CYCLE: 97 GAL (367 L) OUT OF CYCLE: 20 GPH (75 LPH) 51" LG - PEAK: 12 GPM (45 LPM) PER CYCLE: 112 GAL (424 L) OUT OF CYCLE: 25 GPH (95 LPH) 63" LG - PEAK: 12 GPM (45 LPM) PER CYCLE: 128 GAL (484 L) OUT OF CYCLE: 30 GPH (114 LPH)				
GENERATOR DEIONIZED WATER (DiW) SEE NOTE 10 AND 11	CONNECTION SIZE/TYPE	1/2" NPT				
	SUPPLY TEMP.	70-140°F (21-60°C)				
	PRESSURE RANGE	20-50 DYNAMIC PSIG (1.4 - 3.4 BARG)				
	FLOW RATE	PEAK: 0.6 GPM (2.3 LPM)				
	AVERAGE CONSUMPTION	39" LG - PER CYCLE: 4.2 GAL (16 L) OUT OF CYCLE: 3 GPH (11 LPH) 51" LG - PER CYCLE: 5.4 GAL (20 L) OUT OF CYCLE: 4 GPH (15 LPH) 63" LG - PER CYCLE: 6.6 GAL (25 L) OUT OF CYCLE: 5 GPH (19 LPH)				
DRAIN (TO FLOOR SINK) (D) SEE NOTE 14	CONNECTION SIZE/TYPE	1-1/2" ODT OPEN				
	AVERAGE OPERATING FLOW RATE	GRAVITY DRAIN MUST BE ABLE TO HANDLE PEAK WATER CAPACITY OF 15 GPM (57 LPM), MAX. DISCHARGE TEMP. FROM STERILIZER DRAIN: 140°F (60°C)				
	FLOOR SINK MIN. SIZE & ELEVATION	12" X 12" X 6" DEEP MIN. SIZE INSTALL AT FLOOR GRADE				
COMPRESSED AIR (A) SEE NOTE 12	CONNECTION SIZE/TYPE	1/2" NPT				
	PRESSURE RANGE	80-100 PSIG DYNAMIC 5.5 - 6.9 BARG				
	FLOW RATE	3 SCFM (5 SCM/H)				
	AIR QUALITY	OIL FREE, DRY (DEHUMIDIFIED)				
GENERATOR DRAIN (GD) SEE NOTE 13	CONNECTION SIZE/TYPE	1/2 NPT				
STEAM INLET (S) SEE NOTE 10	CONNECTION SIZE/TYPE	3/4" NPT				
	VAPOR QUALITY	97-100%				
	PRESSURE RANGE	50-80 DYNAMIC PSIG (3.4 - 5.5 BARG)				
	FLOW RATE	39" LG PEAK: 135 LB/HR (61 KG/HR)				
		51" LG PEAK: 181 LB/HR (82 KG/HR)				
		63" LG PEAK: 226 LB/HR (103 KG/HR)				
	AVERAGE CONSUMPTION	39" LG - PER CYCLE: 35 LB (16 KG) OUT OF CYCLE: 25 LB/HR (11 KG/HR) 51" LG - PER CYCLE: 45 LB (20 KG) OUT OF CYCLE: 33 LB/HR (15 KG/HR) 63" LG - PER CYCLE: 55 LB (25 KG) OUT OF CYCLE: 42 LB/HR (19 KG/HR)				
<div><div><div><div>STERIS</div><div></div><div>Corporation</div></div><div>TITLE</div><div>EQUIPMENT DRAWING, AMSCO 600 , 26.5" X 26.5" X 39", 51" &amp; 63" LG. SLIDING, SD, CABINET, ELECTRIC STEAM GENERATOR</div></div></div>						
SIZE: A		SCALE: -		DRAWN BY: Gosha, Deon	DRAWING NUMBER: 10778442	PART NUMBER: 11008531
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# WinnMed

## ELECTRICAL

### UTILITY REQUIREMENTS CHART

UTILITY	PARAMETER	SPECIFICATIONS	NOTES
STERILIZER ELECTRIC (E)	208-240 VAC THREE PHASE 3 WIRE AND GROUND 60 HZ	CURRENT 10 AMPS, RECOMMENDED PROTECTION 20 AMPS, #12 [3.31] AWG	<b>ELECTRICAL UTILITY REQUIREMENTS</b>  1. ALL CONNECTIONS SHOULD BE IN ACCORDANCE WITH LOCAL CODES.  2. ALWAYS FOLLOW LOCAL ELECTRICAL CODES AND SAFETY-RELATED WORK PRACTICES TO DETERMINE THE VALUE OF PRODUCTION.  3. DISCONNECT SWITCHES WITH OFF POSITION LOCKOUT (SUPPLIED BY OTHERS) MUST BE INSTALLED IN ELECTRIC SUPPLY LINES THAT ARE NOT SUPPLIED BY STERIS.  4. STERIS RECOMMENDS A LAMP IN SERVICE AREA TO ILLUMINATE THE SURROUNDING SPACE.  <b>INSTALLATION SPECIFICATIONS:</b>  1. PROVIDE GROUPED OR GANGED CIRCUIT PROTECTION AND DISCONNECT FOR STERILIZER POWER AS REQUIRED BY CODES AND STANDARDS. INDIVIDUAL POWER SHUTOFFS REQUIRED PER STANDARDS. INDIVIDUAL POWER SHUTOFFS REQUIRED NEAR MACHINE FOR SERVICING.  2. SEPERATE DISCONNECTS ARE REQUIRED FOR 3-PH TO GENERATOR HEATERS AND 1-PH TO ELECTRIC STEAM GENERATOR CONTROL.  3. PROVIDE GROUNDED METAL CONDUIT AND WIRING BETWEEN EQUIPMENT TERMINALS AND STUB OUT OR DISCONNECTS. CHECK LOCAL CODES FOR MINIMUM AWG. WIRE SIZE.  4. PLACEMENT OF ELECTRICAL DISCONNECTS: WHEN INSTALLING; DISCONNECTS MUST BE LOCATED IN SUITABLE LOCATIONS WITHIN LINE OF SIGHT AND CLEAR OF ANY OBSTRUCTIONS THAT WOULD PUT THE SERVICE PERSON OR OPERATOR IN HARMS WAY IN ORDER TO TURN IT OFF. ALSO, THE LOCATION OF THE DISCONNECTS SHOULD ALLOW THE SERVICE PERSON TO SHUTOFF POWER FROM THE SIDE TO PREVENT POSSIBLE ARC FLASH.  5. DO NOT USE GROUND FAULT CURRENT INTERRUPTER (GFCI).  6. MAIN INCOMING POWER WIRING TO HAVE 167°F (75°C) INSULATION RATING MINIMUM, COPPER ONLY.  7. 90" CONDUIT, SUPPLIED BY CUSTOMER, IS REQUIRED FOR INSTALLATION. IT IS LOCATED ON RIGHT SIDE OF STEAM GENERATOR ELECTRIC BOX.
	380-415 VAC THREE PHASE 3 WIRE AND GROUND 50/60 HZ	CURRENT 7 AMPS, RECOMMENDED PROTECTION 20 AMPS, #12 [3.31] AWG	
	440-480 VAC THREE PHASE 3 WIRE AND GROUND 60 HZ	CURRENT 7 AMPS, RECOMMENDED PROTECTION 20 AMPS, #12 [3.31] AWG	
STEAM GENERATOR ELECTRIC (GE) SEE NOTE 6	208 VAC THREE PHASE 3 WIRE AND GROUND 50/60 HZ	CURRENT 119 AMPS AT 208V, RECOMMENDED PROTECTION 150 AMPS, 1/0 [53.49] AWG	
	220-240 VAC THREE PHASE 3 WIRE AND GROUND 50/60 HZ	CURRENT 113 AMPS AT 230V, RECOMMENDED PROTECTION 150 AMPS, 1/0 [53.49] AWG	
	380-415 VAC THREE PHASE 3 WIRE AND GROUND 50/60 HZ	CURRENT 64 AMPS AT 400V, RECOMMENDED PROTECTION 80 AMPS, 4 [21.15] AWG	
	440-480 VAC THREE PHASE 3 WIRE AND GROUND 50/60 HZ	CURRENT 57 AMPS AT 460V, RECOMMENDED PROTECTION 80 AMPS, 4 [21.15] AWG	
STEAM GENERATOR CONTROL (GE1)	120 VAC SINGLE PHASE 2 WIRE AND GROUND 50/60 HZ	CURRENT 10 AMPS, RECOMMENDED PROTECTION 20 AMPS, #12 [3.31] AWG	
NETWORK (N)	AREA NETWORK	100/1000 BASE T SUPPORTING TCP/IP PROTOCOL RJ45F CONNECTION	
POWER CONSUMPTION PER CYCLE	26" X 26" X 39" LG	12.3 KWH	
	26" X 26" X 51" LG	15.8 KWH	
	26" X 26" X 63" LG	19.3 KWH	

#### REQUIREMENT NOTES:

CIRCUIT BREAKER IS REQUIRED. INSTALL NEAR EQUIPMENT WITHIN EASY REACH OF THE OPERATOR AND MARKED AS 'DISCONNECTING DEVICE' FOR THE EQUIPMENT.

#### NETWORK CONNECTION (IF APPLICABLE):

- ACTIVE NETWORK DROP WITH CAT 5/6 CABLE WITHIN 10' OF UNIT
- STATIC OR DHCP RESERVED IP ADDRESS (FOR EACH UNIT)
- NETWORK CABLE SUPPLIED BY FACILITY




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EQUIPMENT DRAWING, AMSCO 600 , 26.5" X 26.5" X 39", 51" & 63" LG.  
SLIDING, SD, CABINET, ELECTRIC STEAM GENERATOR

SIZE:  
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SCALE:  
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DRAWN BY:  
Gosha, Deon

DRAWING NUMBER:  
10778442

PART NUMBER:  
11008531

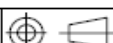REVISION:  
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# WinnMed

## PHYSICAL

### SPECIFICATIONS CHART

CURB WEIGHT	39" LG - 2327 LBS (1056 KG)	1. LEVELING FEET ARE PROVIDED FOR PROPER INSTALLATION. STERILIZER MUST BE LEVELED DURING INSTALLATION. CHECK LEVELNESS FRONT TO BACK, SIDE TO SIDE, AND DIAGONAL.  2. STERIS DOES NOT ASSUME ANY RESPONSIBILITY FOR CHANGES MADE NECESSARY THROUGH FAILURE TO OBSERVE THE SPECIFICATIONS ON THE EQUIPMENT DRAWING AND NOTE SHEETS. SPECIFICATIONS AND DESCRIPTIONS ARE SUBJECT TO CHANGE WITHOUT NOTICE.  3. BASED ON CHAMBER FULLY LOADED WITH INSTRUMENTS.
	51" LG - 2587 LBS (1173 KG)	
	63" LG - 2842 LBS (1289 KG)	
MAXIMUM OPERATING WEIGHT SEE NOTE 3	39" LG - 2600 LBS (1179 KG)	
	51" LG - 2935 LBS (1331 KG)	
	63" LG - 3265 LBS (1481 KG)	
SHIPPING WEIGHT	39" LG - 2877 LBS (1305 KG)	
	51" LG - 3137 LBS (1423 KG)	
	63" LG - 3432 LBS (1557 KG)	
SHIPPING DIMENSIONS W x H x L	39" LG - 62 1/2" W x 89 1/4" H x 79 1/2" L [1588 W x 2267 H x 2019 L]	
	51" LG - 62 1/2" W x 89 1/4" H x 79 1/2" L [1588 W x 2267 H x 2019 L]	
	63" LG - 62 1/2" W x 89 1/4" H x 91 1/2" L [1588 W x 2267 H x 2324 L]	
HEAT LOSS AT 21°C (70°F)	HEAT LOSS	
939V-1	9600 BTU (10129 kJ)	
1251V-1	10400 BTU (10973 kJ)	
1563V-1	11300 BTU (11922 kJ)	
NOISE LEVEL	64 dB A	

### ADDITIONAL INSTALLATION SPECIFICATIONS NOTES

- A. INSTALLATION SPECIFICATION IS LISTED AS ENGINEERING AND INSTALLATION GUIDES. REFERENCED COMPONENTS AND SERVICE CONNECTIONS ARE NOT FURNISHED AS PART OF EQUIPMENT UNLESS INSTALLATION IS QUOTED SEPERATELY AND TO BE PERFORMED BY STERIS.
- B. PROVIDE GROUPED OR GANGED CIRCUIT PROTECTION AND DISCONNECT FOR STERILIZER POWER AS REQUIRED BY CODES AND STANDARDS. INDIVIDUAL POWER SHUTOFFS REQUIRED NEAR EACH MACHINE FOR SERVICING.
- C. PROVIDE GROUNDED METAL CONDUIT AND WIRING BETWEEN EQUIPMENT TERMINALS AND STUB OUTS OR DISCONNECTS. CHECK LOCAL CODES FOR MINIMUM AWG. WIRE SIZE, #16 AWG. MINIMUM RECOMMENDED.
- D. FOR GENERAL INSTALLATION INFORMATION SEE STERIS ADDENDUM (DRAWING 62941-091) ATTACHED TO THE END OF THIS DOCUMENT. (THIS DRAWING SHOULD ALWAYS ACCOMPANY THE EQUIPMENT DRAWINGS) IF DRAWING IS NOT INCLUDED, CONTACT STERIS SERVICE ENGINEERING AT 1-800-333-8848 FOR A COPY.
- E. EXTERNAL EMERGENCY SHUT-OFF SWITCHES, IF REQUIRED BY LOCAL AUTHORITIES, IS THE REQUIREMENT OF THE CUSTOMER.
- F. CUSTOMER TO PROVIDE A STAINLESS STEEL VALVE AT TERMINUS OF PLASTIC UTILITY LINES FOR UTILITY CONNECTIONS. STERIS WILL NOT CONNECT DIRECTLY TO PLASTIC OR PVC PIPE.




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EQUIPMENT DRAWING, AMSCO 600 , 26.5" X 26.5" X 39", 51" & 63" LG.  
SLIDING, SD, CABINET, ELECTRIC STEAM GENERATOR

SIZE:  
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SCALE:  
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DRAWN BY:  
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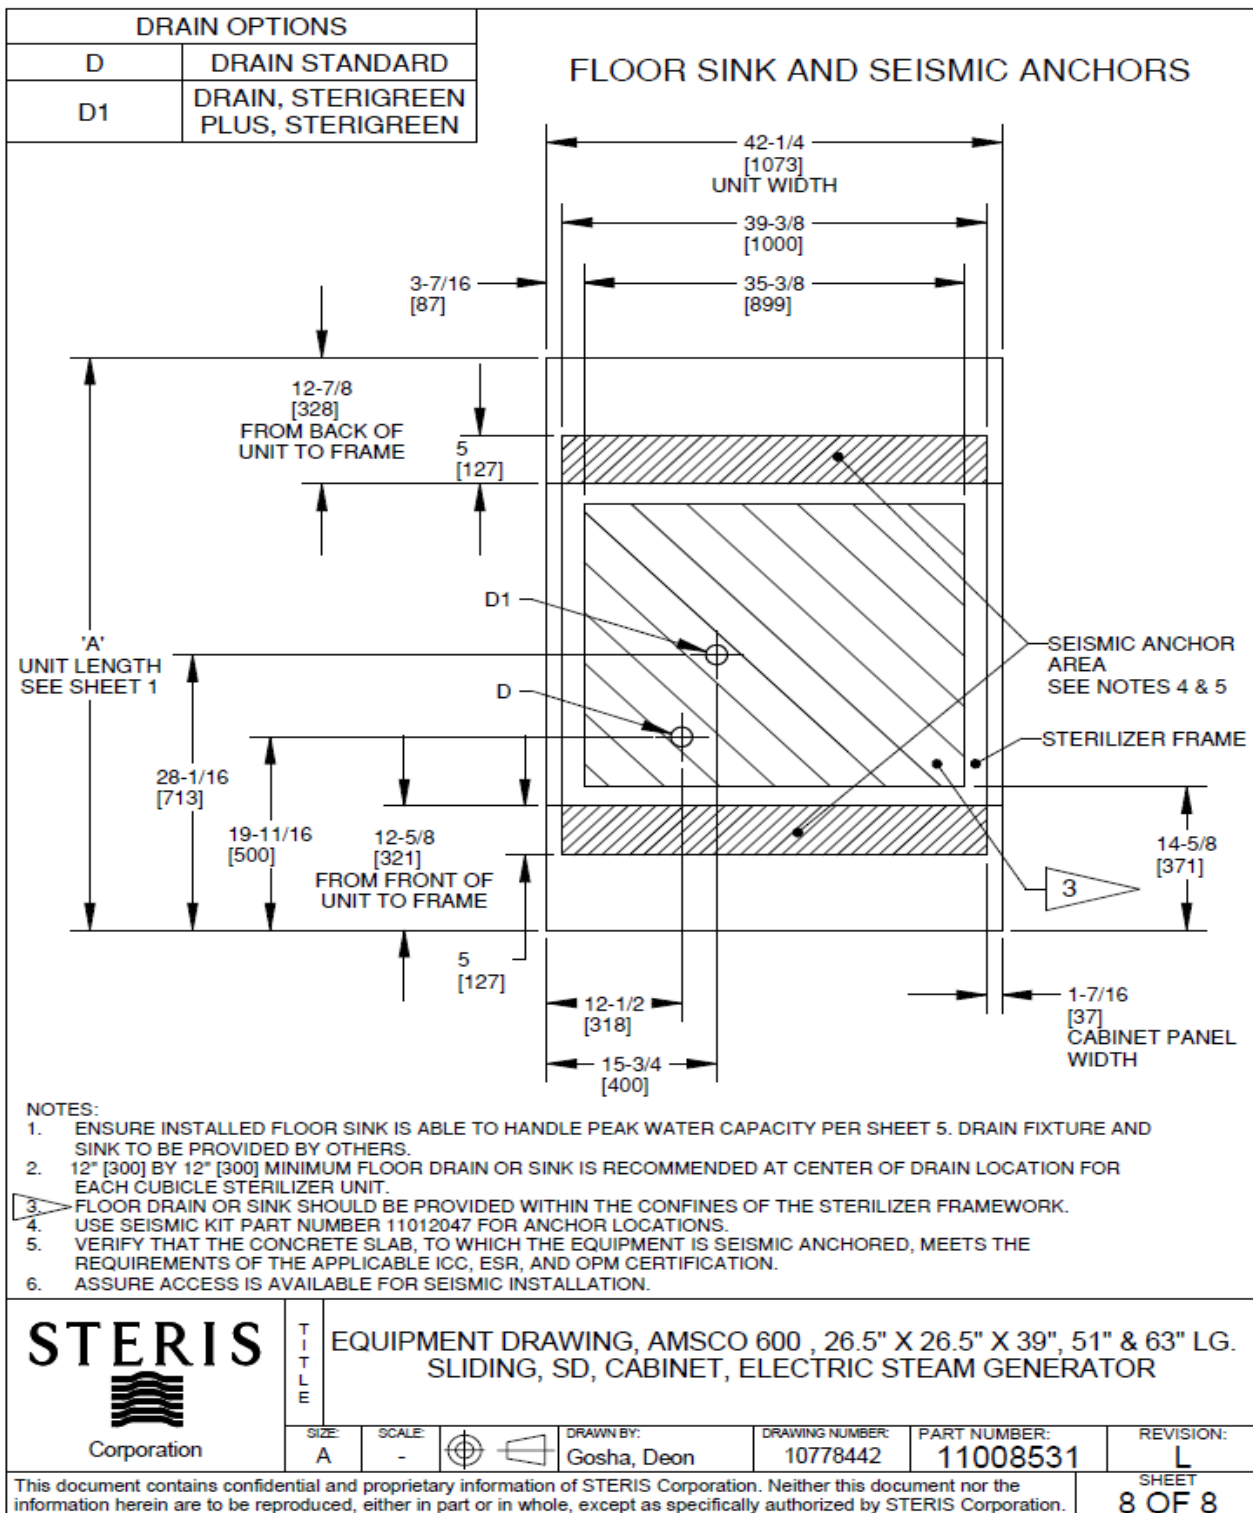
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# WinnMed



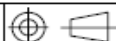

# WinnMed

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Issue Date:

3/6/2024

Expansion and Renovation

Decorah, IA 52101

Furniture Specifications

CONTACT:

Ben Stevens - CFO

PHONE NUMBER:

563-387-3109

ITEM NUMBER:	11
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ITEM NAME:	Sterilizer Transfer Carriage Cart		
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ROOM NUMBER:		QUANTITY:	
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SPECIFICATION INFORMATION	
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MANUFACTURER: Steris

MODEL #: AY1598104 & AY1596604

DIMENSIONS: Fixed Height transfer cart; 26" W x 63" D

DESCRIPTION: Fixed height transfer cart (qty 4); Loading Car with 2 Shelves (Qty 4)

FURNITURE & EQUIPMENT IMAGE
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# WinnMed



# WinnMed

WinnMed

Issue Date:

3/6/2024

Expansion and Renovation

Decorah, IA 52101

Furniture Specifications

CONTACT:

Ben Stevens - CFO

PHONE NUMBER:

563-387-3109

ITEM NUMBER:	12
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ITEM NAME:	Case Cart		
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ROOM NUMBER:		QUANTITY:	
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SPECIFICATION INFORMATION	
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MANUFACTURER: Steris

MODEL #: ACC243739

DIMENSIONS: 28.6" W x 47.3 " D x 39" H

DESCRIPTION: Stainless Steel Case Cart; Doors; locking casters; Integral Bumpers





FURNITURE & EQUIPMENT IMAGE
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# WinnMed



# WinnMed



## PHYSICAL SPECIFICATIONS

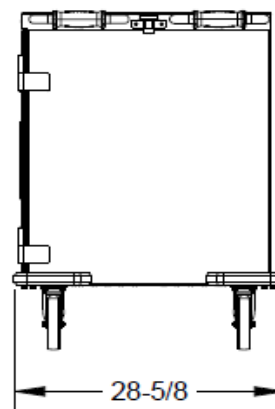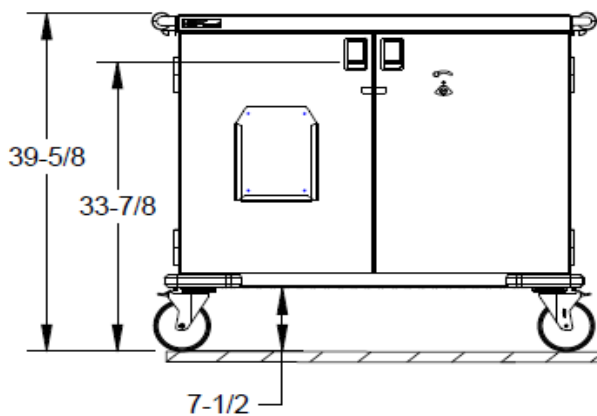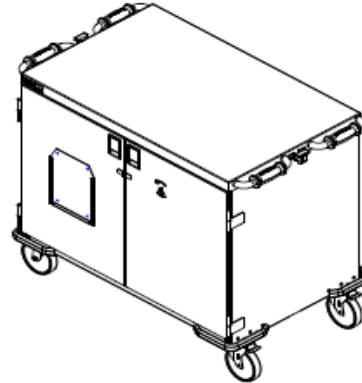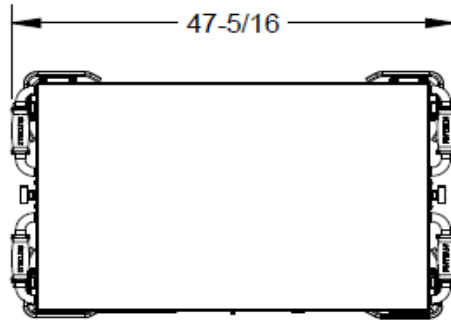SHIPPING DIMENSIONS W X L X H	30" x 56-1/2" x 43-3/8" [762mm x 1435mm x 1102mm]
SHIPPING WEIGHT	269 LBS [122kg]
OPERATING DIMENSIONS W X L X H	28-5/8" X 47-5/16" X 39-5/8" [727mm x 1202mm x 1006mm]
OPERATING WEIGHT EMPTY	220 LBS [100kg]
OPERATING TEMPERATURE	41° F TO 200° F [5° C TO 93° C]
MATERIAL	304 STAINLESS STEEL




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EQUIPMENT DRAWING, CASE CART, 28.6 X 47.3 X 39.6

SIZE:  
A

SCALE:  
1/400

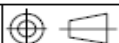

DRAWN BY:  
Anim, Kwaku

DRAWING NUMBER:  
ACC243739

PART NUMBER:  
11029739

REVISION:  
A

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SHEET  
1 OF 1

# WinnMed

WinnMed

Issue Date:

3/6/2024

Expansion and Renovation

Decorah, IA 52101

Furniture Specifications

CONTACT:

Ben Stevens - CFO

PHONE NUMBER:

563-387-3109

ITEM NUMBER:

13

ITEM NAME:

Cart Washer Universal Rack

ROOM NUMBER:

QUANTITY:

## SPECIFICATION INFORMATION

MANUFACTURER:

Steris

MODEL #:

FD372

DIMENSIONS:


DESCRIPTION:

Universal Rack for Cart Washer

## FURNITURE & EQUIPMENT IMAGE



# WinnMed

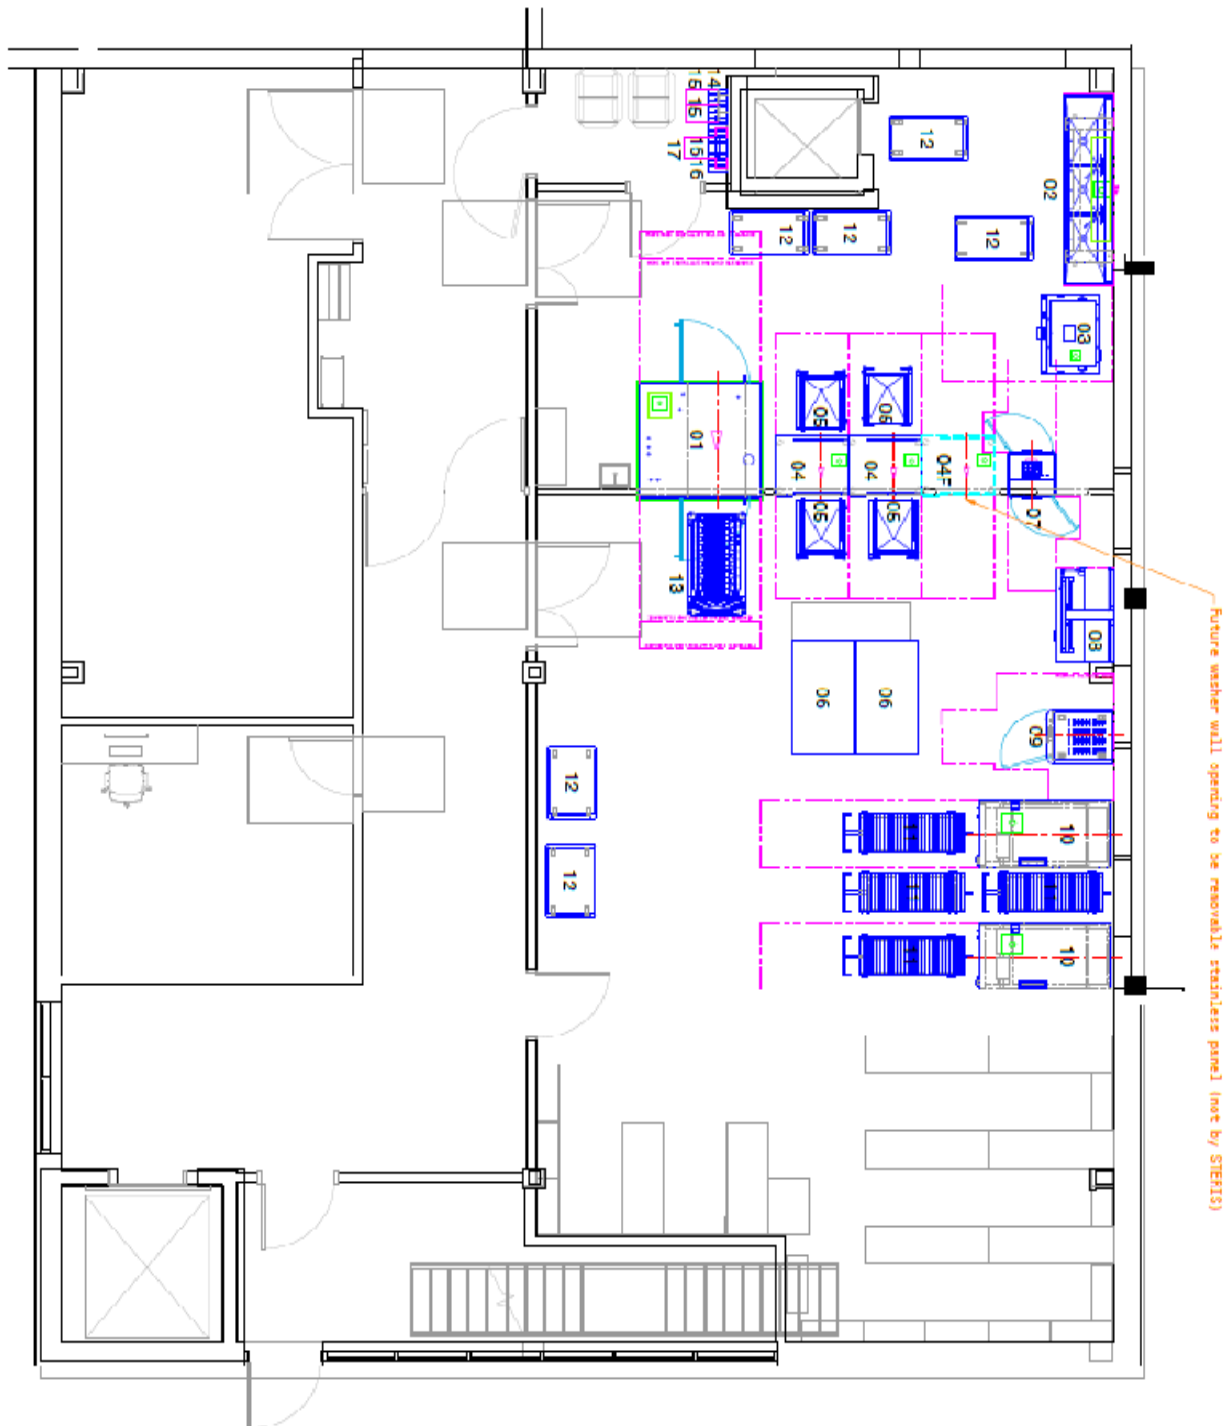

# WinnMed

WinnMed

Issue Date:

3/6/2024

Expansion and Renovation

Decorah, IA 52101

Furniture Specifications

CONTACT:

Ben Stevens - CFO

PHONE NUMBER:

563-387-3109

ITEM NUMBER:

14

ITEM NAME:

Acu-Hold System Rail

ROOM NUMBER:

QUANTITY:

## SPECIFICATION INFORMATION

MANUFACTURER:

Steris

MODEL #:

T635Q0

DIMENSIONS:

38"


DESCRIPTION:

Acu-Hold System Rail; 38"; Molded Plastic

## FURNITURE & EQUIPMENT IMAGE



# WinnMed

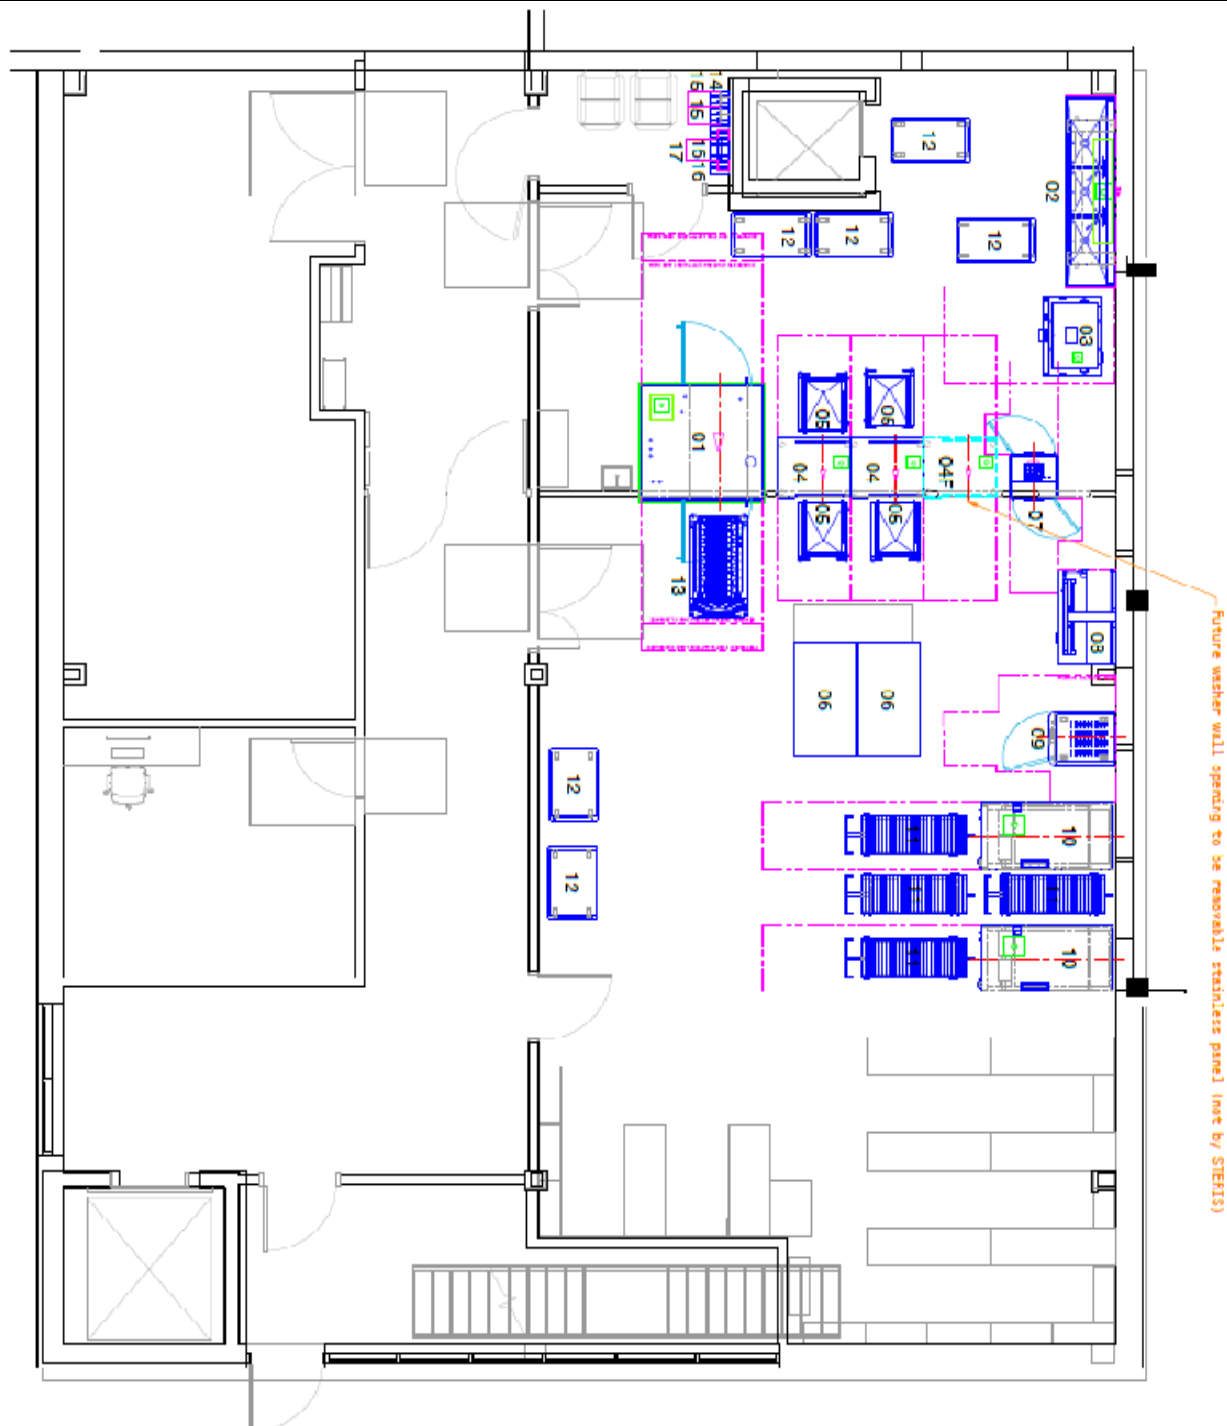

# WinnMed

WinnMed

Issue Date:

3/6/2024

Expansion and Renovation

Decorah, IA 52101

Furniture Specifications

CONTACT:

Ben Stevens - CFO

PHONE NUMBER:

563-387-3109

ITEM NUMBER:	15
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ITEM NAME:	Digital Radiography System		
ROOM NUMBER:		QUANTITY:	

## SPECIFICATION INFORMATION


MANUFACTURER: SHIMADZU


MODEL #: RSP-A65-702C

DIMENSIONS:

DESCRIPTION: Digital Radiography System; 65kW Generator; Touch Screen Console; Elevating Table; Ceiling Rail System; Auto Wall Bucky; Workstation w/ 24" Monitor; 3 Phase; 380-480 VAC; 75 KVA; Standard Table Cassette Tray & Housing

## FURNITURE & EQUIPMENT IMAGE

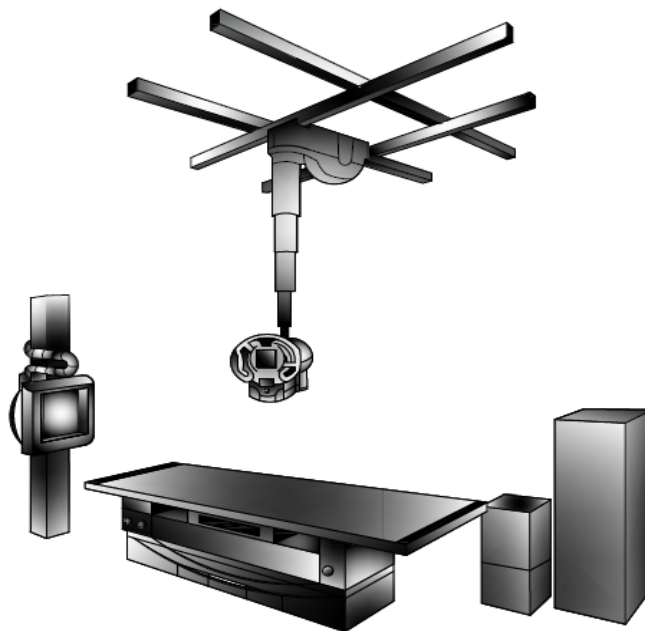


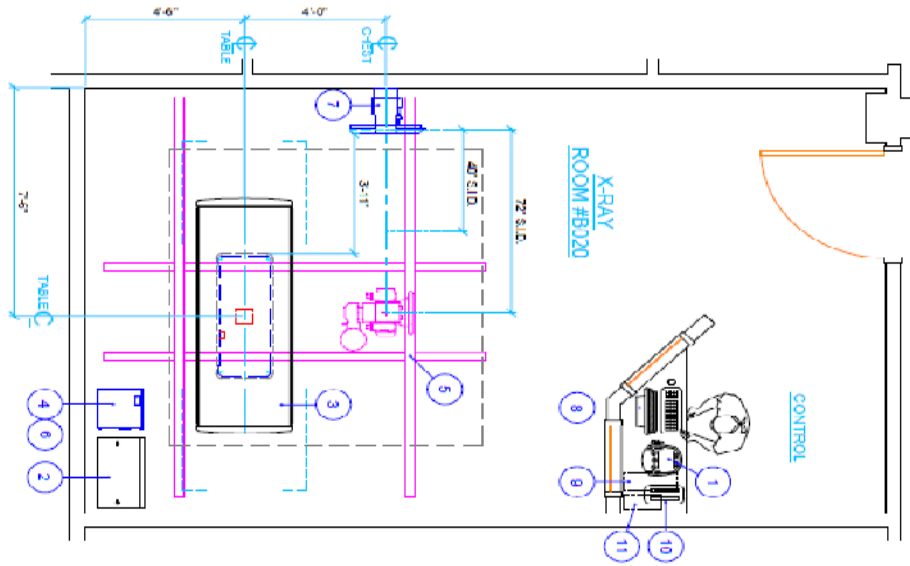


EQUIPMENT IDENTIFICATION NUMBER		WEIGHT (LBS.)	
BTU / HOUR		DIMENSIONS (IN.)	
DESCRIPTION		W	X C H
1	SHIMADZU J.D. 650-4 GEN X-RAY GENERATOR CONTROL CONSOLE	14.55	3.23 13.59
2	SHIMADZU J.D. 650-4 GEN X-RAY GENERATOR CONTROL CABINET <u>(INCLUDES KVL-2 TRAYED CONNECT)</u>	27.55	15.75 54.85
3	SHIMADZU 5K-200 ELEVATING RADIOGRAPHIC TABLE	52.50	32.31 149L
4	SHIMADZU 5K-200 TABLE ELECTRONIC CABINET (MOUNTED ON FLOOR)	15.75	15.49 13.81
5	SHIMADZU CHICK (4K X 3.5M VIALS) CABINETS MOUNTED TUBE SUPPORT	157.50	123.52 111.21
6	SHIMADZU CHICKEN TUBE SUPPORT ELECTRONIC CABINET (MOUNTED ON CABINET)	15.75	12.59 15.59
7	SHIMADZU 5K-100 VERTICAL WALL BUOXY	24.81	14.44 54.54
8	CANON MEDICAL SYSTEMS C-2000 SYSTEM FLAT SCREEN MONITOR AND STAND	11.81	19.75 21.50
9	CANON MEDICAL SYSTEMS C-2000 SYSTEM CONTROL PC UNIT WITH KEYBOARD AND MOUSE	6.00	16.00 16.00
10	CANON MEDICAL SYSTEMS C-2000 SYSTEM BATTERY CHARGER	6.50	5.00 2.50
11	CANON MEDICAL SYSTEMS C-2000 SYSTEM JRS	6.00	13.00 6.00



NOTE 1: C-2000 SYSTEM CONTROL CABINET SHOWN IN THIS DRAWING IS "UPPER RIGHT" INSTALLATION MUST ASSEMBLE IN THIS CONFIGURATION - REFER TO DETAIL PAGE 0-1

## CH-200 CEILING MOUNTED TUBE CRANE


### CH-200 - ASSEMBLY CONFIGURATIONS (FRONT VIEW OF VERTICAL COLUMN)

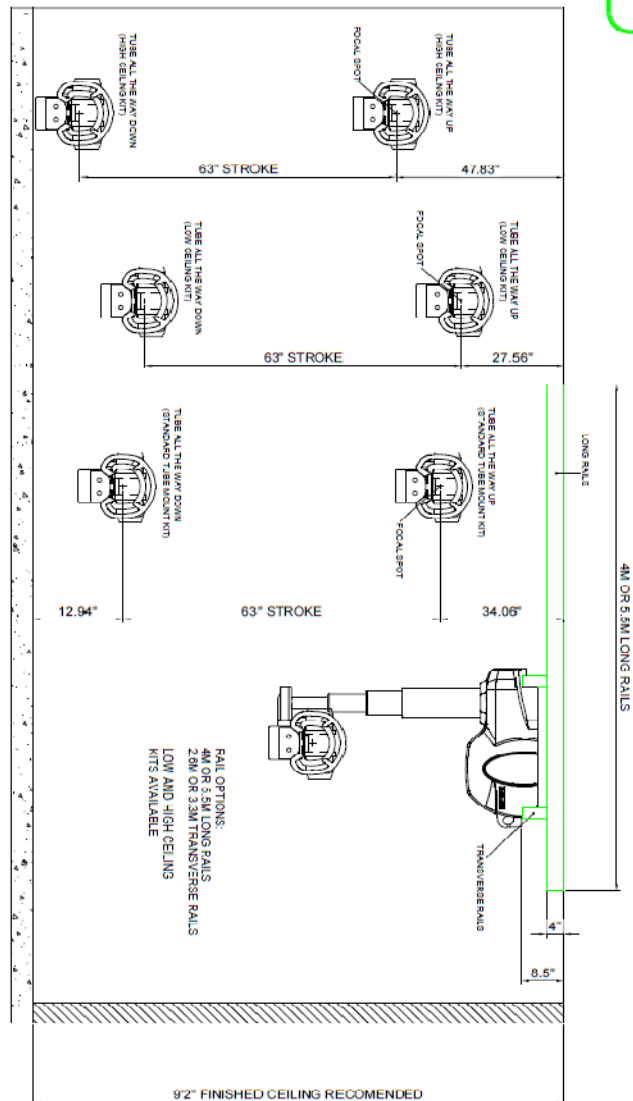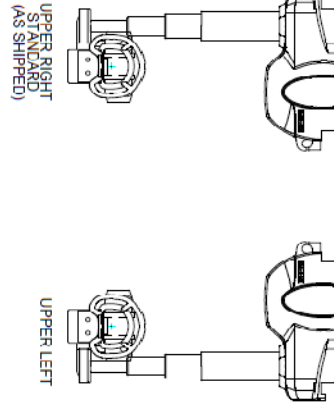


## CH-200 CEILING MOUNTED TUBE CRANE FRONT MOUNTED

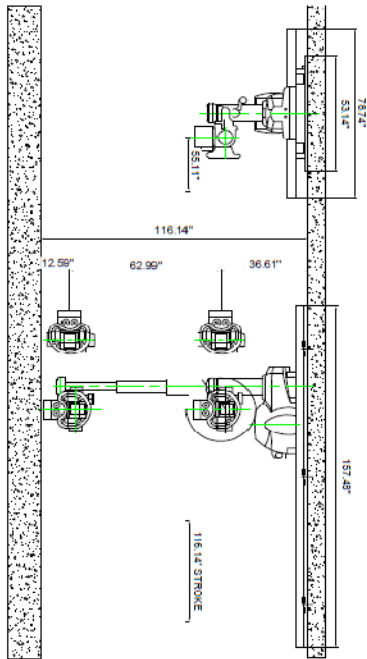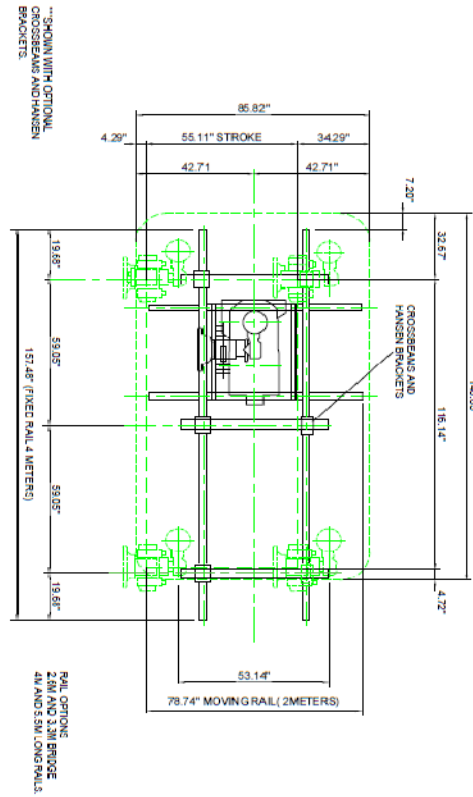

## BK-200 ELEVATING RADIOGRAPHIC TABLE

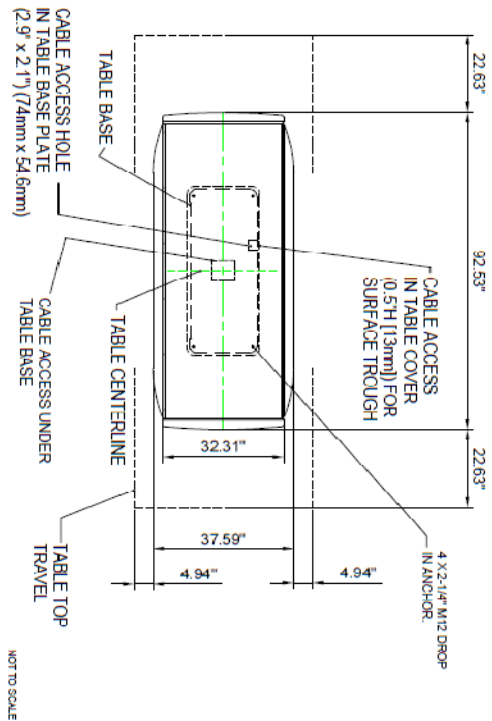


## BK-200 AND CH200 ELECTRONICS CABINETS

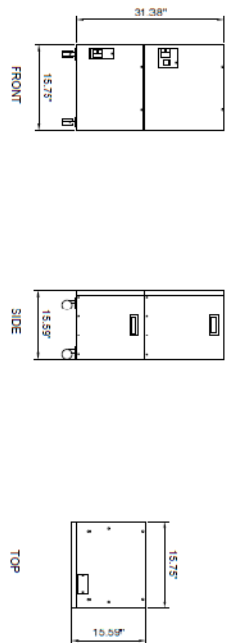

# WinnMed


## BR-120 VERTICAL BUCKY STAND

NOT TO SCALE

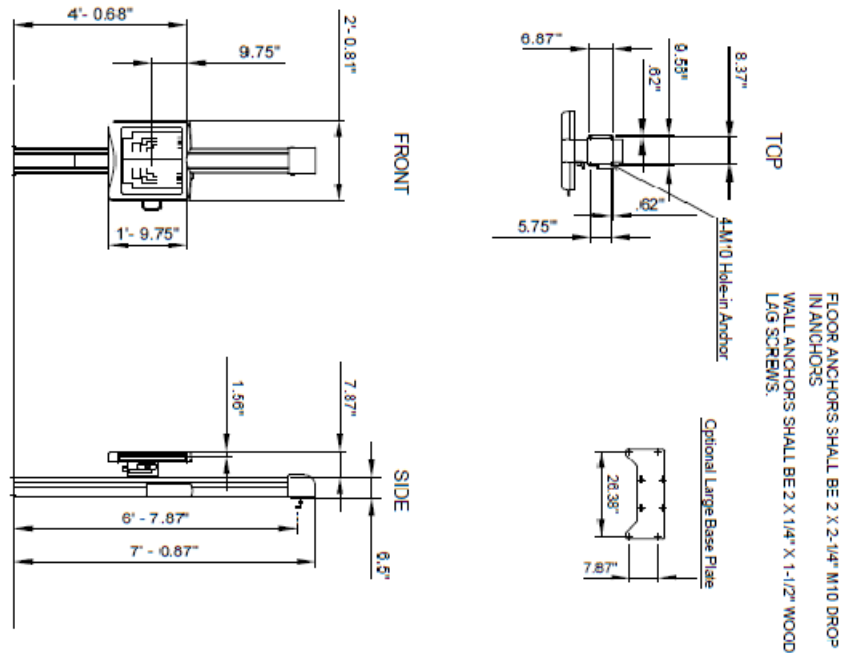


## UD150 X-RAY CONTROL CABINET

NOT TO SCALE

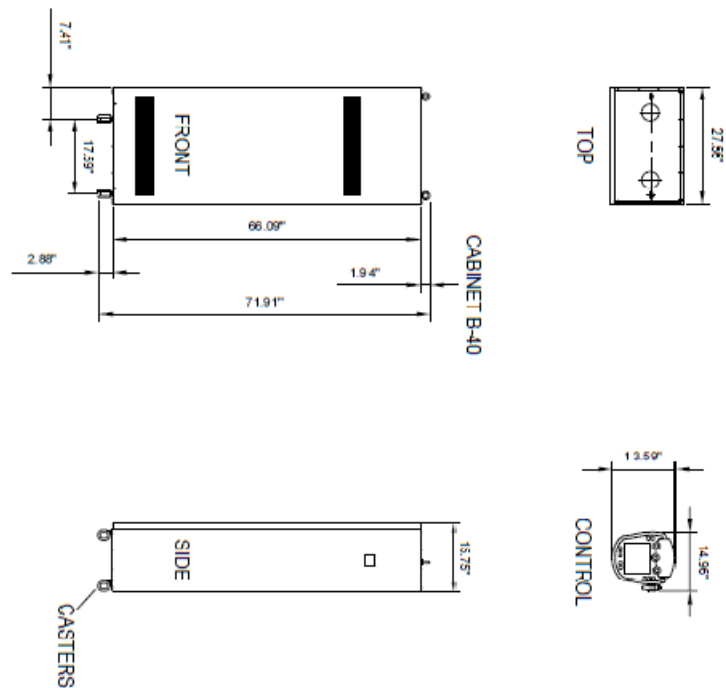


## ELECTRICAL LAYOUT PLAN VIEW

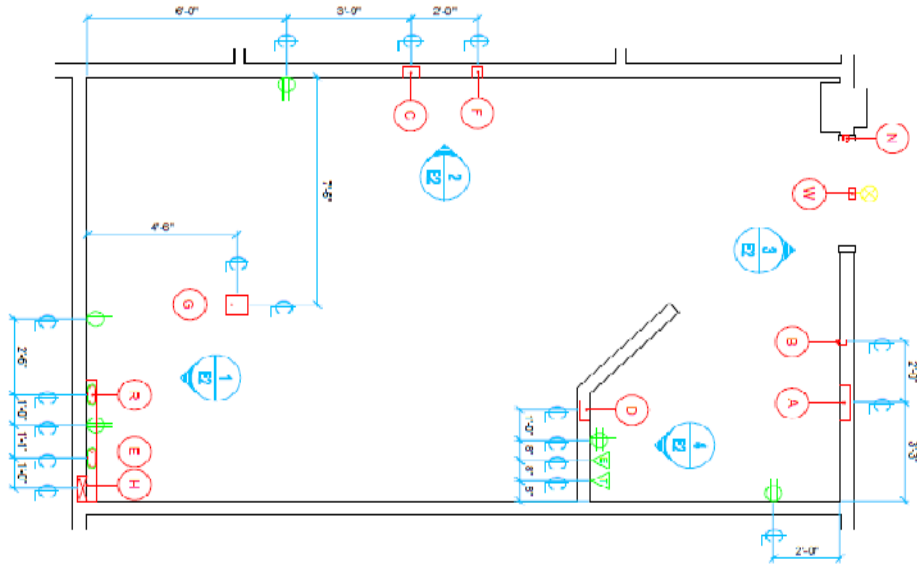

### TERMINAL SCHEDULE (CONTRACTOR FINISHED - CONTRACTOR INSTALLED)

ITEM	DESCRIPTION
(A)	FACILITY TO DETERMINE SOURCE LOCATION, NEWA 1, ENCLOSURE CONTAINING ONE ADVAC, THREE PHASE, FRONT OPERATED, 80AMP, 3-POLE THERMAL MAGNETIC CIRCUIT BREAKER WITH SHUNT TRIP DEVICE.
(B)	FLUSH MOUNTED IN WALL WHERE SHOWN, LOCATE ENCLOSURE CENTER LINE 8'-0" A.F.F. NOTE: EC SHALL, ENSURE THAT LUGS ARE LARGE ENOUGH TO FACILITATE OVERSIZED INCOMING CABLES REQUIRED BY X-RAY EQUIPMENT. REFER TO "INCOMING WIRE SIZE" NOTES.
(C)	4' x 2 1/2' DEEP SWITCH BOX, FLUSH MOUNT IN WALL WHERE SHOWN, LOCATE BOX CENTER LINE AT 8'-0" A.F.F. EG SHALL, PROVIDE ONE NONING SWITCH WITH RED WASH-ROOM HEAD AND AN EMERGENCY OFF PLATE. SWITCH TO BE USED ON SHUT TRIP DEVICE LOCATED ON MAIN CIRCULIT BREAKER 40V.
(D)	4' x 3' x 4' DEEP JUNCTION BOX, FLUSH MOUNT IN WALL WHERE SHOWN, LOCATE BOX CENTER LINE AT 38" A.F.F. PROVIDE COVER PLATE AS SHOWN IN COVER PLATE DETAIL.
(E)	4' x 3' x 4' DEEP JUNCTION BOX, FLUSH MOUNT IN WALL WHERE SHOWN, LOCATE BOX CENTER LINE AT 12" A.F.F. PROVIDE COVER PLATE AS SHOWN IN COVER PLATE DETAIL.
(F)	4' x 3' x 4' DEEP JUNCTION BOX, FLUSH MOUNT IN WALL WHERE SHOWN, LOCATE BOX CENTER LINE AT 12" A.F.F. PROVIDE COVER PLATE AS SHOWN IN COVER PLATE DETAIL.
(G)	4' x 3' x 4' DEEP JUNCTION BOX, FLUSH MOUNT IN WALL WHERE SHOWN, LOCATE BOX CENTER LINE AT 12" A.F.F. PROVIDE A BLANK OVER SIZE COVER PLATE. BOX OPENS OUT TO PROCEDURE ROOM NOT INTO CONTROL. CABLE ACCESS FOR THE WALL.
(H)	4' x 3' x 4' DEEP JUNCTION BOX, FLUSH MOUNT IN WALL WHERE SHOWN, LOCATE BOX CENTER LINE AT 12" A.F.F. PROVIDE A BLANK OVER SIZE COVER PLATE. BOX OPENS OUT TO PROCEDURE ROOM NOT INTO CONTROL. CABLE ACCESS FOR THE WALL.
(N)	4' x 3' x 4' DEEP JUNCTION BOX, FLUSH MOUNT IN WALL WHERE SHOWN, LOCATE BOX CENTER LINE AT 12" A.F.F. PROVIDE A BLANK OVER SIZE COVER PLATE. BOX OPENS OUT TO PROCEDURE ROOM NOT INTO CONTROL. CABLE ACCESS FOR THE WALL.
(R)	4' x 3' x 4' DEEP JUNCTION BOX, FLUSH MOUNT IN WALL WHERE SHOWN, LOCATE BOX CENTER LINE AT 12" A.F.F. PROVIDE A BLANK OVER SIZE COVER PLATE. BOX OPENS OUT TO PROCEDURE ROOM NOT INTO CONTROL. CABLE ACCESS FOR THE WALL.
(W)	4' x 3' x 4' DEEP JUNCTION BOX, FLUSH MOUNT IN WALL WHERE SHOWN, LOCATE BOX CENTER LINE AT 12" A.F.F. PROVIDE A BLANK OVER SIZE COVER PLATE. BOX OPENS OUT TO PROCEDURE ROOM NOT INTO CONTROL. CABLE ACCESS FOR THE WALL.

# WinnMed

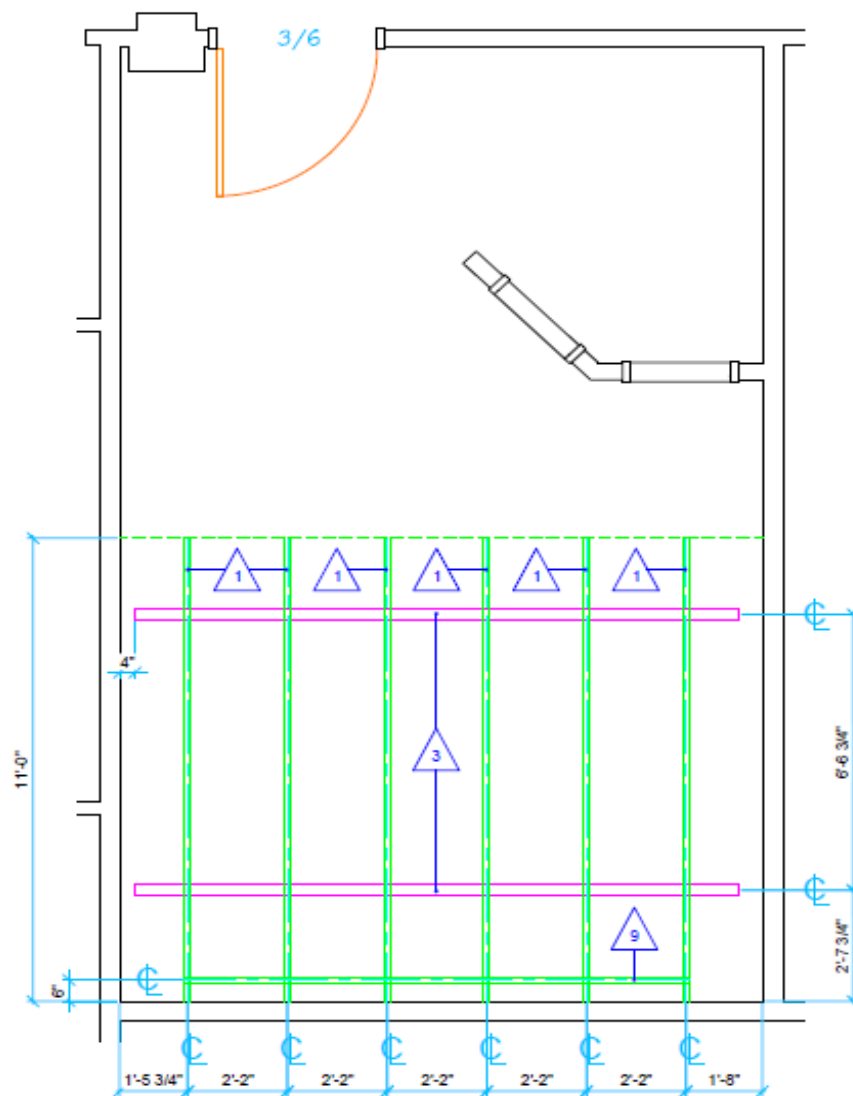

## PROPOSED UNISTRUT LAYOUT

REQUIRED FINISHED CEILING HEIGHT IS 9'-2"



# WinnMed

## SUPPORT NOTES

( CONTRACTOR FURNISHED - CONTRACTOR INSTALLED )

THE EQUIPMENT REPRESENTATIVE OR THEIR DESIGNER IS IN NO WAY RESPONSIBLE FOR THE SUPPORT STRUCTURE FOR ANY OVERHEAD CEILING MOUNTED EQUIPMENT / DEVICES OR WALL MOUNTED EQUIPMENT / DEVICES. THIS IS THE RESPONSIBILITY OF THE CONSTRUCTION PARTICIPANTS.

### UNISTRUT:

1. ALL UNISTRUT (OR EQUIVALENT) , ALL STEEL WORK AND ALL OTHER PARTS NECESSARY TO SUPPORT CEILING MOUNTED TUBE HANGER OR OTHER CEILING SUSPENDED EQUIPMENT SHALL BE PROVIDED BY AND INSTALLED BY CONTRACTOR. CONSIDER INSTALLING UNISTRUT CHANNELS WALL TO WALL TO FACILITATE FUTURE EQUIPMENT. UNISTRUT CHANNEL SHALL BE PARALLEL, SQUARE AND IN SAME HORIZONTAL PLANE. THE SYSTEM IS TO BE CROSS BRACED VERTICALLY, HORIZONTALLY, AND DIAGONALLY TO ALLOW NO MOVEMENT AND A MAXIMUM OF 1/16" DEFLECTION. THE RECOMMENDED HEIGHT ABOVE THE FINISHED FLOOR TO THE BOTTOM TO THE UNISTRUT IS SPECIFIED ON THIS PLAN.
2. CONTRACTOR SHALL SUPPLY 30 (UNISTRUT PART NUMBER P1008) 3/8" SPRINGNUTS, 30 (5 GRADE HARDNESS, ZINC PLATED) 3/8" X 1-1/2"-16 SOCKET HEAD CAP SCREWS, 30 3/8" LOCK WASHERS AND 5 (P2751) TROLLEY ASSEMBLIES PER X-RAY ROOM.
3. CONTRACTOR SHALL SUPPLY CLOSURE STRIPS (P3184) FOR AREAS OF UNISTRUT EXPOSED AND WITHOUT MOUNTING UNITS. THE CLOSURE STRIPS SHALL BE INSTALLED AFTER THE OVERHEAD RAILS HAVE BEEN SECURED IN PLACE BY THE EQUIPMENT INSTALLERS.
4. METHODS OF SUPPORT FOR THE STEELWORK THAT WILL PERMIT ATTACHMENT TO STRUCTURAL STEEL OR THROUGH BOLTS IN CONCRETE CONSTRUCTION SHOULD BE FAVORED. DO NOT USE SCREW ANCHORS IN DIRECT TENSION.
5. DO NOT USE SCREWS TO FASTEN CEILING GRID TO UNISTRUT. AN ALTERNATE METHOD SUCH AS TACK, SPOT WELDING, ETC. SHOULD BE CONSIDERED.
6. ALL UNISTRUT MEMBERS HAVE BEEN COORDINATED WITH THE X-RAY EQUIPMENT. ANY DEVIATION FROM THIS PLAN MUST BE APPROVED BY SIGNATURE THROUGH THE EQUIPMENT REPRESENTATIVE.
7. IT IS STRONGLY RECOMMENDED THAT A STRUCTURAL ENGINEER, IN CONJUNCTION WITH UNISTRUT REPRESENTATIVES, COORDINATE ANY UNISTRUT SUPPORT STRUCTURE.

### SUPPORTS:

1. ALL UNITS THAT ARE WALL MOUNTED OR CEILING SUSPENDED ARE TO BE PROVIDED WITH SUPPORTS STRUCTURES WHERE NECESSARY.
2. ALL SUPPORTS STRUCTURES ARE TO BE PROVIDED BY THE FACILITY OR THEIR CONTRACTOR.
3. WALL SUPPORTS ARE TO BE HIDDEN WITHIN WALLS WHENEVER POSSIBLE.
4. WALL SUPPORTS MAY NOT BE REQUIRED IF WALL MATERIAL IS ADEQUATE FOR THE LOADS GIVEN (I.e. BLOCK). CONSULTATION WITH A STRUCTURAL ENGINEER IS STRONGLY RECOMMENDED.
5. ALL SURFACE MOUNTED SUPPORTS ARE TO BE PAINTED THE SAME COLOR AS THE ADJACENT SURFACE OR CONSULT WITH FACILITY REGARDING ACCENT COLORS.

# WinnMed

WinnMed

Issue Date:

3/6/2024

Expansion and Renovation

Decorah, IA 52101

Furniture Specifications

CONTACT:

Ben Stevens - CFO

PHONE NUMBER:

563-387-3109

ITEM NUMBER:	16
--------------	----

ITEM NAME:	Ceiling Mount LED Exam Light		
ROOM NUMBER:		QUANTITY:	

## SPECIFICATION INFORMATION

MANUFACTURER: Stryker

MODEL #: CE-3863075


DIMENSIONS:

DESCRIPTION: 80,000 lux, 5 levels of intensity control, double arm; ceiling mount; soffit panel included; 8' ceiling height

## FURNITURE & EQUIPMENT IMAGE



# WinnMed

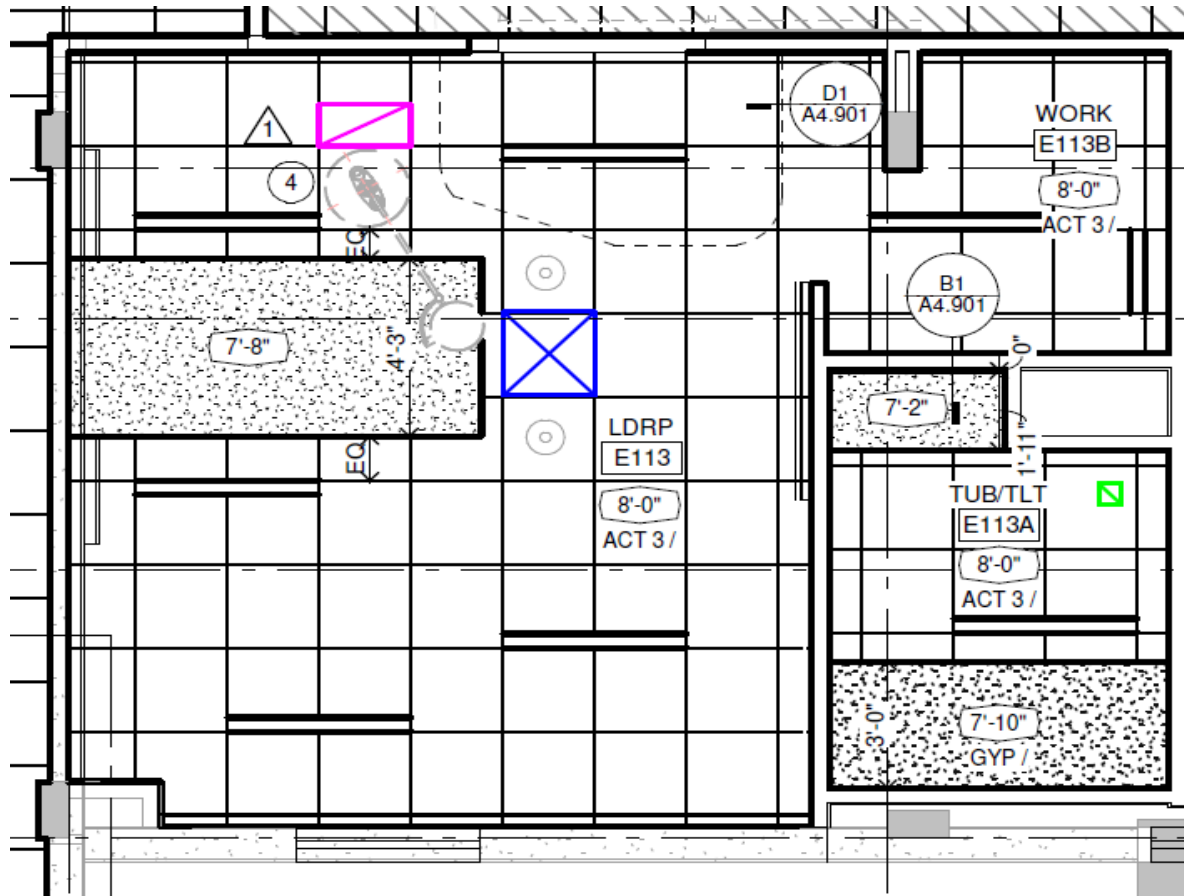

# WinnMed

WinnMed

Issue Date:

3/6/2024

Expansion and Renovation

Decorah, IA 52101

Furniture Specifications

CONTACT:

Ben Stevens - CFO

PHONE NUMBER:

563-387-3109

ITEM NUMBER:	17
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ITEM NAME:	BLANK		
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ROOM NUMBER:		QUANTITY:	
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SPECIFICATION INFORMATION	
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MANUFACTURER:

MODEL #:

DIMENSIONS:

DESCRIPTION:

FURNITURE & EQUIPMENT IMAGE
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# WinnMed

WinnMed

Issue Date:

3/6/2024

Expansion and Renovation

Decorah, IA 52101

Furniture Specifications

CONTACT:

Ben Stevens - CFO

PHONE NUMBER:

563-387-3109

ITEM NUMBER:	18
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ITEM NAME:	PreVac Single Sliding Sterilizer		
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ROOM NUMBER:		QUANTITY:	
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SPECIFICATION INFORMATION	
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MANUFACTURER: Steris


MODEL #: SR0101110311

DIMENSIONS: 16" x 16" x 26" Chamber Size


DESCRIPTION: Small Steam Sterilizer; 50 lbs tray capacity; 12 programmable cycles; vertical sliding door foot pedal activated; 30kW electric steam generator; 480V; single phase


FURNITURE & EQUIPMENT IMAGE
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AUTOCAD. DWG



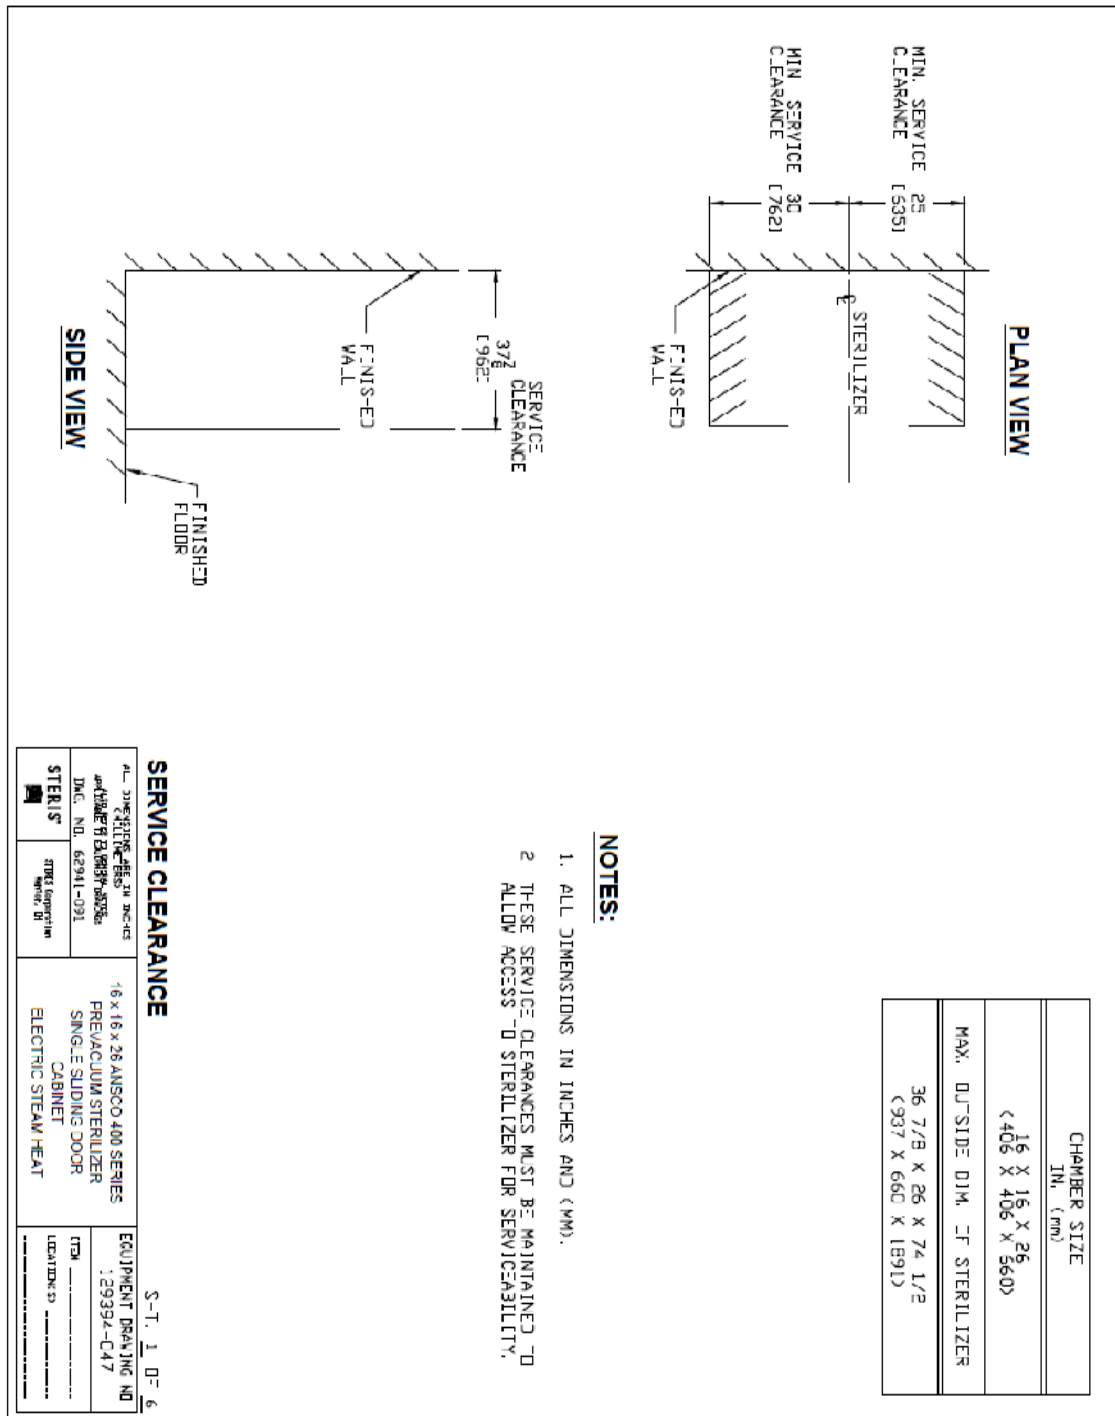

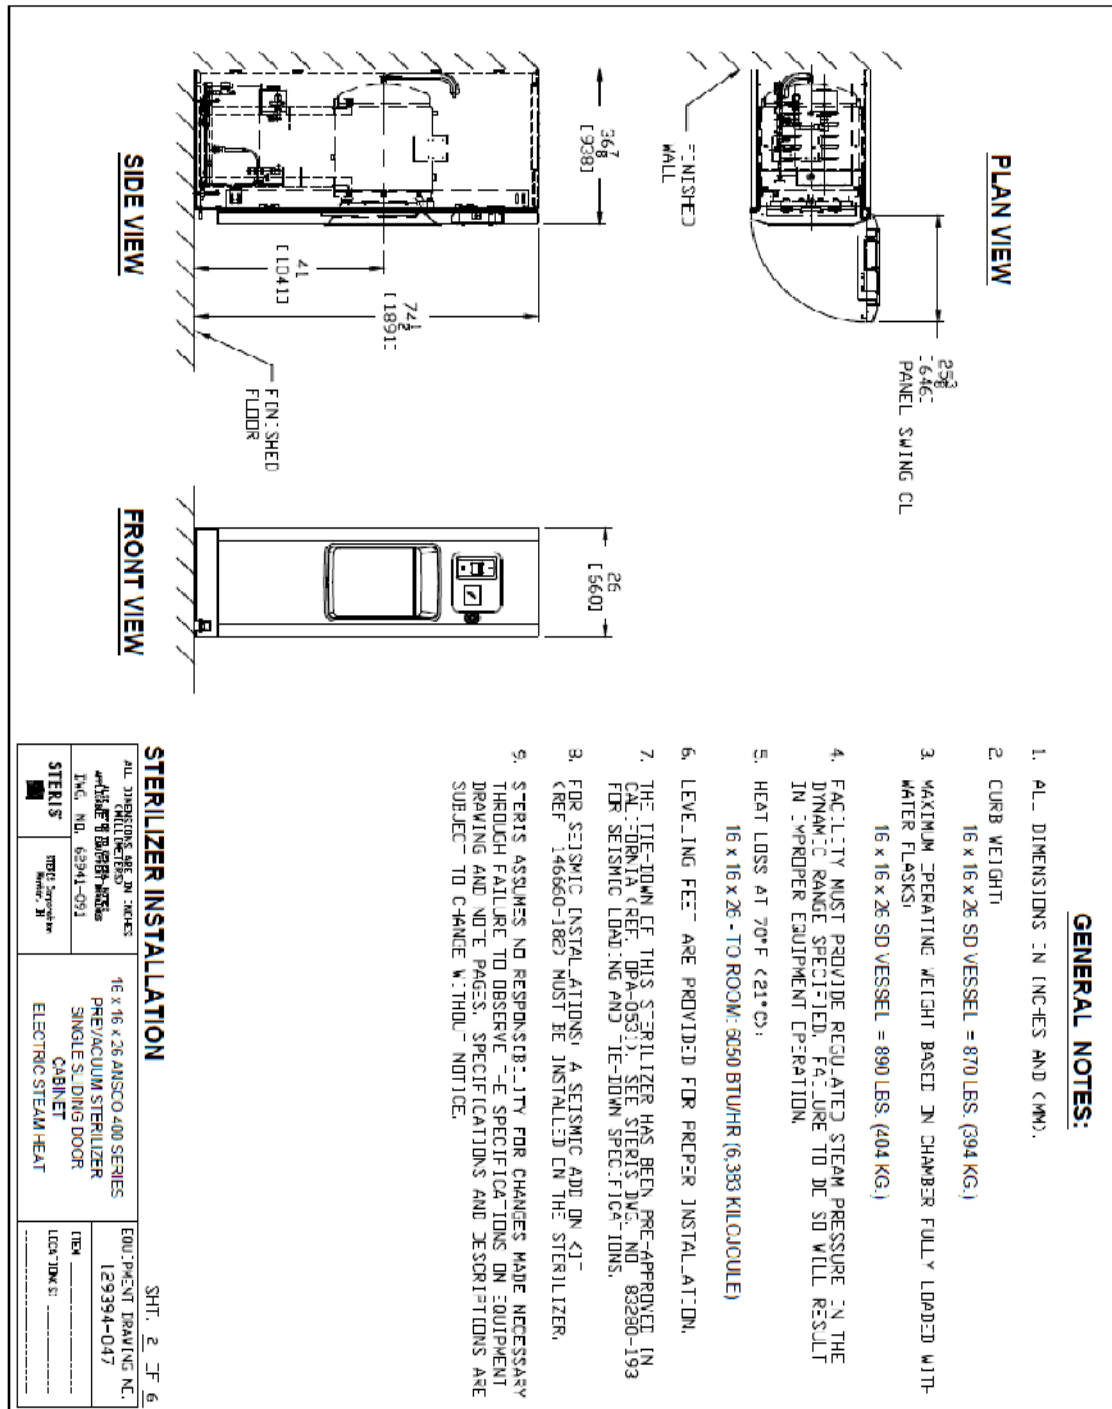

## INSTALLATION SPECIFICATIONS:

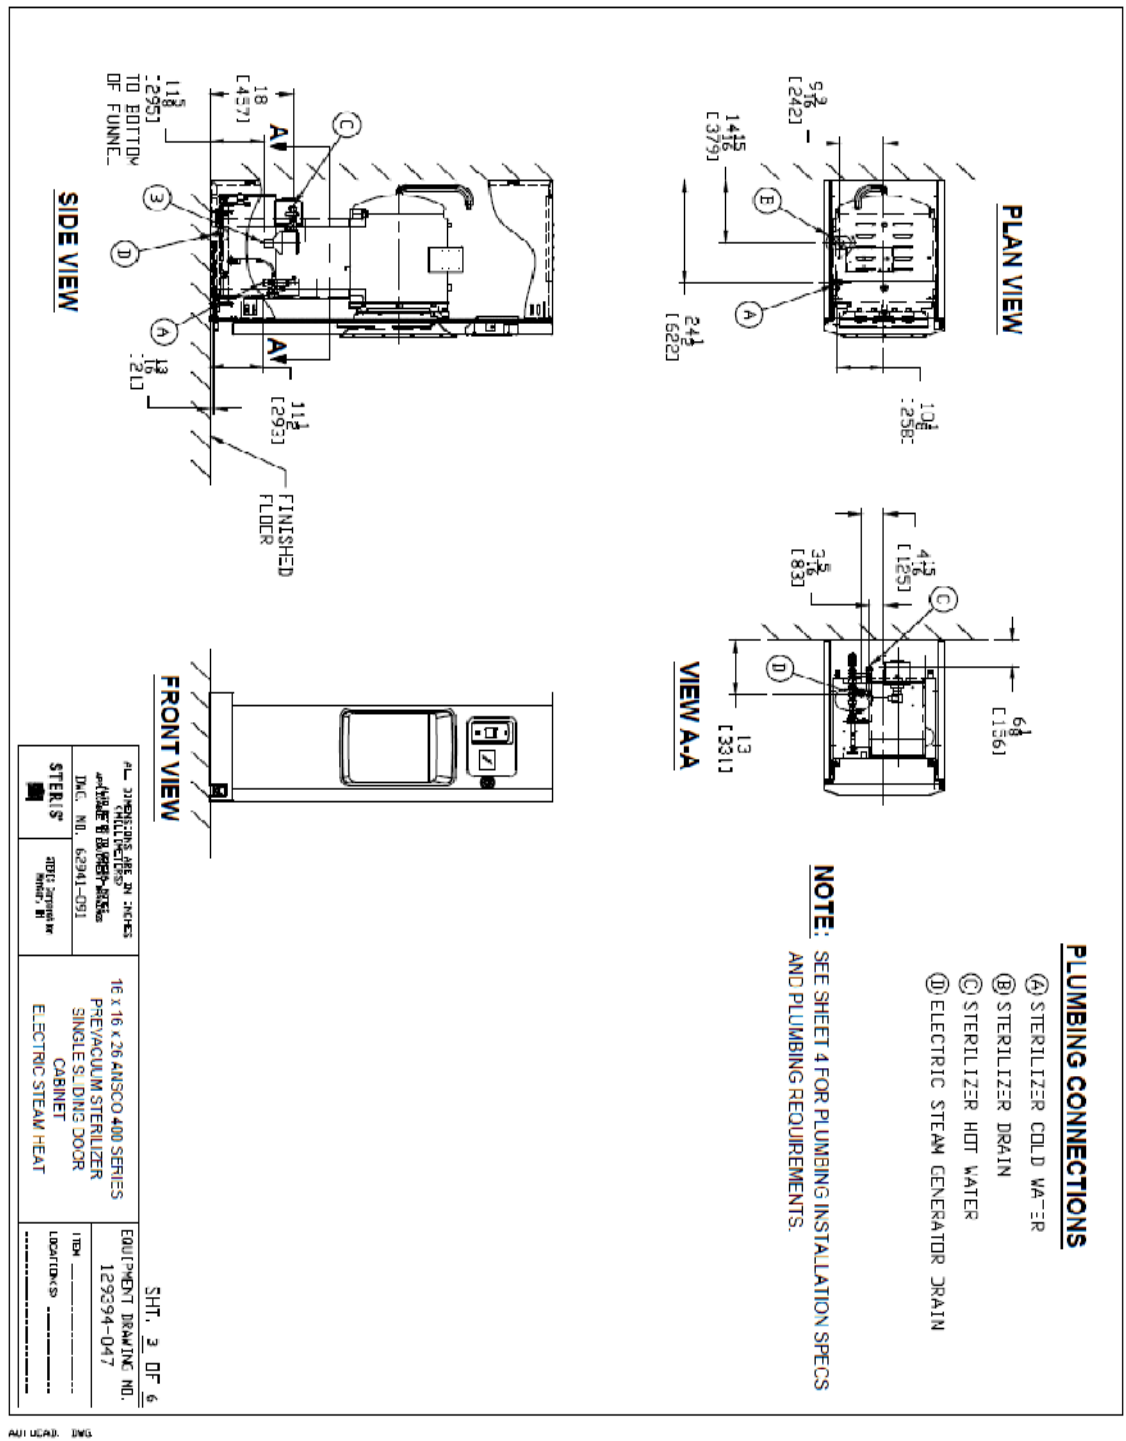THE INSTALLATION OF THE CHIMERON STERILIZER MUST MEET ALL APPLICABLE REGULATIONS.

INSTALLATION SPECIFICATION IS LISTED AS ENGINEERING AND INSTALLATION GUIDES. REFERENCED COMPONENTS AND SERVICE CONNECTIONS ARE NOT TURNISHED AS PART OF EQUIPMENT UNLESS UNDER WRITTEN AGREEMENT WITH STERIS.

1. PIPE SIZES LISTED UNDER **PLUMBING REQUIREMENTS** INDICATE THE EQUIPMENT TERMINATION SIZES ONLY. SIZE PIPING TO EQUIPMENT DEPENDING ON LENGTH OF PIPE RUN FROM PRESSURE REGULATING STATION FOR STEAM LINE, AND MAIN WATER HEATERS. TO SUPPLY THE SPECIFIED SERVICE PRESSURE AND FLOW RATE AT EQUIPMENT TERMINALS, INCLUDE EFFECT OF CONCURRENT DRAW OF MULTIPLE UNIT INSTALLATIONS.

2. PROVIDE PIPING, SHUT-OFF VALVE, PIPE PLUGGED TEE, AND UNION IN STEAM AND WATER SUPPLY CONNECTIONS BETWEEN EQUIPMENT AND STOP DUTS. PLUGGED TEE CAN LATER BE USED FOR TEST PRESSURE GAUGE CONNECTION. ARRANGE CONNECTION PIPING TO ALLOW ACCESS TO MAJOR COMPONENTS AND ELECTRICAL CONTROL PANEL.

3. RECOMMEND PROVISION OF STOP DOWN VALVE AT EACH STEAM AND WATER STRAINER TO ENABLE STRAINER CLEAN OUT.

4. FOR RECOMMENDED FEED WATER QUALITY FOR STERILIZERS AND CARBON STEEL STEAM GENERATORS, SEE STERIS DWG. NO. 62941-091

5. STOP DOWN BUILDING STEAM AND WATER SUPPLY LINES BEFORE FINAL CONNECTION TO EQUIPMENT

6. THE STERILIZER IS NOT SUPPLIED WITH A VACUUM BREAKER OR BACKFLOW PREVENTER AND WHERE REQUIRED BY LOCAL CODES, INSTALLATION OF SUCH A DEVICE IN WATER LINE IS BY OTHERS.

7. FOR GENERAL INSTALLATION INFORMATION SEE STERIS DRAWING NO. 62941-091 (THIS DWG. SHOULD ALWAYS ACCOMPANY THE EQUIPMENT DWGS.) IF DWG. IS NOT ATTACHED, CONTACT STERIS SERVICE ENGINEERING AT 1-800-333-8848 TO OBTAIN A COPY

8. **PLACEMENT OF PIPING SHUTOFFS:** WHEN INSTALLING SHUTOFFS MUST BE LOCATED IN A SUITABLE LOCATION WITHIN LINE OF SIG-T AND CLEAR OF ANY OBSTRUCTIONS THAT WOULD PUT THE SERVICE PERSON IN HAZARDOUS ORDER TO SHUT IT OFF.

## PLUMBING REQUIREMENTS

(A) STERILIZER COLD WATER (SEE NOTE #4)  
SUPPLY TEMPERATURE REQUIREMENTS ARE 50-70°F (10-21°C). VACUUM EFFICIENCY IS REDUCED AT WATER TEMPERATURES ABOVE 70°F (21°C).

1" NPT  
30-50 PSIG DYNAMIC (2.1 TO 3.5 bar)

CONSUMPTION IN CYCLE

PEAK-15 gpm (57 lpm)

AVERAGE-135 gal/cycle (511 l/cycle)

CONSUMPTION DUT OF CYCLE

AVERAGE-12 gal/hr (4.76 l/hr)

**SFP CYCLES** REQUIRE A MINIMUM OF 40 PSIG COLD WATER PRESSURE.

(B) STERILIZER DRAIN:

1 1/2" DDT  
(FLOOR DRAIN CAPACITY MUST HANDLE PEAK WATER CONSUMPTION).

(C) STERILIZER HOT WATER (SEE NOTE #4)

SUPPLY TEMPERATURE REQUIREMENTS ARE < 140°F  
WATER RESISTIVITY NOT TO EXCEED 25000 OHMS/CM.

1/2" NPT

20-50 DYNAMIC PSIG (137.9-344.7 kPa)

CONSUMPTION PEAK 1 GPM, PER CYCLE 3 GAL, IDLE 1 GPM.


(D) DRAIN FROM ELECTRIC STEAM GENERATOR 1/2" DDT.

## CHECK ALL NATIONAL CODES AND STANDARDS-- 4 OF 6

ALL DIMENSIONS ARE IN INCHES UNLESS OTHERWISE SPECIFIED		EQUIPMENT DRAWING NO. 129354-047	
16 x 13 x 26 ANSICO 400 SERIES PREVACUUM STERILIZER SINGLE SLIDING DOOR CABINET		LOCATION: 51	
STERIS STERIS Corporation Mentor, OH		ELECTRIC STEAM HEAT	

AUTOCAD. DWG

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## INSTALLATION SPECIFICATIONS:

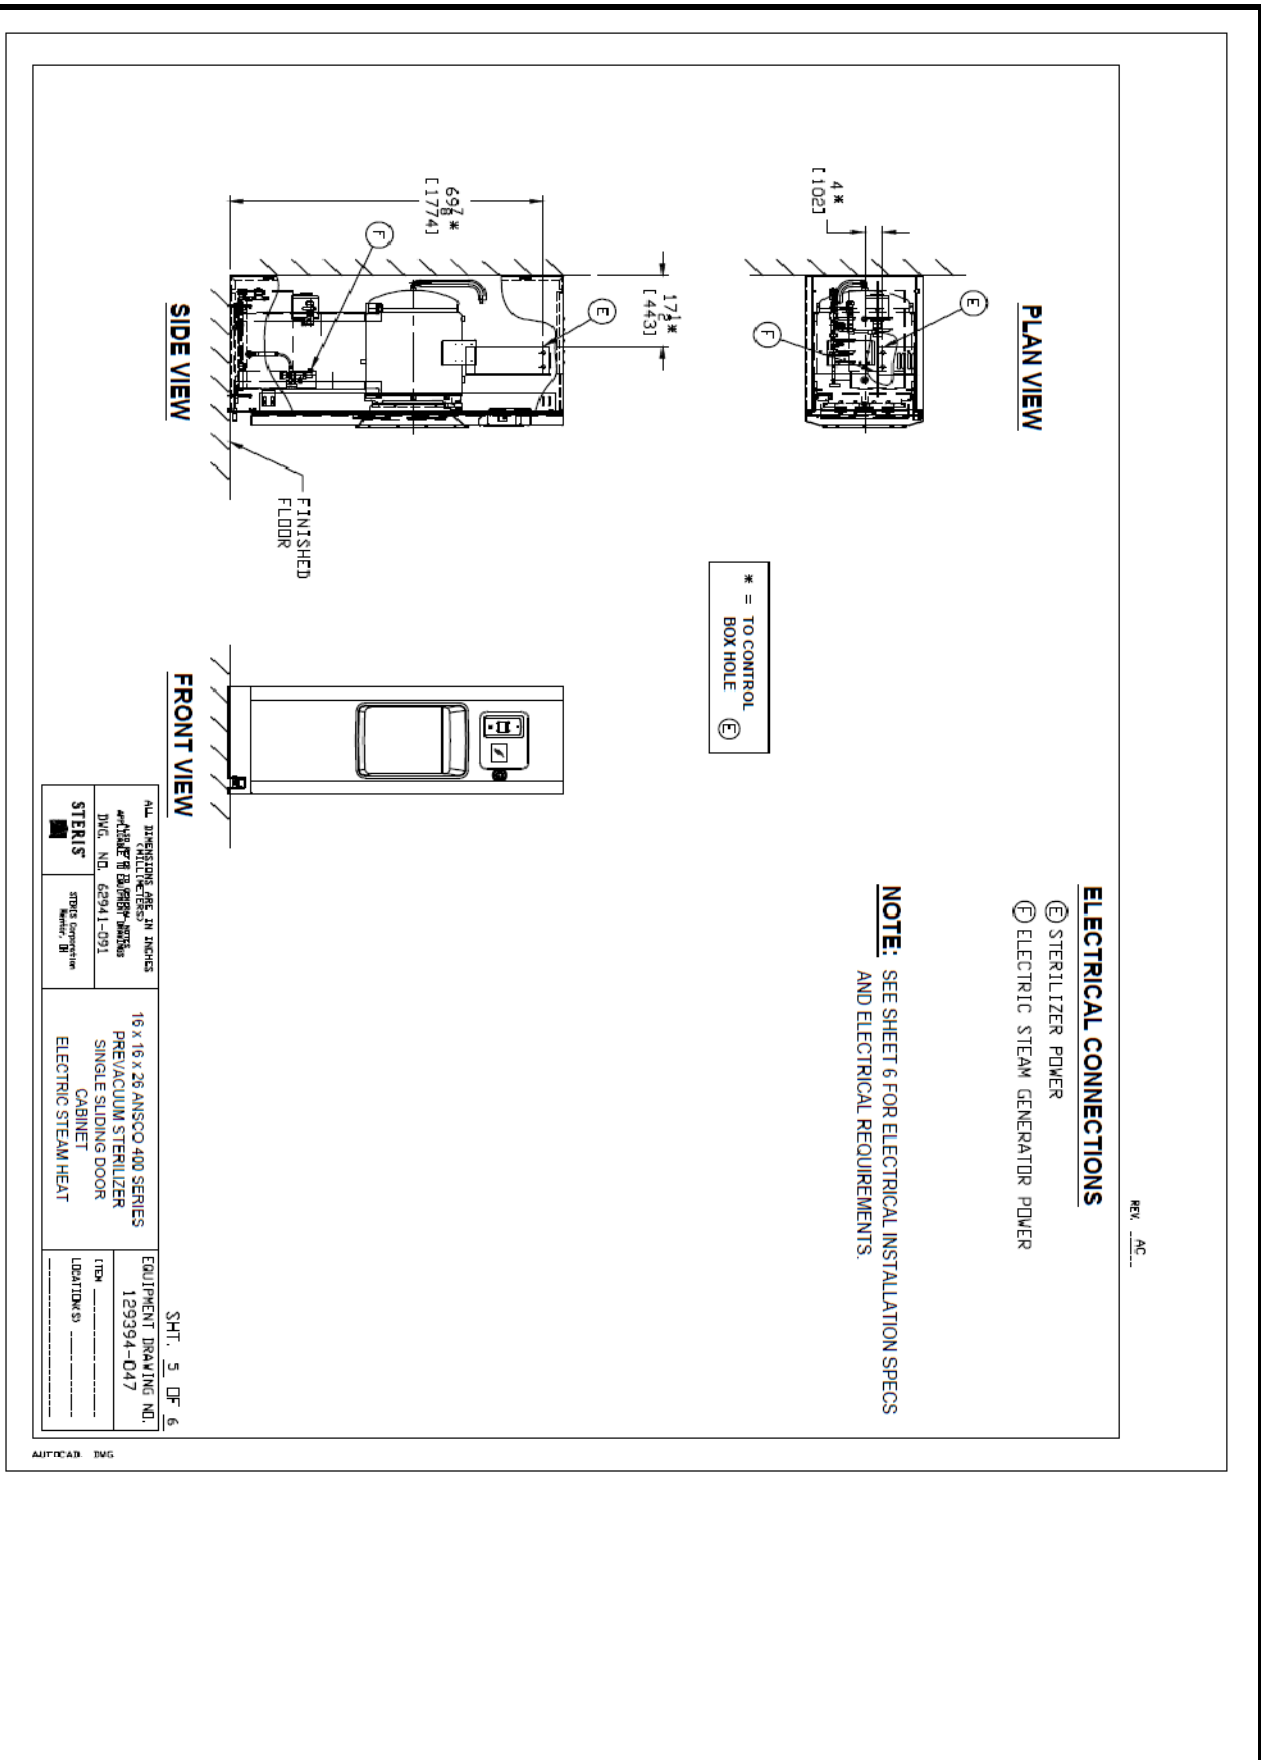THE INSTALLATION OF THE CHIMERON STERILIZER MUST MEET ALL APPLICABLE REGULATIONS.

INSTALLATION SPECIFICATION IS LISTED AS ENGINEERING AND INSTALLATION GUIDES. REFERENCED COMPONENTS AND SERVICE CONNECTIONS ARE NOT FURNISHED AS PART OF EQUIPMENT UNLESS UNDER WRITTEN AGREEMENT WITH STERIS.

1. PROVIDE GROUNDED OR GANGED CIRCUIT PROTECTION AND DISCONNECT FOR STEILIZER POWER AS REQUIRED BY CODES AND STANDARDS. INDIVIDUAL POWER SHUTOFFS REQUIRED NEAR EACH MACHINE FOR SERVICING.
2. PROVIDE GROUNDED METAL CONDUIT AND WIRING BETWEEN EQUIPMENT TERMINALS AND STUDS OR DISCONNECTS. CHECK LOCAL CODES FOR MINIMUM AVG. WIRE SIZE, #16 AVG. MINIMUM RECOMMENDED.
3. **PLACEMENT OF ELECT. DISCONNECTS:** WHEN INSTALLING DISCONNECTS MUST BE LOCATED IN A SUITABLE LOCATION WITHIN LINE OF SIGHT AND CLEAR OF ANY OBSTRUCTIONS THAT WOULD PUT THE SERVICE PERSON IN HARM'S WAY IN ORDER TO SHUT IT OFF. ALSO, THE LOCATION OF THE DISCONNECTS SHOULD ALLOW THE SERVICE PERSON TO SHUT OFF POWER FROM THE SIDE TO PREVENT POSSIBLE ARC FLASH.
4. **CAUTION:** DO NOT USE GROUND FAULT CURRENT INTERRUPTERS (GFCI).
5. **ATTENTION:** THE ELECTRICAL CLEARANCES REQUIRED BY THE NEC ARE THE RESPONSIBILITY OF THE INSTALLER. ALSO, ADHERENCE TO LOCAL CODES AND PROCUREMENT OF PERMITS ARE THE RESPONSIBILITY OF THE CUSTOMER UNLESS AGREED TO IN WRITING WITH STERIS.
6. FOR GENERAL INSTALLATION INFORMATION SEE STERIS DRAWING NO. 62941-091. CUSTOMER SHOULD ALWAYS ACCOMPANY THE EQUIPMENT INGS. IF DWG. IS NOT ATTACHED, CONTACT STERIS SERVICE ENGINEERING AT 1-800-333-8848 TO OBTAIN A COPY.

## ELECTRICAL REQUIREMENTS

### STERILIZER POWER:

CONTROL BOX FOR 120V, 50/60 HZ, 9.5 AMP SINGLE PHASE SERVICE. MINIMUM RECOMMENDED LINE AND GROUND CONDUCTOR SIZE AWG #12 COPPER (2.05MM).

120VAC REQUIRE A T-REE (3) WIRE CONNECTION (L1, NEUT, GND.).

MINIMUM 15A CIRCUIT BREAKER IS RECOMMENDED. INSTALLED NEAR THE EQUIPMENT WITHIN EASY REACH OF THE OPERATOR AND MARKED AS THE DISCONNECTING DEVICE FOR THE EQUIPMENT.

### ELECTRIC STEAM GENERATOR POWER:

30 KW HEATERS

208VAC, 50/60HZ, 83A, (3) PHASE. MINIMUM 90A CIRCUIT BREAKER RECOMMENDED. MINIMUM RECOMMENDED LINE CONDUCTOR SIZE AWG #3 COPPER (26.7 MM<sup>2</sup>) 75°C (167°F).  
REQUIRES A FOUR (4) WIRE DELTA CONNECTION (L1, L2, L3, GND.).

240VAC, 50/60HZ, 72A, (3) PHASE. MINIMUM 80A CIRCUIT BREAKER RECOMMENDED. MINIMUM RECOMMENDED LINE CONDUCTOR SIZE AWG #4 COPPER (21.5 MM<sup>2</sup>) 75°C (167°F).  
REQUIRES A FOUR (4) WIRE DELTA CONNECTION (L1, L2, L3, GND.).

480VAC, 50/60HZ, 36A, (3) PHASE. MINIMUM 45A CIRCUIT BREAKER RECOMMENDED. MINIMUM RECOMMENDED LINE CONDUCTOR SIZE AWG #8 COPPER (8.6 MM<sup>2</sup>) 75°C (167°F).  
REQUIRES A FOUR (4) WIRE DELTA CONNECTION (L1, L2, L3, GND.).

380/415VAC, 50/60HZ, 38/42A, (3) PHASE. MIN 50A CIRCUIT BREAKER RECOMMENDED. MINIMUM RECOMMENDED LINE CONDUCTOR SIZE AWG #8 COPPER (8.6 MM<sup>2</sup>) 75°C (167°F).  
REQUIRES A FOUR (4) WIRE DELTA CONNECTION (L1, L2, L3, GND.).

## CHECK ALL NATIONAL CODES AND STANDARDS SHOWN ON

<p>ALL REQUIREMENTS ARE IN INCHES</p> <p>APPLICABLE TO BOTH STERIS AND PREVAZ STERILIZERS</p> <p>DWG. NO. 52941-091</p>		<p>13 x 13 x 26 ANSCO 400 SERIES PREVAZ STERILIZER SINGLE SLIDING DOOR CABINET</p>		<p>EQUIPMENT DRAWING NO. 129354-047</p>
STERIS	NOTE: STERIS EQUIPMENT IS NOT A PART OF THE SYSTEM	ELECTRIC STEAM HEAT		<p>ITEM _____</p> <p>LOGBOOK NO. _____</p>

AUTOCAD. DWG.

# WinnMed

WinnMed

Issue Date:

3/6/2024

Expansion and Renovation

Decorah, IA 52101

Furniture Specifications

CONTACT:

Ben Stevens - CFO

PHONE NUMBER:

563-387-3109

ITEM NUMBER:

19

ITEM NAME:

Triple Bay Reprocessing Sink

ROOM NUMBER:

QUANTITY:

## SPECIFICATION INFORMATION

MANUFACTURER:

Steris

MODEL #:

SINK5097

DIMENSIONS:

97.5" W x 28 1/16" D x 33"-42" Working H


DESCRIPTION:

3 Basin adjustable height reprocessing sink; bay dimensions 30" w x 17" H x 10" D; (1) air pistol w/ tip attachment; (1) water pistol w/ tip attachment; (2) back splash-mounted pre-rinse/ faucet comb; (1) back splash-mounted treated water faucet and magnetic back splash; 120 V; 15A GFCI protected outlet requirement; Draws 3 amps; External Drain Lever Handles


## FURNITURE & EQUIPMENT IMAGE




# WinnMed

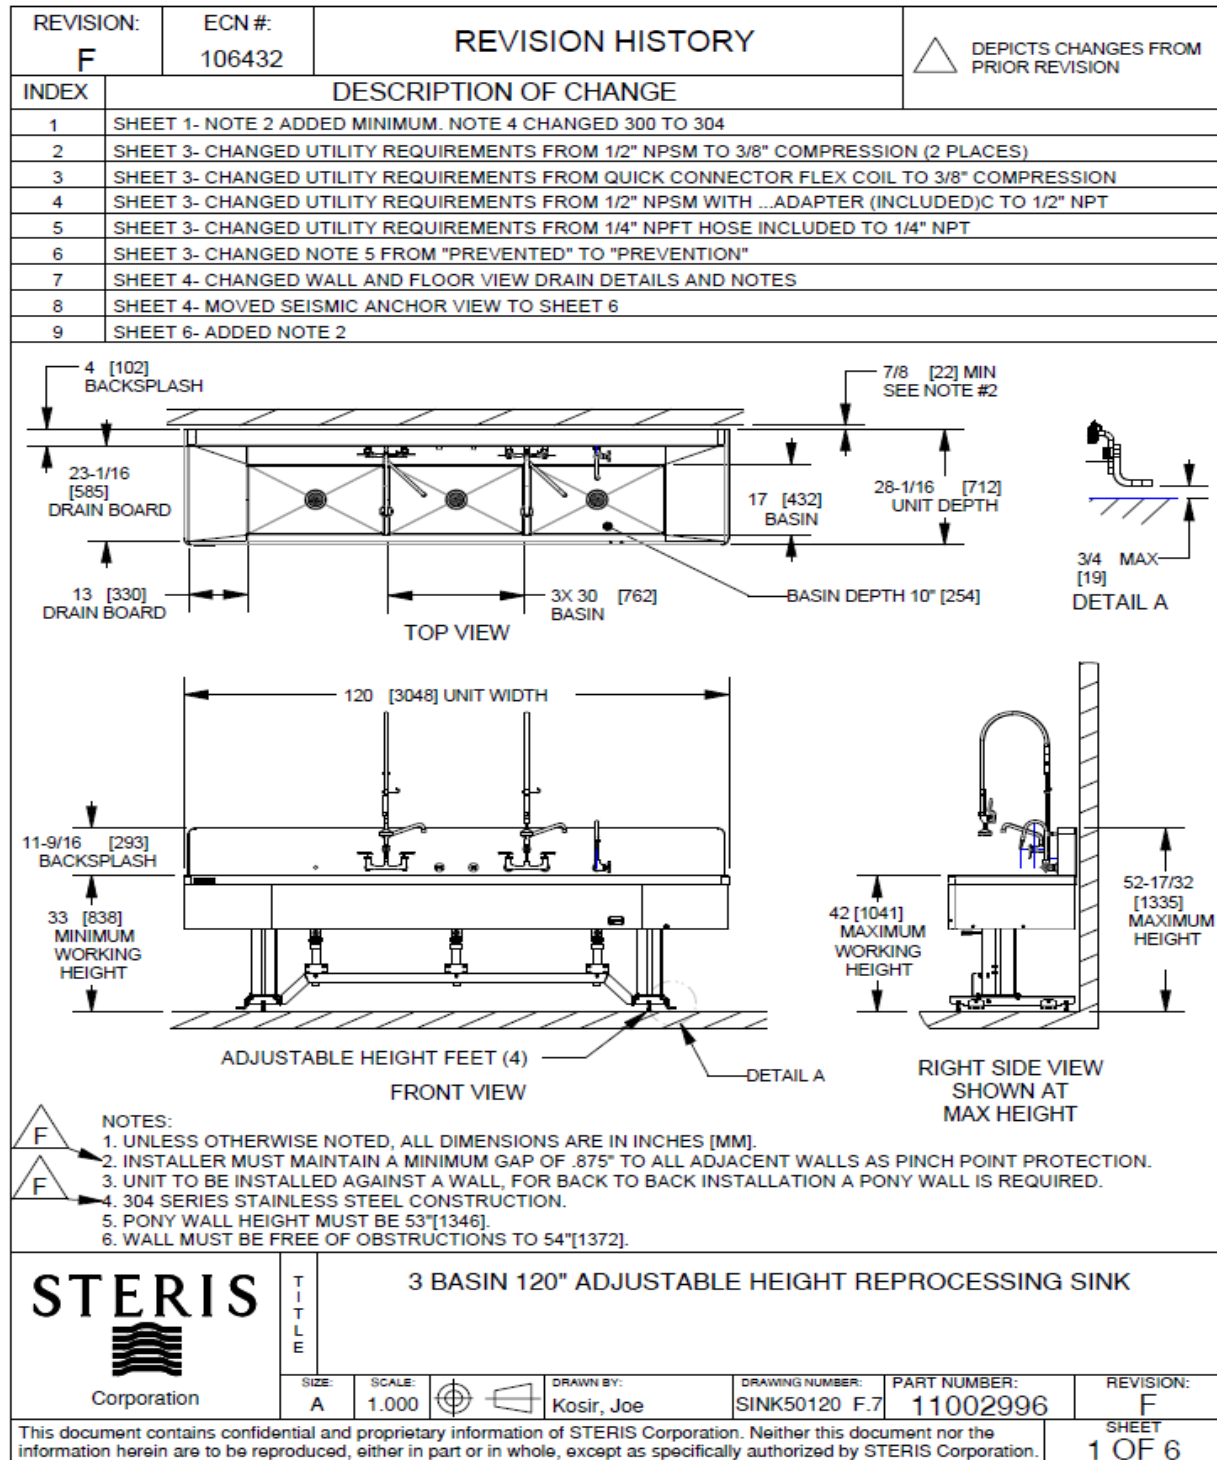


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HW	HOT WATER
CW	COLD WATER
PW	PURE WATER
WG	WATER GUN
A	COMPRESSED AIR
DB	DRAIN BASKET (BASIN)
D	DRAIN

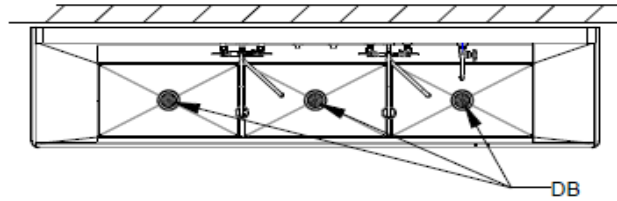

FRONT VIEW

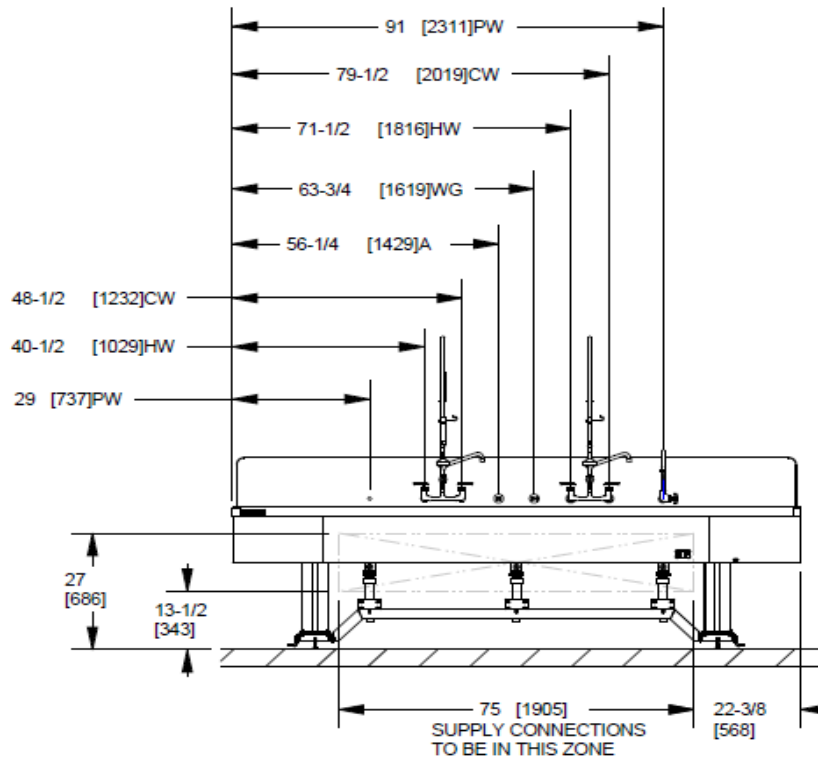

RIGHT SIDE VIEW  
SHOWN AT  
MAX HEIGHT

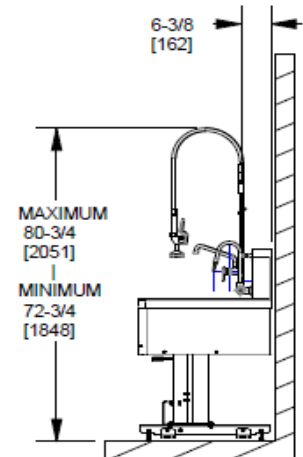NOTE: WORKFLOW CAN BE REVERSED BY MOVING PURE WATER FAUCET FROM RIGHT SIDE TO HOLE ON LEFT THAT IS CAPPED. ADDITIONALLY THE COMPRESSED AIR AND WATER GUN FIXTURES SHOULD BE SWAPPED.




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3 BASIN 120" ADJUSTABLE HEIGHT REPROCESSING SINK

SIZE:  
A

SCALE:  
1.000

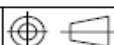

DRAWN BY:  
Kosir, Joe

DRAWING NUMBER:  
SINK50120 F.7

PART NUMBER:  
11002996

REVISION:  
F

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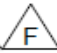
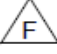
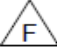
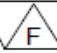
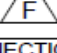
SHEET  
2 OF 6



# WinnMed

## ADJ. HEIGHT PROCESSING TRIPLE SINK 120" X 28" X 33"-41"

### UTILITY REQUIREMENTS CHART (PLUMBING)

UTILITY	PARAMETER	REQUIREMENT	NOTES
HOT WATER (HW)	CONNECTION TYPE/SIZE	3/8" COMPRESSION ←	
	PRESSURE RANGE	15 TO 125 PSI	
	OPERATING FLOW RATE	1.6 GPM @ MAX PSI	
	TEMPERATURE RANGE	40° F TO 180° F	
	WATER QUALITY	SEE NOTE #2	
COLD WATER (CW)	CONNECTION TYPE/SIZE	3/8" COMPRESSION ←	
	PRESSURE RANGE	15 TO 125 PSI	
	OPERATING FLOW RATE	1.6 GPM @ MAX PSI	
	TEMPERATURE RANGE	70° F MAX	
	WATER QUALITY	SEE NOTE #2	
PURE WATER (PW)	CONNECTION TYPE/SIZE	1/2" NPT ←	
	PRESSURE RANGE	20 TO 125 PSI	
	OPERATING FLOW RATE	.25 TO 2.00 GPM ±15%	
	TEMPERATURE RANGE	40° F TO 140° F	
	WATER QUALITY		
WATER GUN (WG)	CONNECTION TYPE/SIZE	3/8" COMPRESSION ←	 
	PRESSURE RANGE	0 TO 44 PSI	
	OPERATING FLOW RATE		
	TEMPERATURE RANGE	40° F TO 125° F	
	WATER QUALITY	SEE NOTE #2	
AIR GUN (A)	CONNECTION TYPE/SIZE	1/4" NPT ←	CONNECTION MUST BE MADE PER LOCAL CODE
	PRESSURE	30 PSI MAX	2 SCFM
	TIP 1	CONSUMPTION AT 30 PSI	
	TIP 2		
	TIP 3		
	TIP 4		
	TIP 5		
	TIPS 4 & 5 MUST BE OPERATED AT 30 PSI OR LESS TO COMPLY WITH OSHA DIRECTIVE		
BASIN DRAIN (BD)	CONNECTION TYPE	Ø 1-1/2" ABS P-TRAP (INCLUDED) Ø 2" COPPER P-TRAP (ACCESSORY)	DRAIN RATE AT 20 GPM EACH BASIN (ESTIMATED)

#### NOTES:

- SUPPLY LINES FOR EACH CONNECTION ARE SHIPPED WITH EACH SINK.
- STERIS RECOMMENDS THE FOLLOWING WATER QUALITY PARAMETERS:
  - 100-200 PPM (500PPM MAX) TOTAL DISSOLVED SOLIDS.
  - 70-120 PPM (180PPM MAX) TOTAL ALKALINITY.
  - 6.8-7.0PH (7.5 MAX).
  - 0.1-0.5PPM (1.0PPM MAX) TOTAL SILICA.
- STERIS DOES NOT SUPPLY A PRESSURE REGULATOR FOR USE WITH AIR GUN.
- STERIS DOES NOT SUPPLY A PRESSURE REDUCING VALVE FOR USE WITH WATER GUN.
- BACK FLOW PREVENTION BY CUSTOMER AGAINST BACK SIPHONAGE MAY BE REQUIRED (CHECK LOCAL PLUMBING CODE).
- FLOOR SINK OUTLET NEEDS TO BE ABLE TO ACCOMMODATE WASTE FROM ALL BAYS (CHECK LOCAL PLUMBING CODE).
- REFERENCES FOR PARAMETERS ARE TO MANUFACTURER'S RECOMMENDATION AND SHOULD BE FOLLOWED ACCORDINGLY.

# STERIS




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3 BASIN 120" ADJUSTABLE HEIGHT REPROCESSING SINK

SIZE:  
A

SCALE:  
1.000



DRAWN BY:  
Kosir, Joe

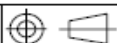DRAWING NUMBER:  
SINK50120 F.7



PART NUMBER:  
11002996

REVISION:  
F

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SHEET  
3 OF 6

# WinnMed

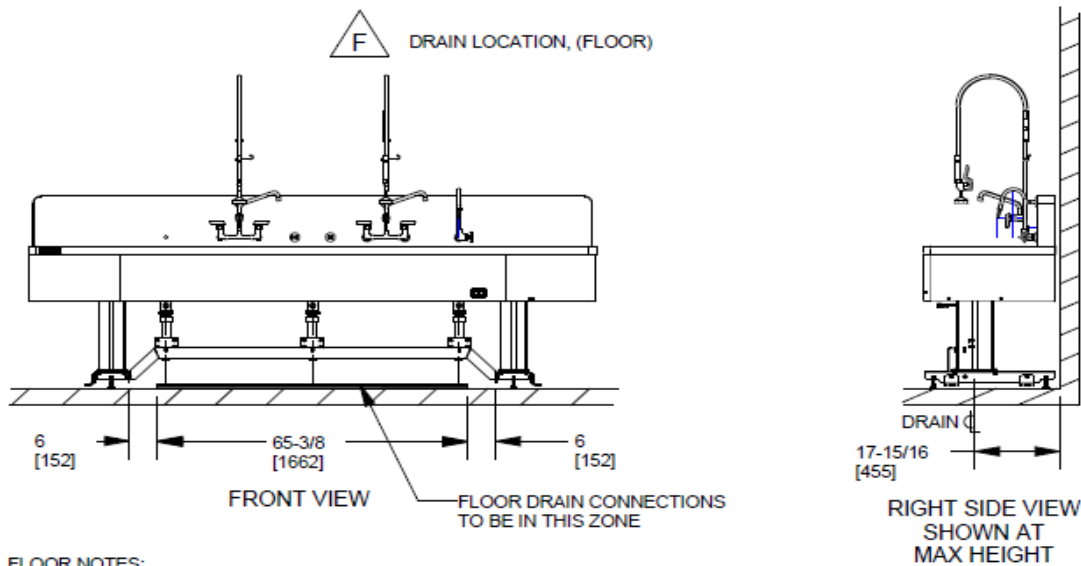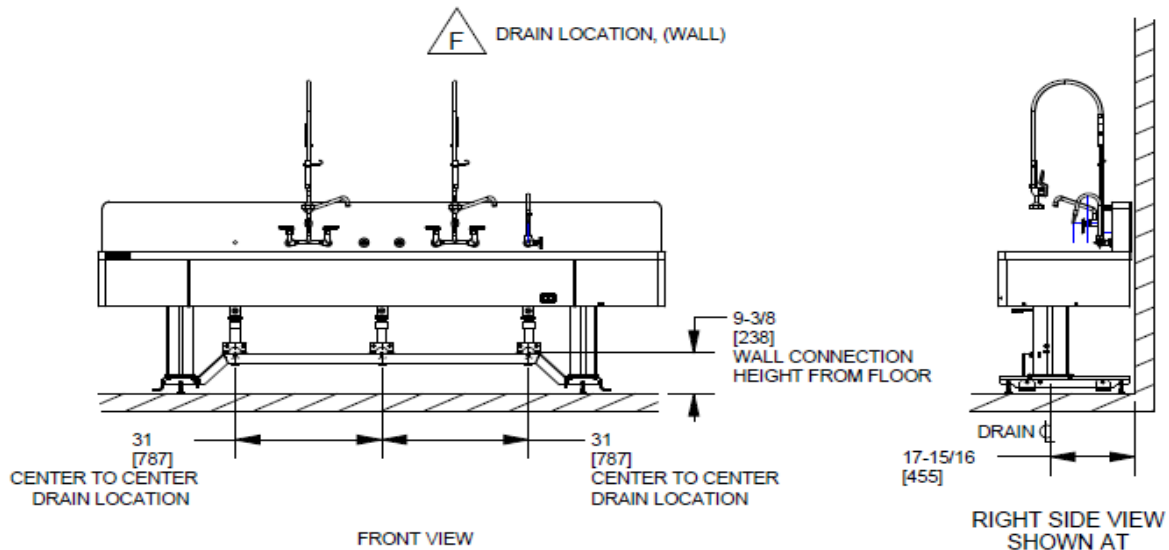


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3 BASIN 120" ADJUSTABLE HEIGHT REPROCESSING SINK

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DRAWN BY:  
Kosir, Joe

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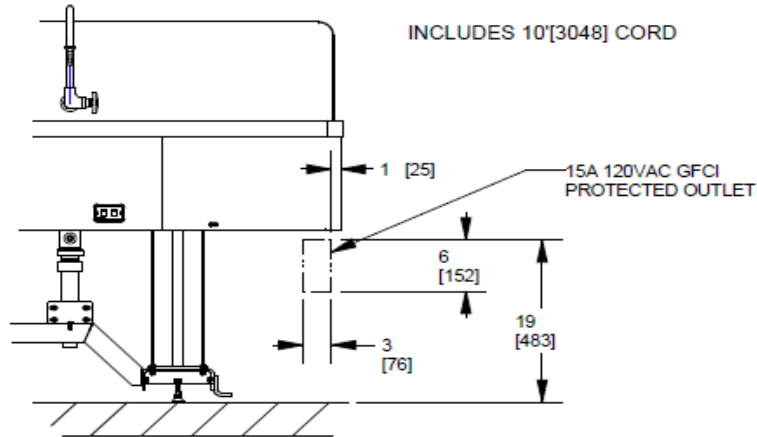
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SHEET  
4 OF 6



# WinnMed
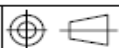
## UTILITY (ELECTRICITY) CONNECTION POSITION RECOMMENDED



PARTIAL FRONT VIEW

## ADJ. HEIGHT REPROCESSING TRIPLE SINK 120" X 28" X 33" TO 41"

### UTILITY SPECIFICATIONS CHART (ELECTRICAL)

#### ELECTRICITY

UTILITY	PARAMETER	REQUIREMENT	NOTES
ELECTRICITY	120V	15A GFCI PROTECTED OUTLET	
LINAK DL2 LIFT SYSTEM			
LINAK DL2 LIFT SYSTEM	WEIGHT CAPACITY	562LBS [2500 N] EACH	WITH OVERLOAD PROTECTION
	ADJUSTMENT RANGE	8.0" [203,2]	
	LIFT SPEED	UP TO 3/8"[10] PER SECOND	
	VOLTAGE	120VAC, 3A	




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3 BASIN 120" ADJUSTABLE HEIGHT REPROCESSING SINK

SIZE:  
A

SCALE:  
1.000

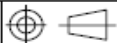

DRAWN BY:  
Kosir, Joe

DRAWING NUMBER:  
SINK50120 F.7

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11002996


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SHEET  
5 OF 6

# WinnMed

## SEISMIC ANCHOR HOLE POSITIONS



### NOTE:

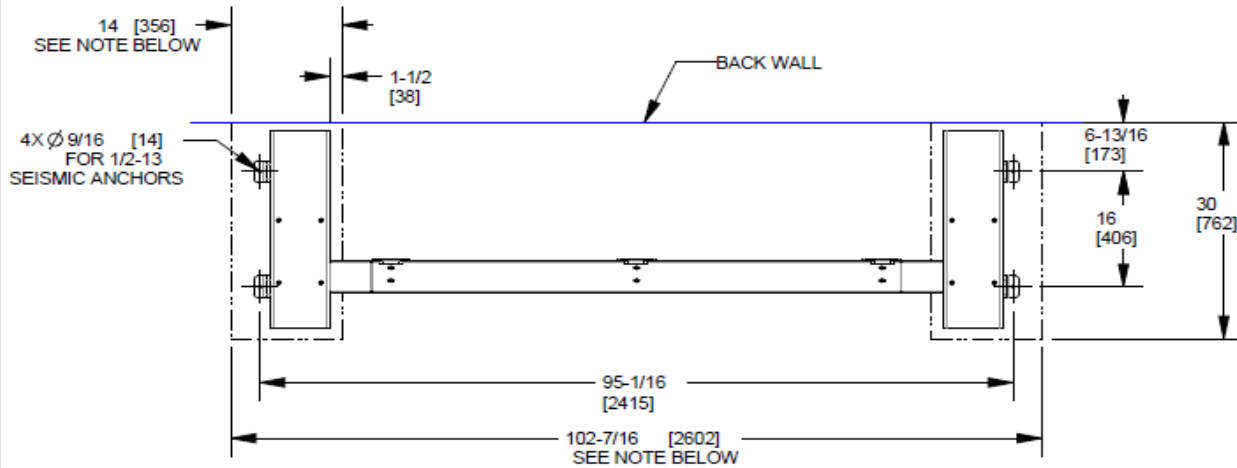

1. CONCRETE FLOOR MUST REMAIN FREE OF DEFECTS IN THESE AREAS FOR INSTALLATION OF SEISMIC ANCHORS (NOT PROVIDED BY STERIS).
2. REFER TO EQUIPMENT SPECIFIC SEISMIC DRAWING FOR MORE INFORMATION.

## PHYSICAL SPECIFICATIONS

SHIPPING DIMENSIONS L X W X H	132L X 36W X 48H
SHIPPING WEIGHT	690 LBS
OPERATING DIMENSIONS L X W X H	120" X 28" X 44-9/16" TO 52-9/16" [3048 X 711 X 1132 TO 1412]
OPERATING WEIGHT EMPTY	490 LBS
WORKING HEIGHT	33"[838] TO 41"[1041]




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3 BASIN 120" ADJUSTABLE HEIGHT REPROCESSING SINK

SIZE:  
A

SCALE:  
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DRAWN BY:  
Kosir, Joe

DRAWING NUMBER:  
SINK50120 F.7

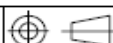PART NUMBER:  
11002996

REVISION:  
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SHEET  
6 OF 6

# WinnMed

WinnMed

Issue Date:

3/6/2024

Expansion and Renovation

Decorah, IA 52101

Furniture Specifications

CONTACT:

Ben Stevens - CFO

PHONE NUMBER:

563-387-3109

ITEM NUMBER:	20
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ITEM NAME:	Pass-Through Endoscope Reprocessor		
------------	------------------------------------	--	--

ROOM NUMBER:		QUANTITY:	
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## SPECIFICATION INFORMATION

MANUFACTURER: Steris

MODEL #: ADVPT3008


DIMENSIONS: 51.8" W x 31.2" D x 78.75" H

DESCRIPTION: Automated Endoscope Reprocessor; Pass-Through; 120V; 30C No Air; 34-39 min cycle; dual basin system; touchscreen monitor; barcode scanner; foot switch for hands-free door opening/closing

## FURNITURE & EQUIPMENT IMAGE




# WinnMed

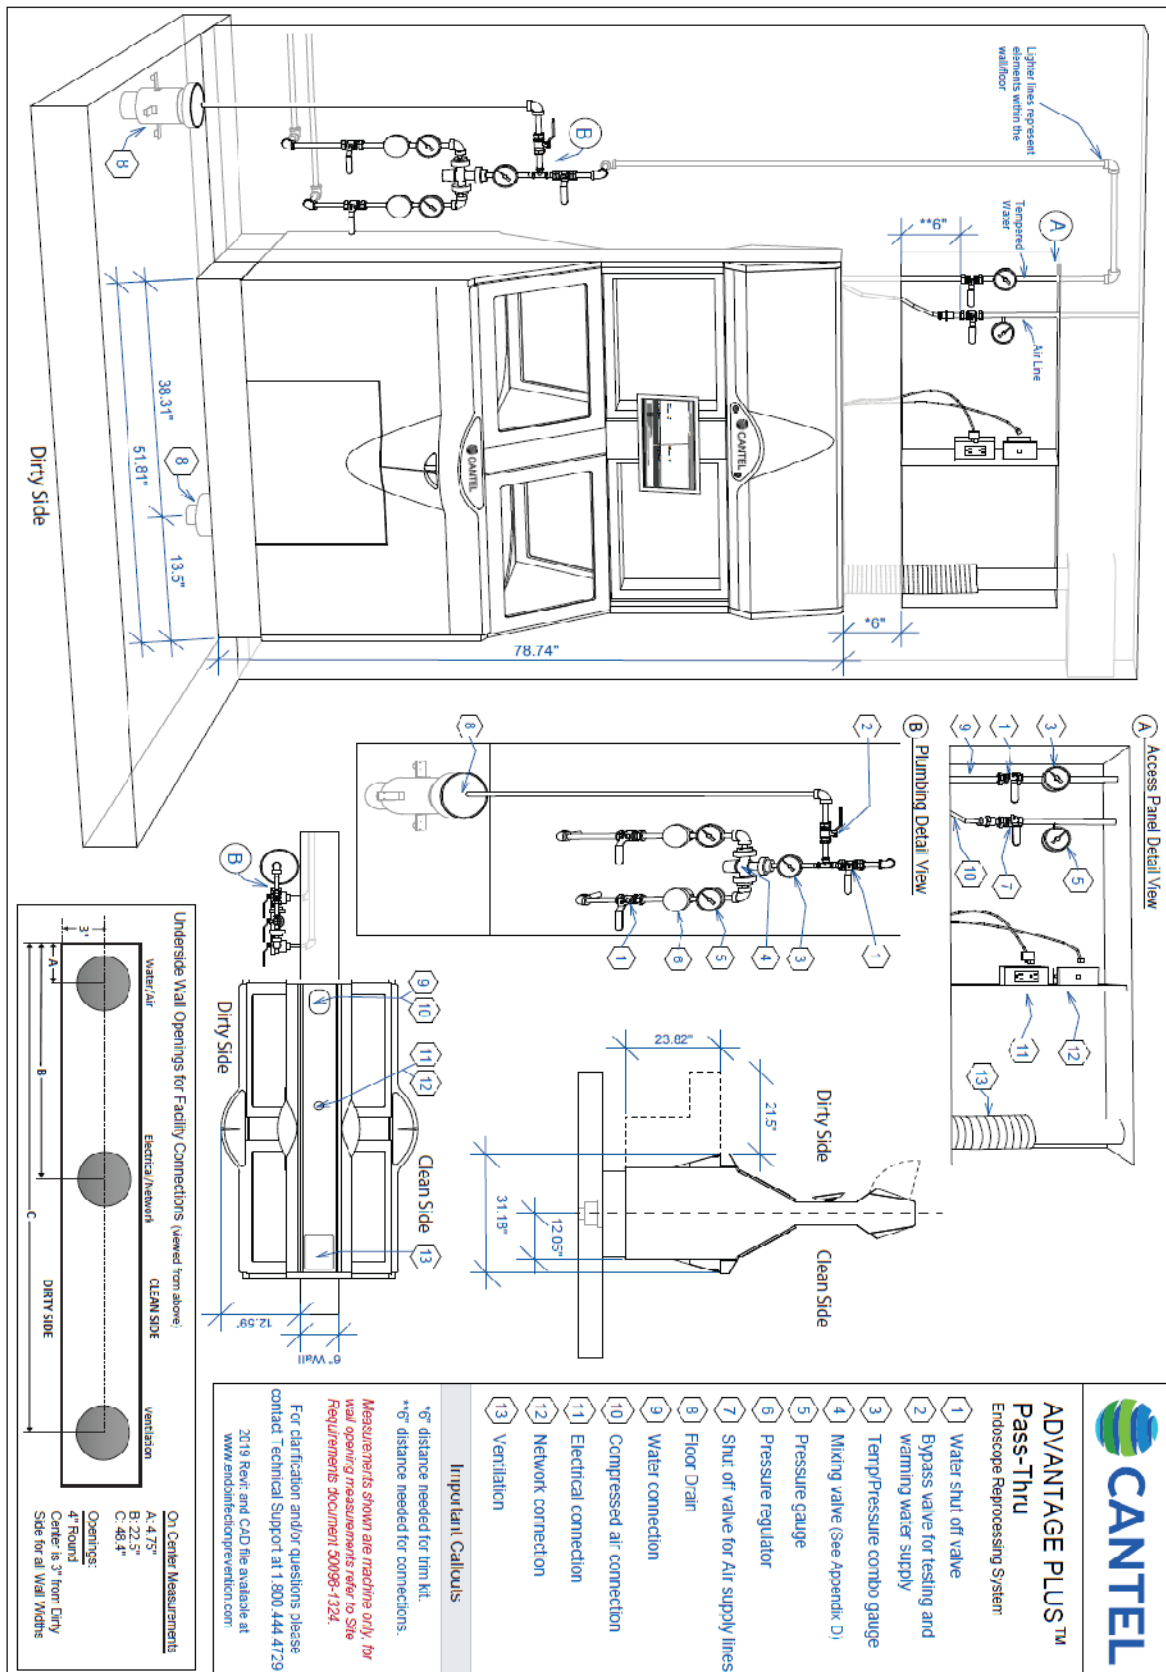

**ADVANTAGE PLUS™**  
Pass-Thru  
Endoscope Reprocessing System

# WinnMed

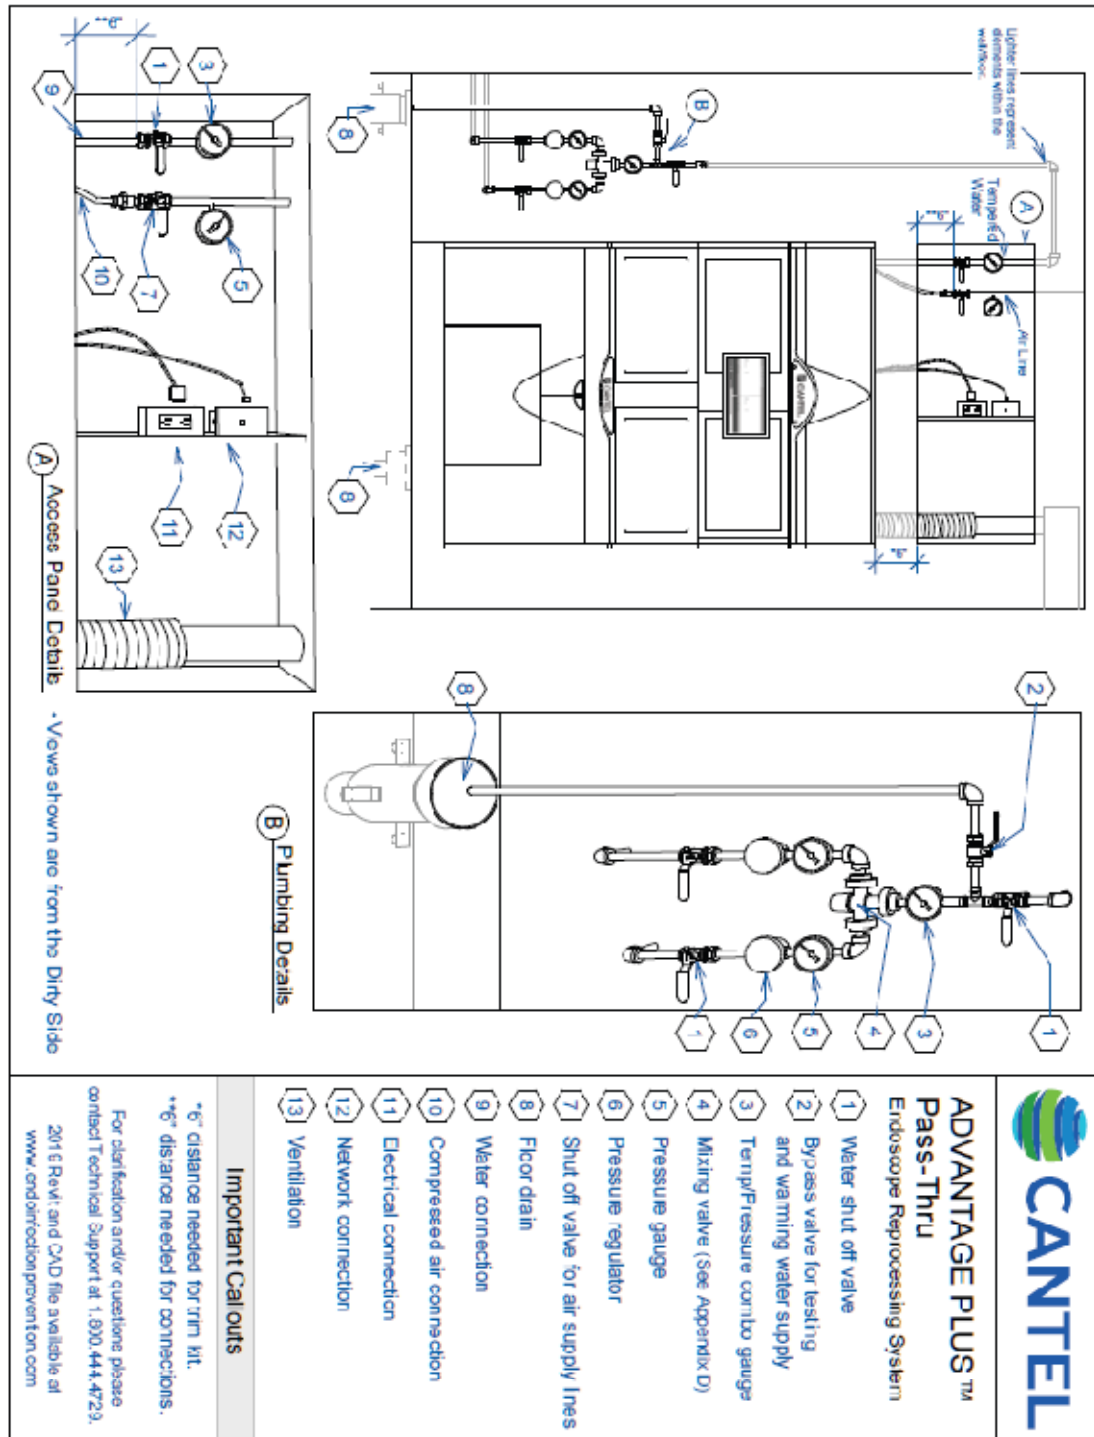


## WALL PREPARATION

- Refer to the included installation diagram (*Appendix E and Appendix F*).
- Wall rough opening:
  1. 1 reprocessor: 52-1/2" (1336 mm) wide x 79-3/4" (2025 mm) high
  2. 2 reprocessors: 104-1/4" (2646 mm) wide x 79-3/4" (2025 mm) high
  3. 3 reprocessors: 155-3/4" (3956 mm) wide x 79-3/4" (2025 mm) high
  4. 4 reprocessors: 207-1/2" (5266 mm) wide x 79-3/4" (2025 mm) high
- The wall opening must remain rough and consider the finished flooring. An optional trim kit is available to finish and seal the opening once the ADVANTAGE PLUS™ Pass-Thru Endoscope Reprocessor is installed. Medivators trim requires 4" (100 mm) of uninterrupted wall space on the sides and top of the reprocessor for trim attachment and is **the responsibility of the facility to install**.
- The interface between the wall opening and the floor must not have a cove or fillet, including wall space required for trim.
- Optimal **FINISHED** wall thickness is 4-1/2" (115 mm) to 7" (180 mm). Walls larger than 7" (180 mm) will require a custom trim kit be manufactured by the facility.
- The facility connections are made inside the wall. An access panel supplied by the facility will be required to provide access to these connections (*see Appendix F*).
- Access panels must be placed on the dirty side.
- All facility connections must be accessible in the opening.



**IMPORTANT:** A minimum of 6" (153 mm) of space is required below the facility connections in the wall opening to allow for machine connections to be made.

- The facility connections must not be more than 3 feet (1000 mm) above the top of the ADVANTAGE PLUS Pass-Thru Endoscope Reprocessing System.
- The facility connections are divided into three groups:
  1. Water/Air
  2. Electrical/Networking
  3. Ventilation

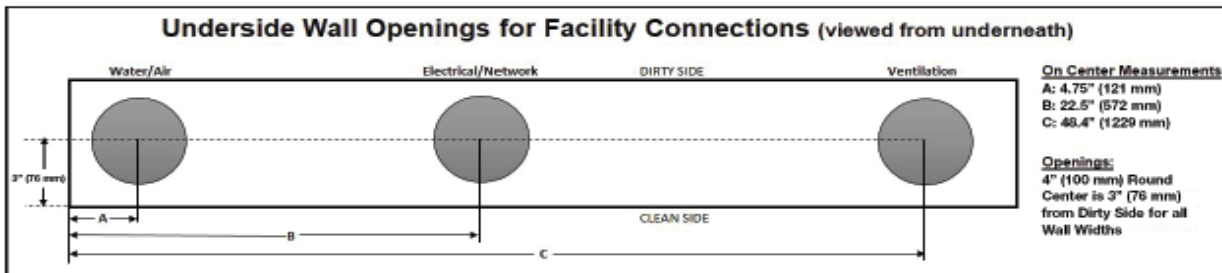

- Three access holes in the underside of the wall are required to make the connections between the facility and the ADVANTAGE PLUS Pass-Thru Endoscope Reprocessing System. Access holes need to be free of sharp edges. See above diagram for measurements.



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## FLOOR

---

- The floor must be level to allow for the proper leveling and sealing of the reprocessor.
- Do not slope the floor to the floor drains.



**IMPORTANT:** There can be no more than a ¼" (6 mm) in elevation variation across the floor underneath the Pass-Thru(s).

## WATER SUPPLY (REFER TO APPENDIX E)

---

The water supply must be able to provide an on-demand water temperature of 95°F ± 4°F (35°C ± 2°C).



**NOTE:** It is the responsibility of the facility to meet the water supply requirements. It is also the facility's responsibility to install, maintain and troubleshoot the water supply system. Please consult a local certified plumber for your specific installation.



**NOTE:** The use of an on-demand water heater could be used if the system can meet the temperature and flow specifications similar to the thermostatic mixing valves. Colder climate locations should take into consideration worse case scenarios of water supply temperatures and flow when reviewing an on-demand option.

- De-ionized water (DI water), due to its corrosive nature, cannot be used in the ADVANTAGE PLUS™ Pass-Thru Reprocessor.
- Potable water is the **minimum standard**; RO water is preferred, but not required.
- It is the responsibility of the facility to filter the incoming water to 1 micron.
- If a mixing valve is used, then it must be a thermostatic mixing valve. **One mixing valve per reprocessor is REQUIRED.**
- The thermostatic mixing valve must be accessible to aid in adjustment.
- Post thermostatic mixing valve the facility must include a thermometer followed by a bypass valve to a drain.
- *Appendix D* includes a suggested list of thermostatic mixing valves.
- Cantel Medical **REQUIRES** the addition of pressure regulators, temperature and pressure gauges on each of the hot and cold-water supply lines prior to entering the thermostatic mixing valve. It is the responsibility of the facility to purchase, install and maintain these devices. Temperature and pressure gauges on the incoming water lines provide a means of monitoring the water system of the facility should water temperature issues arise. Consult a qualified plumber to assist in determining the proper regulators, temperature and pressure gauges to use.
- The incoming waterline must be a minimum of 1/2" (13 mm) ID providing a minimum flow rate of 2.6 GPM (10 l/min) (per machine) and a **DYNAMIC** water pressure between 40 to 87 PSI (3 to 6 bar) at the gauge before the Bypass Valve.
- Water consumption is approximately 8 gallons (30 Liters) per cycle for a standard endoscope disinfection cycle and 11.5 gallons (43 Liters) per cycle for an endoscope disinfection cycle with a detergent wash per machine. Water consumption for the ADVANTAGE PLUS™ Pass-Thru Endoscope Reprocessing System will vary depending on the incoming water temperatures. The reprocessor will extend the initial flush up to 15 minutes to allow the water to come up to temperature to meet the minimum required temperature of the disinfectant.
- Ensure water hardness is less than 200 ppm CaCO<sub>3</sub> (200 mg/L CaCO<sub>3</sub>) for optimal performance.

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**NOTE:** An emergency eye wash valve **WILL NOT** meet the water temperature specifications for the ADVANTAGE PLUS™ Pass-Thru Endoscope Reprocessor and should not be used.



**NOTE:** After the mixing valve, a bypass valve with a path to a drain separate from the main machine drain with a shutoff valve **MUST** be installed so the operator can run water through the mixing valve if the water temperature falls too low and needs to be brought to temperature.



**NOTE:** Mixing Valve should be located within **4 FEET** (1220 mm) of the reprocessor and be easily accessible to operators for adjustments.



**NOTE:** The ADVANTAGE PLUS™ Pass-Thru Endoscope Reprocessor does not require backflow protection for the incoming water supply, nor is a backflow protection device installed in the reprocessor. Please consult your local codes, standards and/or guidelines, for applicable requirements. Some backflow protection devices may require their own additional drain. The customer is responsible for meeting local requirements.

## DRAIN (REFER TO APPENDIX F)

---

- The drain must be in the floor in the location indicated in the installation diagram.
- The drain system must accommodate draining of 10.5 gal/min (40 l/min).
- Facility must supply a flush floor drain with a minimum diameter of 4" (100 mm).



**WARNING:** An open trench drain **CANNOT** be used as the drain system for the ADVANTAGE PLUS™ Pass-Thru Endoscope Reprocessor.

## AIR SUPPLY

---

- Facility must supply a 1/4" (6 mm) NPT female connection with a shutoff valve and pressure gauge located in the wall behind an access panel.
- The facility supplied compressed air must meet these requirements:
  - o 58 to 145 psi (4 to 10 bar)
  - o The maximum demand of compressed air is 1.1 scfm (32 l/min ANR)
  - o Filtered to 5 microns
- The maximum dew point is 45°F (7°C).
- The maximum oil concentration is 5 mg/m<sup>3</sup>.



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## ELECTRICAL SUPPLY

---

- 120 VAC  $\pm$  10%, single phase, 60 Hz, 1200 watts per unit
- Facility must supply a GFI protected NEMA 5-15R outlet located in the wall behind an access panel per unit.
- Power consumption: 180 watts at idle, 480 watts during a cycle in one basin, 720 watts during a cycle in both basins, and a nominal peak of 1200 watts per unit.

## HEAT LOAD

---

- Idle: 600 BTU/hr.
- Cycle (1 basin): 1600 BTU/hr.
- Cycle (2 basins): 2400 BTU/hr.

## VENTILATION

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**NOTE:** It is the facility's responsibility to ensure ventilation requirements are met. Ventilation requirements are determined by OSHA based on the chemical being used for disinfection.

- It is a health and safety requirement to have a minimum of 10 air changes per hour in the room.
- Facility must supply a 4" (100 mm) round duct connection located in the wall behind an access panel.
  - o A minimum of 25 cfm (12 l/s) at 0.25 inches (6 mm)-water (62 PA) static pressure is required to properly vent the ADVANTAGE PLUS™ Pass-Thru Endoscope Reprocessing System.

## NETWORK

---

- Facility is required to supply an RJ45 network connection receptacle located in the wall behind an access panel.
- The ADVANTAGE PLUS Pass-Thru Endoscope Reprocessing System is equipped with a PC running Windows 7 which will allow full networking along with the capability of remote diagnostics.

## DIMENSIONS

---

- Shipping Dimensions
  - o Crate Dimensions: 85.5" (2172 mm) H x 69.5" (1766 mm) W x 44" (1118 mm) D
  - o Crate Weight: 1100 lbs (499 kgs)
- Reprocessor Dimensions
  - o The physical dimensions are 51-1/2" (1306 mm) Wide x 78-3/4" (2000 mm) High x 31-1/4" (792 mm) Deep.
  - o The installed weight is 882 lbs (400 kgs).

# WinnMed

WinnMed

Issue Date:

3/6/2024

Expansion and Renovation

Decorah, IA 52101

Furniture Specifications

CONTACT:

Ben Stevens - CFO

PHONE NUMBER:

563-387-3109

ITEM NUMBER:	21
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ITEM NAME:	Endoscope Drying and Storage System		
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ROOM NUMBER:		QUANTITY:	
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SPECIFICATION INFORMATION	
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MANUFACTURER: Steris

MODEL #: DRY1001

DIMENSIONS: 23.6" W x 21.3" D x 74.8" H

DESCRIPTION: Endoscopy Drying and Storage System; 1 hour internal dry time; 3 hour external dry time; single-sided w/ glass door;

FURNITURE & EQUIPMENT IMAGE
-----------------------------



# WinnMed

## AIR SUPPLY

1. Quality: ISO 8573-1:2010 class 1.2.1
  - Particle Size: Incoming air filtered down to <1 micron in size.
  - Moisture Content: Pressure dew point (PDP) of -40°C or better required and no liquid water.
  - Oil Content: < 0.01mg of oil per cubic meter of compressed air (liquid, aerosol or vapor oil).
2. Pressure: The below pressures are required at the point of cabinet connection. Facility should consult with their Maintenance Department or their qualified air vendor to identify potential issues with the air supply.
  - ENDODRY™ Cabinet for ADVANTAGE PLUS™ Endoscope Reprocessor: 58-145 psi (4-10 bar).
  - ENDODRY Cabinet for DSD EDGE™ Automated Endoscope Reprocessor: 72-145 psi (5-10 bar).
3. Volume: The below volumes are required at the point of cabinet connection.
  - ADVANTAGE PLUS Endoscope Reprocessor/ENDODRY Cabinet: Minimum requirement of 4.2 scfm (120 l/min ANR) per cabinet.
  - DSD EDGE Automated Endoscope Reprocessor/ENDODRY Cabinet: Minimum requirement of 7 scfm (200 l/min ANR) per cabinet.
4. Flexible Air Hose: A 5 foot (1.5 Meter) line is included with each cabinet.
  - One end will be pre-configured to connect to ENDODRY™ Drying Cabinet.
  - Open end will be ¼" or 6mm inner diameter and it is the responsibility of the facility to make that connection to their air supply line.

The compressors listed below are suggestions that the facility can purchase directly from either the compressor manufacturer or authorized dealer. WinnMed is not responsible for air compressor warranty, service and maintenance.

ADVANTAGE HOOKUPS			DSD HOOKUPS		
# of Cabinets	BeaconMedaes (Requires Additional Dryer)	Powerex (w/ Dryer)	# of Cabinets	BeaconMedaes (Requires Additional Dryer)	Powerex (w/ Dryer)
1	LES03-145T-RD-xxx	SES0308TM**	1	LES05-145T-RD-xxx	SES0508TM**
2	LES05-145T-RD-xxx	SES05058TM**	2	LES10-145RD	LSE1504
3	LES07-145T-RD-xxx	LSE1504	3	LES15-145RD	LSE1504
4	LES07-145T-RD-xxx	LSE1504	4	LES20-145RD	LSE2005
5	LES15-145RD	LSE1504	5	LES20-145RD	LSE2005

# WinnMed

## ELECTRICAL SUPPLY

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- 100-240 VAC  $\pm$  10%, single phase, 50/60 Hz, 15 amp circuit (120v), 10 amp circuit (230v).
- Power input: 75W
- A NEMA 5-15 power cord for the North America market and a CEE 7 power cord for the European market is included with the ENDODRY™ Storage and Drying System. The cord is approximately 6 feet (1.8 meters) in length.
- A GFI/RCD protected outlet located on the wall above the ENDODRY Storage and Drying System, see Floor & Wall Section.
- Medivators equipment must be on dedicated circuits.

## NETWORKING

---

- The ENDODRY Storage and Drying System is a networkable piece of equipment and has the capabilities to communicate to other Medivators technologies via a LAN interface (RJ45, 10/100 Mbit).
- A 6.5 foot (2 meter) cable is included with the cabinet.
- A RJ45 wall mounted network jack located on the wall above the ENDODRY Storage and Drying System, see Floor & Wall section.

## DIMENSIONS

---

### Shipping Dimensions

- Crate Dimensions: H84"x W47"x D31"
- Crate Weight: 583 lbs.

### Reprocessor Dimensions

- Dimensions: H74.8" X W23.6" X D21.3"
- Weight: 375 lbs (170 kg)


## FLOOR & WALL

---

- The floor must be level.
- For optimal user-safety and operation, it is recommended that the ENDODRY Storage and Drying System always be placed directly on the floor, and not on an elevated platform.
- The back of the one-sided ENDODRY Storage and Drying System will be placed flush against the wall. All electrical, network and air connections must be placed a minimum of 78.7 inches (200 cm) off of the floor above the cabinet.
- The two-sided ENDODRY Storage and Drying System is designed to fit into an opening in the wall. The rough opening for a single unit is H75.2" X W24" (191cm x 61cm). All electrical, network and air connections must be placed a minimum of 78.7 inches (200 cm) off of the floor above the cabinet. The electrical, network and air connections must be located on the loading side of the ENDODRY Storage and Drying System.

# WinnMed

## One-Sided Version

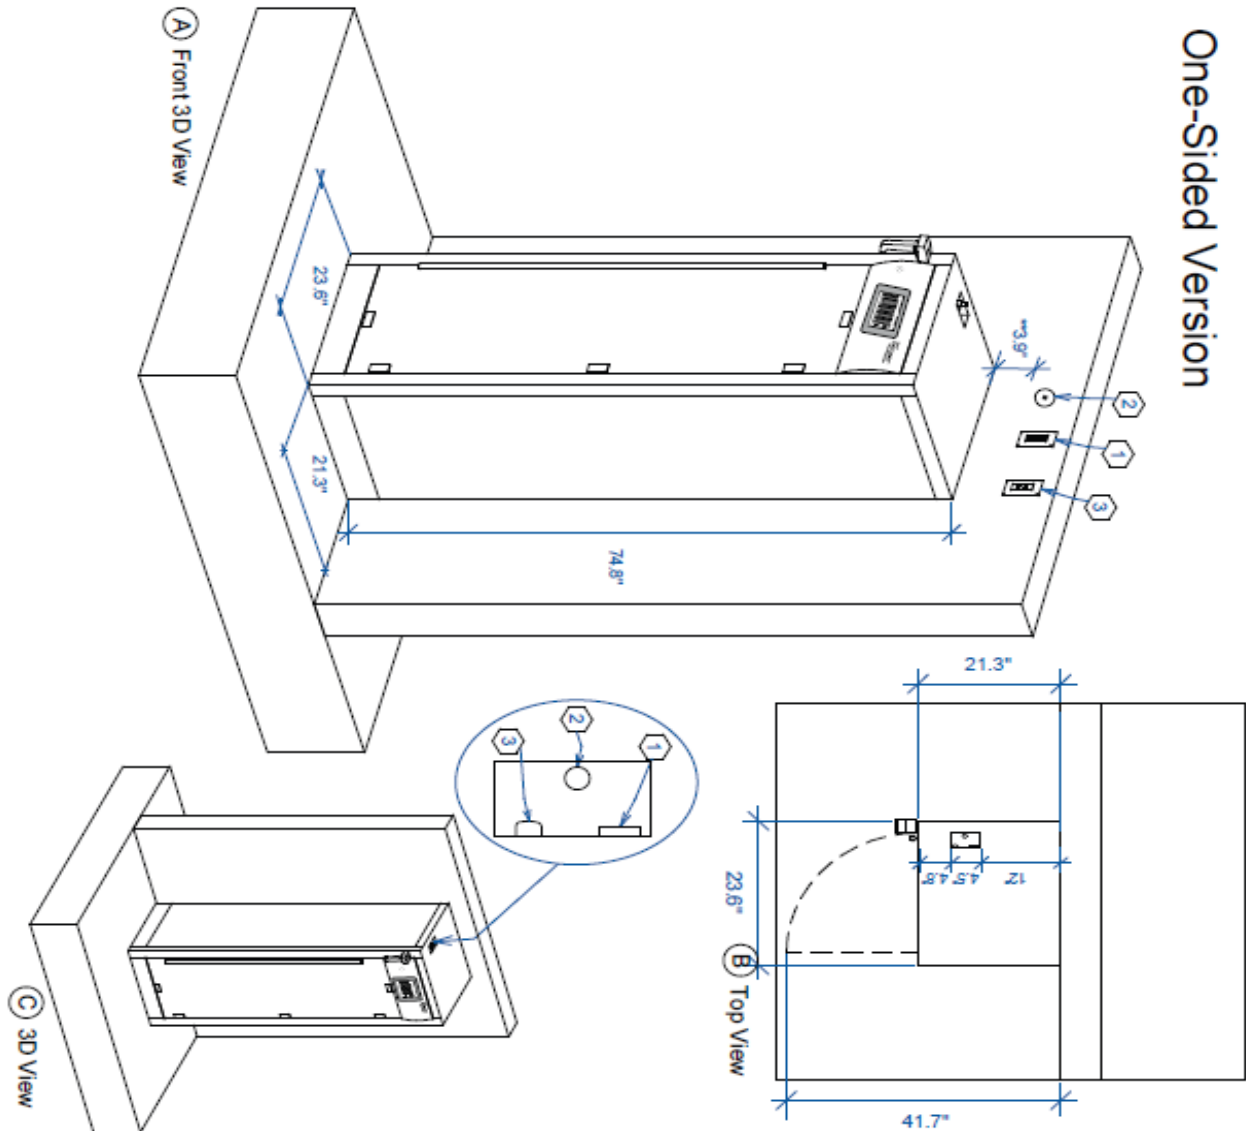

**ENDODRY™**  
Storage and Drying System

- 1 Electrical Connection
- 2 Air Connection
- 3 Network Connection

\*\*Minimum facility wall connections height is 78.7" from floor.

Options for Doors

Open Left - OL  
Open Right- OR

For clarification and/or questions  
please contact Technical Support  
at 1.800.444.4729.

[www.endodryonprevention.com](http://www.endodryonprevention.com)  
to download the Revit file.

# WinnMed

WinnMed

Issue Date:

3/6/2024

Expansion and Renovation

Decorah, IA 52101

Furniture Specifications

CONTACT:

Ben Stevens - CFO

PHONE NUMBER:

563-387-3109

ITEM NUMBER:	22
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ITEM NAME:	BLANK		
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ROOM NUMBER:		QUANTITY:	
--------------	--	-----------	--

SPECIFICATION INFORMATION	
---------------------------	--

MANUFACTURER:

MODEL #:

DIMENSIONS:

DESCRIPTION:

FURNITURE & EQUIPMENT IMAGE
-----------------------------

# WinnMed

WinnMed

Issue Date:

3/6/2024

Expansion and Renovation

Decorah, IA 52101

Furniture Specifications

CONTACT:

Ben Stevens - CFO

PHONE NUMBER:

563-387-3109

ITEM NUMBER:	23
--------------	----

ITEM NAME:	BLANK		
------------	-------	--	--

ROOM NUMBER:		QUANTITY:	
--------------	--	-----------	--

SPECIFICATION INFORMATION	
---------------------------	--

MANUFACTURER:

MODEL #:

DIMENSIONS:

DESCRIPTION:

FURNITURE & EQUIPMENT IMAGE
-----------------------------

# WinnMed

WinnMed

Issue Date:

3/6/2024

Expansion and Renovation

Decorah, IA 52101

Furniture Specifications

CONTACT:

Ben Stevens - CFO

PHONE NUMBER:

563-387-3109

ITEM NUMBER:	24
--------------	----

ITEM NAME:	Ceiling Mounted Surgical Light		
ROOM NUMBER:		QUANTITY:	

## SPECIFICATION INFORMATION


MANUFACTURER: Stryker  
MODEL #: RD 2207  
DIMENSIONS: Endo Room 1 & 2  
DESCRIPTION: Ceiling Mounted Surgical Light; Wall Control Display; Sterile Control & Light Handle; Sterile Control Prep; 2 Arm; Qty 1 Monitor Mount

## FURNITURE & EQUIPMENT IMAGE






# WinnMed


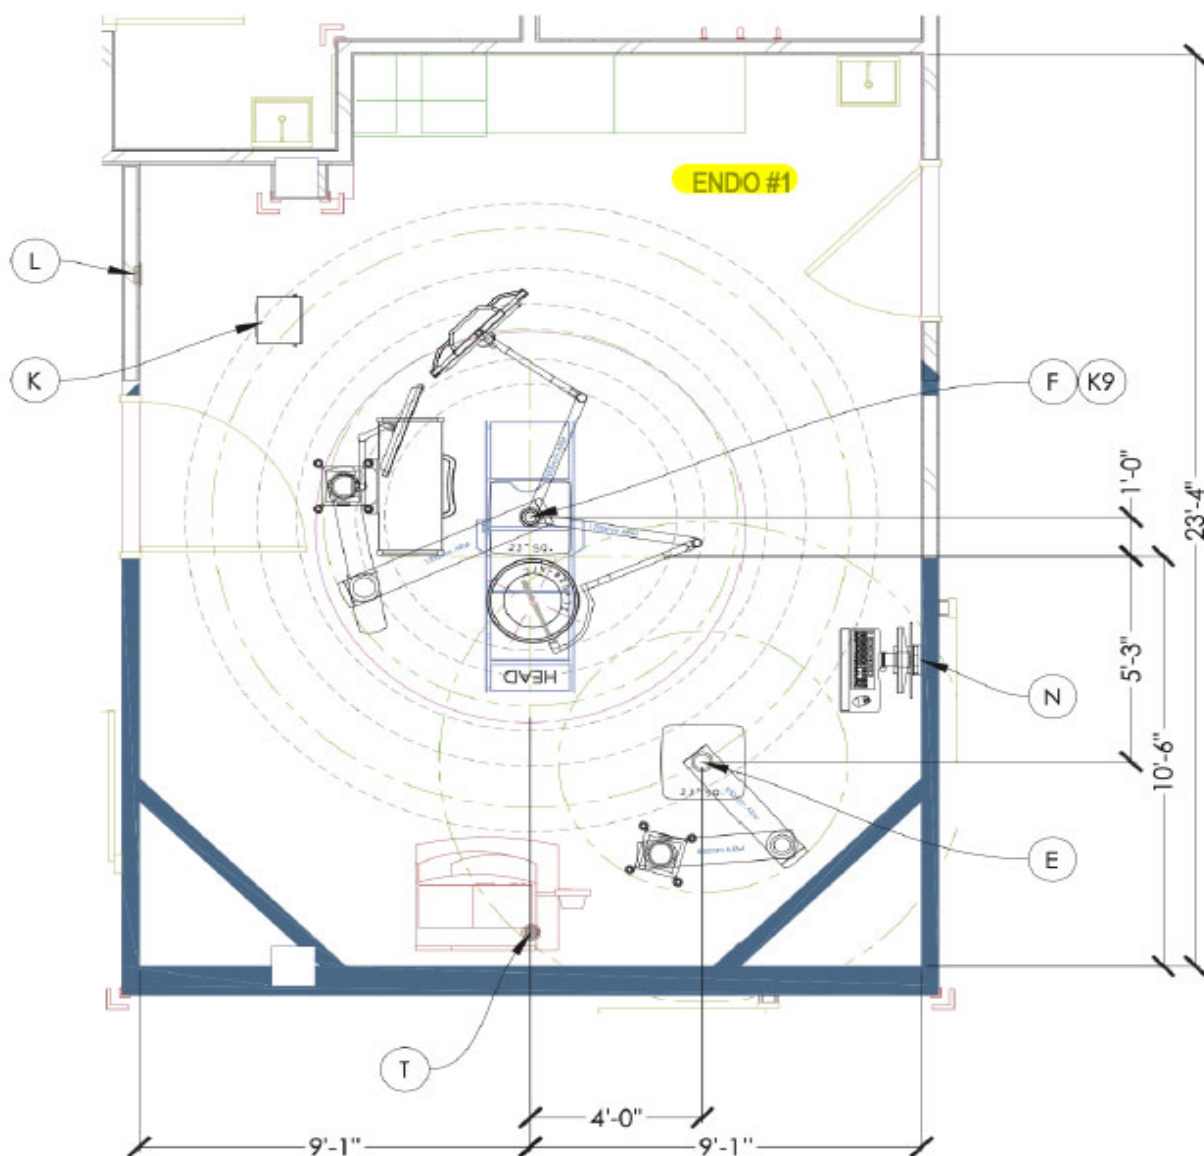


# WinnMed

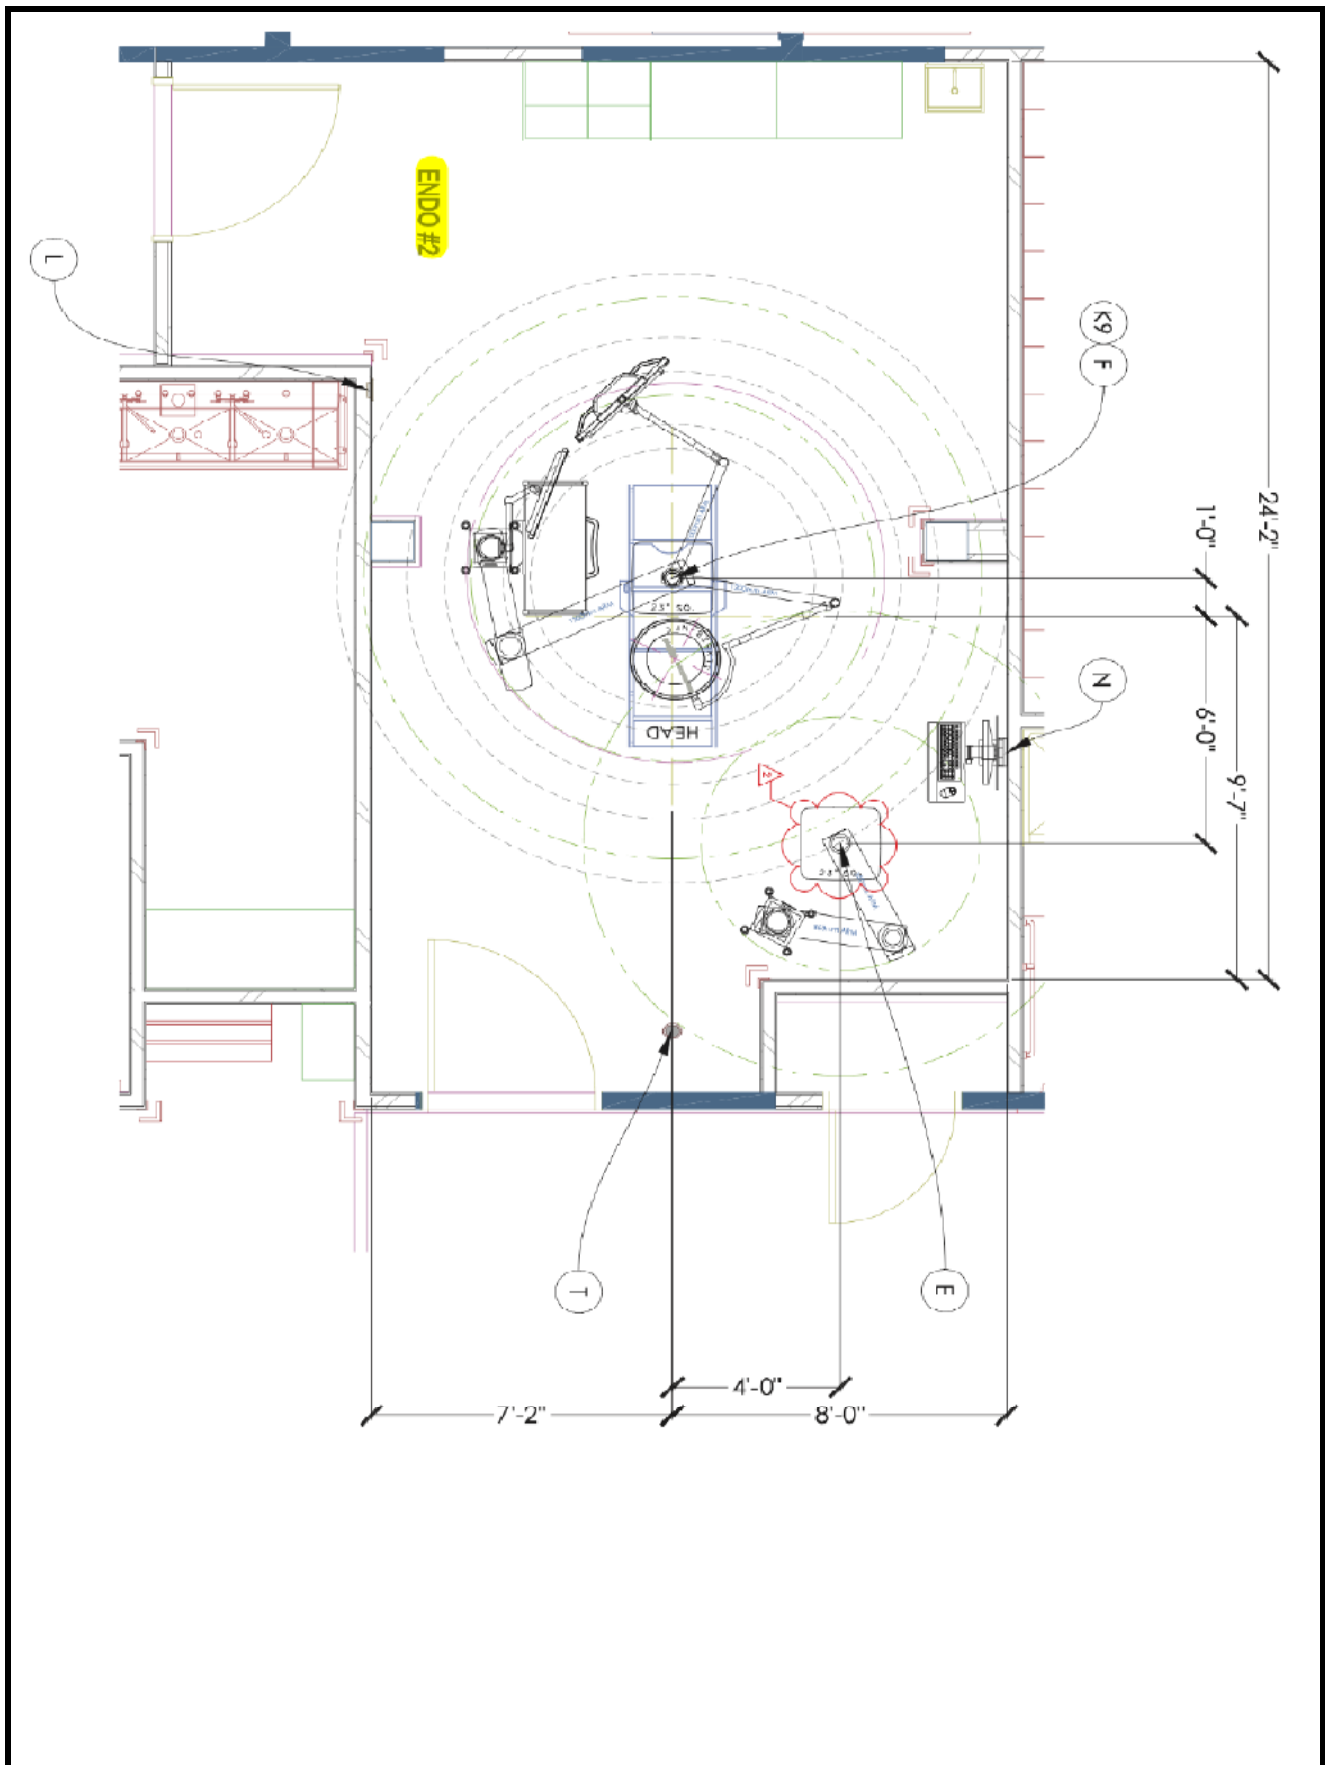

Endo Rooms 1 and 2 - TC Equipment Boom / TC F528 Light with UDM  
Quote: 10179348 Rev 4 Block# 5 / 10

stryker

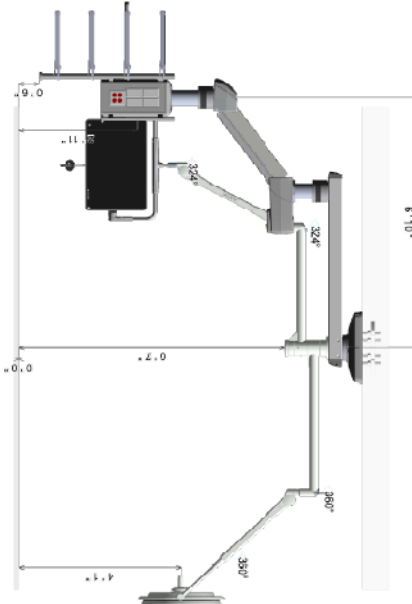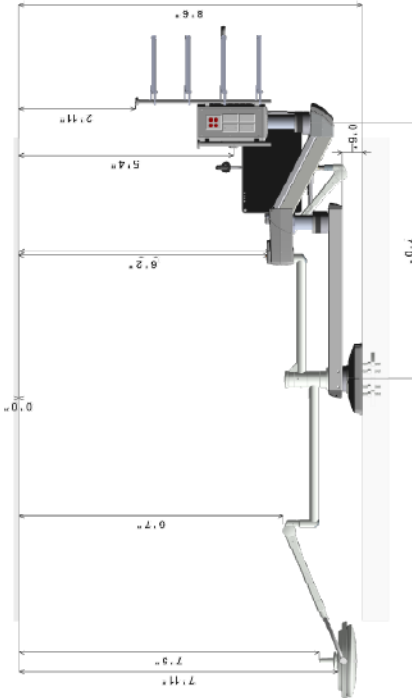

Top S-Series Equipment Boom	
Boat System	Electric
Medical Rail Type	Painted
Top Arm Length	1300mm
Bottom Arm Length	900mm
MC Tube Length	180mm
Column Tube Length	260mm
Weight Capacity (see note 4)	277 lbs.
Gas Hose Length (ft)	14.77
Gas Hose Used (%)	63
Manufacturing Type	Stand Up
Do Not Assemble From MFR	

Top S-Series Equipment Boom Shelves	
Shelf Type	Painted
Shelf 1	1800mm
Shelf 2	750mm w/Controls
Shelf 3	750mm
Shelf 4	750mm

TC Configuration - SLX Lights	
Arm No. 1 (MP1)	Arm No. 2 (MP2)
Equipment	SLX528
Horizontal Arm	1200
HCT Length	None
Tube Length	0
Carton	NFC
Dual Control	No
Video Bundle	StrykerUDM
Main Voltage	120VAC

I confirm the ceiling height and agree with the dimensions as shown. I confirm the equipment configuration as shown including arm lengths, positions, gas key styles, brand, and locations, electronic, and low voltage selections and locations. I understand that any changes made after an order is in production will result in a change order fee and a delay in shipment.	
CUSTOMER APPROVALS	DATE
CLINICAL REPRESENTATIVE	DATE
FACILITY ENGINEERS	DATE
NOTES:	
1. For weight, moment, and installation details, please refer to the Stryker Pre-Installation Manual.	
2. It is the owner's responsibility to provide the support structure to meet requirements listed in the Pre-Installation Manual.	
3. Customer is responsible for reviewing and approving Gas Key Style and Manufacture.	
4. Total weight capacity available for all Stryker and customer supplied accessories, based on weight moments listed in S-SERIES Pre-Installation Manual.	
5. Stryker mounting plate must be installed at 3.0' above finished ceiling plane. All vertical boom dimensions shown in drawing are dependent on this requirement.	
Stryker Communications 501 Seward Drive Decorah, IA 52101 Phone: (877) 799-8106 Fax: (563) 794-2669 www.stryker.com	
Sales Representative : Brian Kipfel brian.kipfel@stryker.com	
Project: Customer: WINNEMED MED CTR City: DEORAH Equip ID: SPS-3-OF 528SFP Quote No.: 10179348 Quote Date: 15-Aug-2023 DWG Rev No.: 4 DWG Line #: / DWG Rev No.: 3 DWG No.: 10179348SXX3	
State: IOWA Quote Rev No.: 4 QTY: 2 Block # 5 / 10	

# Endo Rooms 1 and 2 - TC Equipment Boom

stryker

8'6"

Quote: 10179648 Rev/4 Block#5

FRONT

RIGHT

BACK




LEFT

F1	204/125V Duplex (8 Outlets)
F2	Data Pass Thru
F3	Distribution Bd

R1	Blank
R2	Blank
R3	Blank
R4	Blank
R5	204/125V Duplex (4 Outlets)

B1	204/125V Duplex (4 Outlets)
B2	Blank
B3	Blank
B4	VAC
B5	VAC

L1	Blank
L2	Blank
L3	Blank
L4	CO2
L5	204/125V Duplex (4 Outlets)

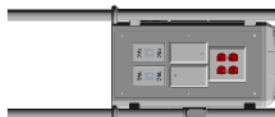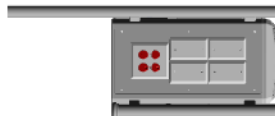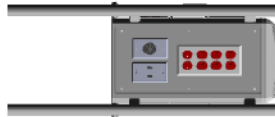

Qty	Description
1	Data Pass Thru
9	10 Blank Plate
1	Distribution Board

Qty	Gas Type	Key Style	Manufacturer
1	Carbon Dioxide (CO2)	D.I.S.S.	Baccon Medias
2	Vacuum	Chemon	Baccon Medias

Main Power Type		Isolated		High Voltage	
Main Power Source		Emergency			
Manufacturer		Leviton			
Loc	Circuit Ref #	# of Circuits	Color	Cabinet Box	Description
F1	1,2	2	Red	A	204/125V Duplex (8 Outlets)
R5	3	1	Red	A	204/125V Duplex (4 Outlets)
B1	4	1	Red	A	204/125V Duplex (4 Outlets)
L5	5	1	Red	A	204/125V Duplex (4 Outlets)

Qty	Description
5	Total 15A/20A Circuits
1	Circuit for Water and Brake

Front	1000mm
Back	531mm
Control	Real Only

I confirm the ceiling height and space with the dimensions as shown. I confirm the equipment configuration as shown including arm lengths, platform, gas key, styles, brand, and location, electronic, and low voltage selection, and location. I understand that any changes made after an order is in production will result in a change order fee and a delay in shipment.

## NOTES:

- For weights, moments, and installation details, please refer to the Stryker Pre-installation manual.
- It is the customer's responsibility to provide the support structure to meet requirements listed in the Pre-install Manual.
- Customer is responsible for reviewing and approving Gas Key Style and Manufacturer.
- Total weight capacity available for all Stryker and customer supplied accessories, based on weights moments listed in S-SERIES Pre-install Manual.
- Bottom of Stryker mounting plate must be installed at 3' or above finished ceiling. Platform mechanical boom dimensions shown in drawing are dependent on this requirement.

CUSTOMER APPROVALS	SIGNATURE	PRINT NAME & TITLE	DATE
CLINICAL REPRESENTATIVE			
FACILITY ENGINEERING			

Stryker Communications  
571 Shaven Ln.  
Decorah, IA 52001  
P: (562) 754-2900  
E: FAX: (562) 754-2909  
www.stryker.com

Sales Representative : Brian Kilgus  
brian.kilgus@stryker.com

Project: WINNESHIEK MED CTR  
Customer: WINNESHIEK MED CTR  
Equip D: SPS-3-C  
Equip Name: Endo Rooms 1 and 2  
Quote No.: 10179648  
Quote Date: 15-Aug-2023  
Quote Rev No.: 4  
Quote Line #: QTY 2  
DWG Rev No.: 3  
DWG No.: 10179648S103  
Block #: 5

Proposal #: 10179648 v.4 | Proposal Year: 2023 | Effective Through: 03-Apr-2023

WINNESHIEK MED CTR Proposal | Page 2 of 20

WinnMed

# WinnMed

Room: Endo Rooms 1 and 2

TC F528 Light with UDM



## SLX Surgical Light

The Stryker Surgical Light combines innovative features, inspired by the best technology, to provide superior light quality for your surgical team. And with so many options to customize, configure, and control your light, you can now enhance the OR experience like never before.

PART #	DESCRIPTION	QTY	LIST PRICE	EXT LIST PRICE
FD 2207	LIGHT / SFP1	2		

### Mounting Details

Multiple Suspension Mounting TC Only

### Controls

Wall Control Wall mounted (recessed)

Cardanic Control No

Control Unit Type Touch

Light Handle Type Sterile Control+ (Devon slip on)

### Power Supply

SK Box Above Ceiling or Surface Mount

### Configuration Details

Arm 1 Lighthood

Arm Length 1200

Cardanic Style NFC

Camera Prep No

Arm 2 Monitor bracket

Arm Length 1000

PART #	DESCRIPTION	QTY	LIST PRICE	EXT LIST PRICE
CY 9000150	LIGHT OR FLAT PANEL HANDLE	2		
CY 9000103	UDM INTERSTITIAL AND SUSPENSION CABLES	2		
CY 1008104	MULTI COLOR TOUCH WALL CONTROL DISPLAY FOR SINGLE, DUAL OR TRIPLE F-GENERATION LIGHT CONFIGURATION	2		
CY 9000122	STERILE CONTROL PREP	2		
CY 9000123	STERILE CONTROL+ LIGHT HANDLE	2		

# WinnMed

WinnMed

Issue Date:

3/6/2024

Expansion and Renovation

Decorah, IA 52101

Furniture Specifications

CONTACT:

Ben Stevens - CFO

PHONE NUMBER:

563-387-3109

ITEM NUMBER:	25
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ITEM NAME:	Ceiling Mounted Equipment Boom		
ROOM NUMBER:		QUANTITY:	


## SPECIFICATION INFORMATION

MANUFACTURER: Stryker  
MODEL #: SPS-3-C  
DIMENSIONS: Endo Room 1 & 2  
DESCRIPTION: Ceiling Mounted Equipment Boom; 3 Row; 4 Shelves; Foot Pedal Storage Drawer


## FURNITURE & EQUIPMENT IMAGE



# WinnMed

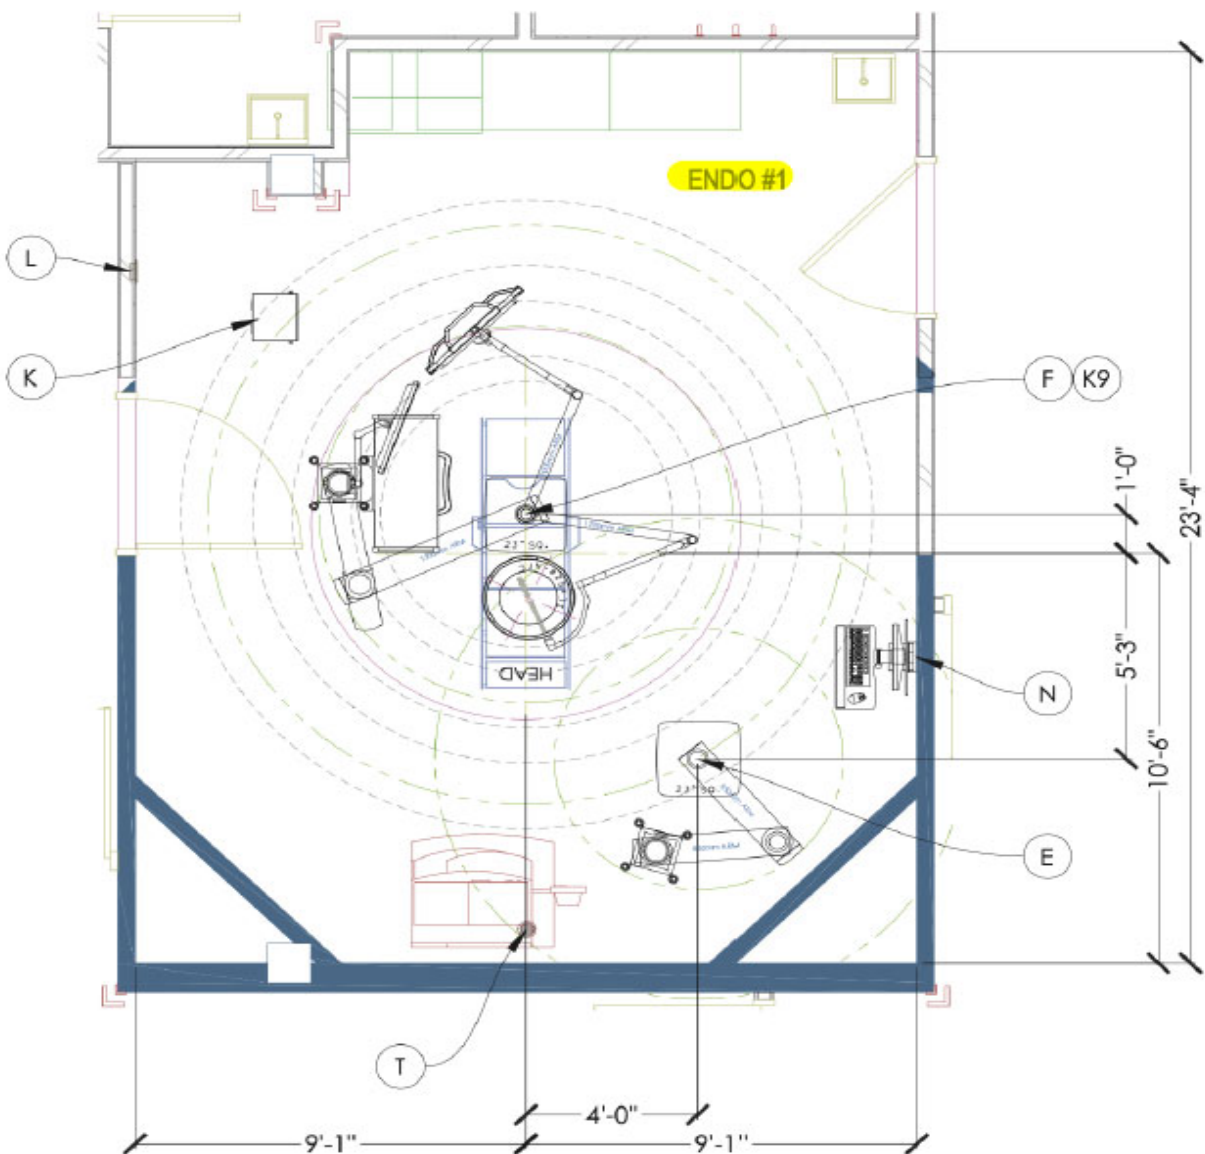



# WinnMed

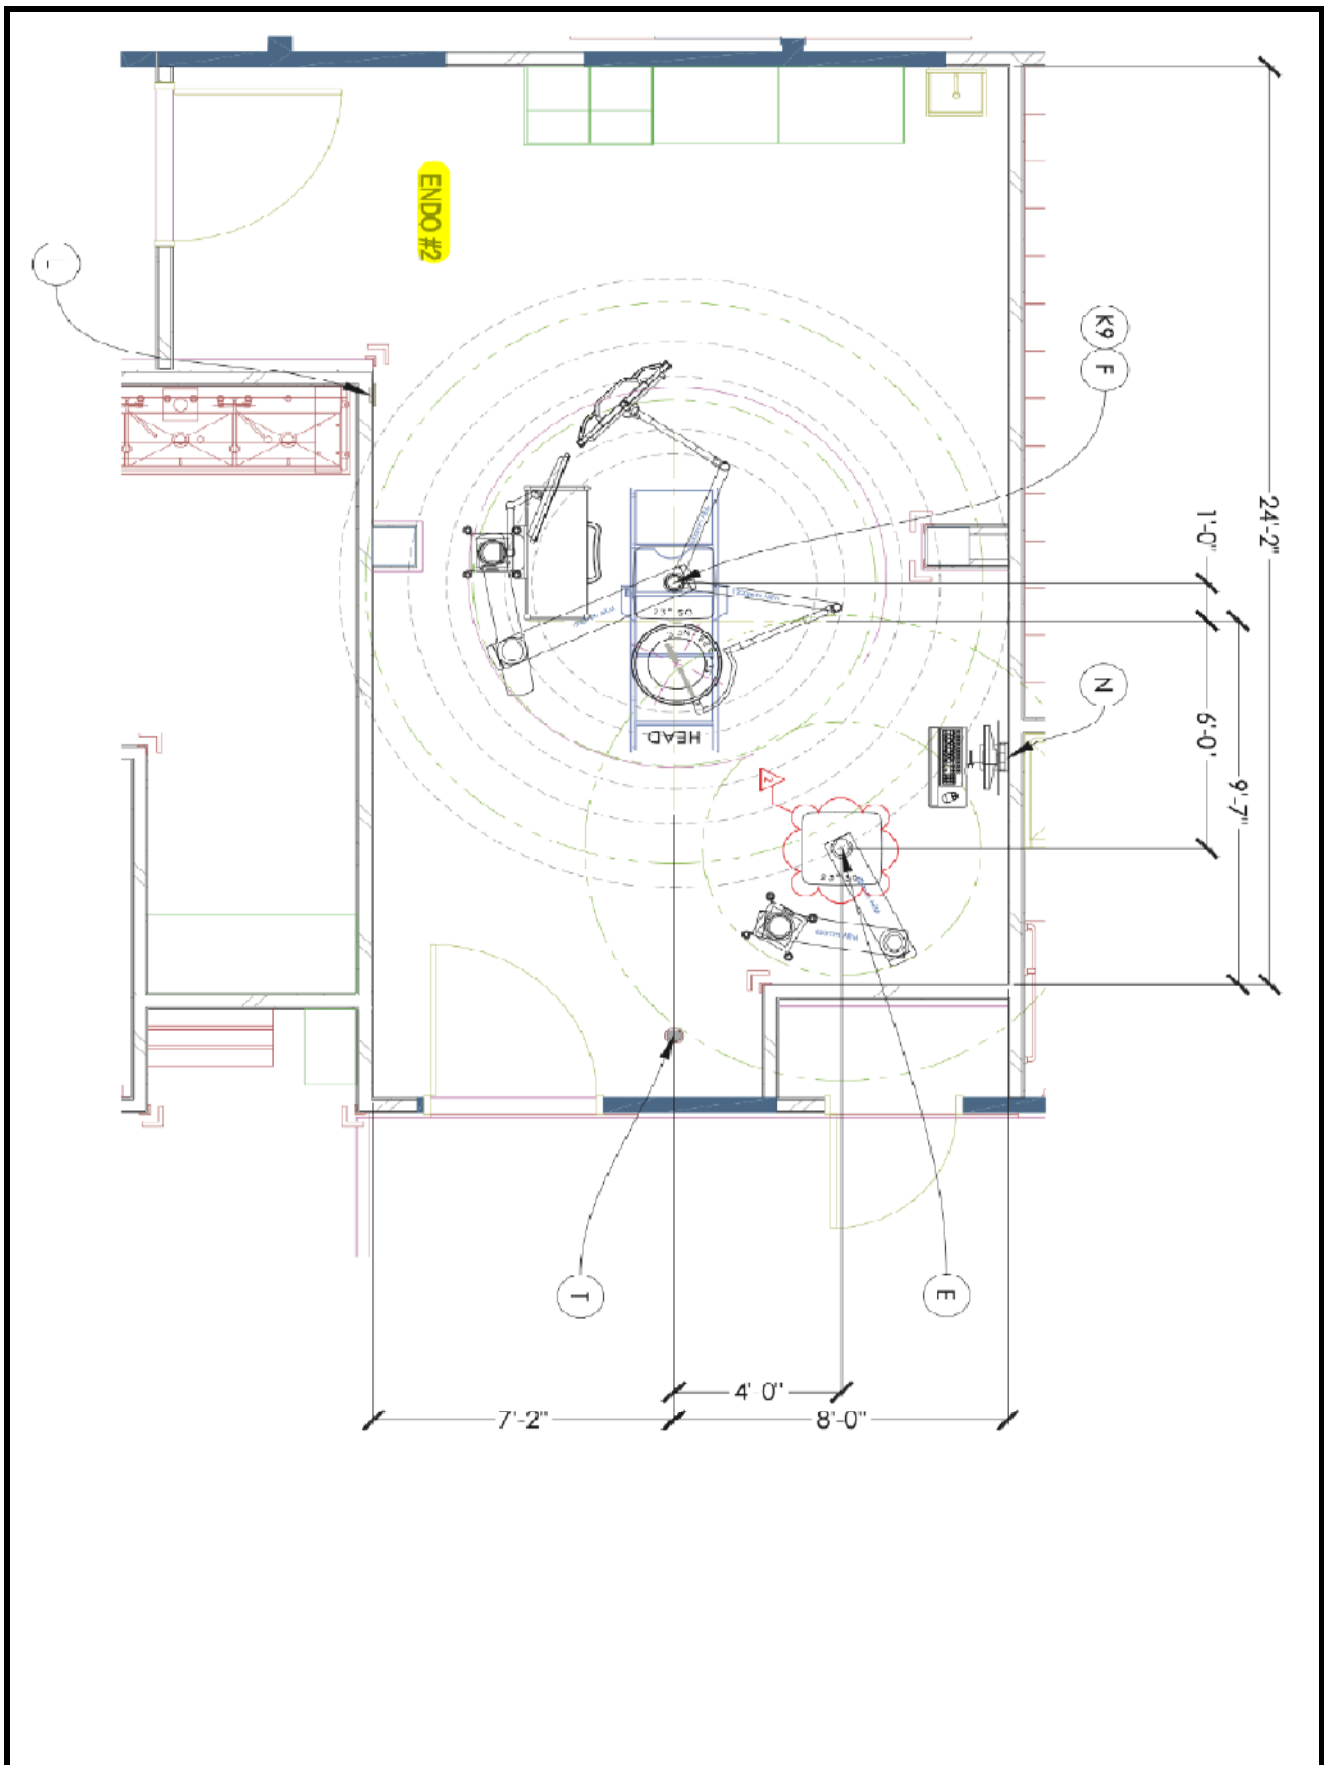



## Endo Rooms 1 and 2 - TC Equipment Boom / TC F528 Light with UDM

Quote:10179648 Rev4 Block#5 / 10

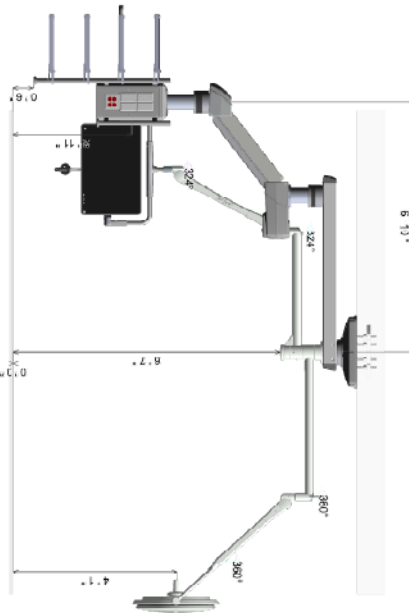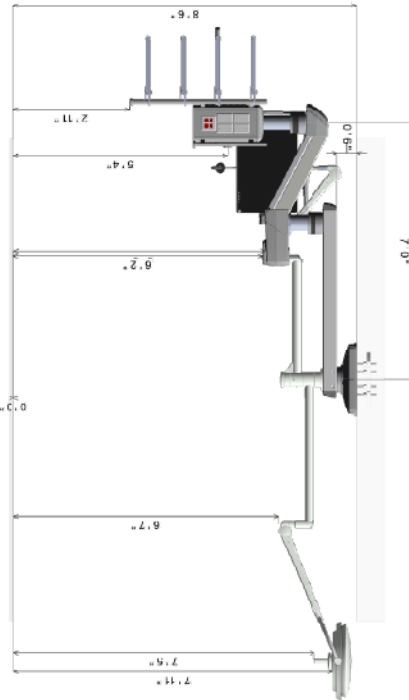

Top S-Series Equipment Boom	
Boat System	Electric
Medical Rail Type	Fairfield
Top Arm Length	1300mm
Bottom Arm Length	500mm
Mid Tube Length	150mm
Column Tube Length	350mm
Weight Capacity (see note 4)	277 lbs.
Total Thrust (used %)	63
Gas-Hose Length (in)	14.77
Packaging Type	Stark Up
Manufacturing Notes:	Do Not Assemble From MFR

Top S-Series Equipment Boom Shelves	
Rail Type	Fairfield
Shelf 1	1000mm
Shelf 2	750mm w/Corrds
Shelf 3	750mm
Shelf 4	750mm

TC Configuration - SLX Lights	
Arm No. 1 (MP1)	Arm No. 2 (MP2)
Equipment	SLX528
Horizontal Arm	1200
HCT Length	None
Tube Length	0
Cardanic	HFC
First Monitor	No
Dial Control	No
Main Voltage	120VAC

confirm the ceiling height and agree with the dimensions as drawn. I confirm the equipment configuration as shown including arm lengths, platforms, gas key styles, brand, and location; electronic, and low voltage reactions and locations. I understand that any changes made after an order is in production will result in a change order fee and a delay in shipment.	
CUSTOMER APPROVALS	SIGNATURE
REPRESENTATIVE	PRINT NAME & TITLE
DATE	DATE
FACILITY ENGINEERING	
<p><b>NOTES:</b></p> <p>1 For weights, moments, and installation details, please refer to the Stryker Pre-installation manual.</p> <p>2 It is the owner's responsibility to provide the support structure to meet requirements listed in the Pre-install Manual.</p> <p>3 Customer is responsible for reviewing and approving Gas Key Style and Manufacturer.</p> <p>4 Total weight capacity available for all Stryker and customer supplied accessories, based on weight moments listed in S-SERIES Pre-install Manual.</p> <p>5 Bottom of Stryker mounting plate must be installed at 3.2" above finished ceiling plane. All vertical boom dimensions shown in drawing are dependent on this requirement.</p>	
<p><b>Stryker Communications</b></p> <p>Brian Vinyard brian.vinyard@stryker.com www.stryker.com</p>	
<p><b>Project:</b></p> <p>Customer: WINNEMED MED CTR City: DECORAH Equip ID: SP9-3-OF 528/528 Group Name: Endo Rooms 1 and 2 Quote No.: 10179648 Quote Rev No.: 4 Quote Date: 15-Aug-2023 QTY: 2 DMS Rev No.: 3 Block # 5 / 10 DMS No.: 10179648/003</p>	

Endo Rooms 1 and 2 - TC Equipment Boom

stryker

8' 6"

Quote: 10179548 Rev.4 Block#5

FRONT

RIGHT

BACK



LEFT

F1	20A125V Duplex (8 Outlets)
F4	Data Pass Thru
F3	Distribution Board

B1	Blank
B2	Blank
B3	Blank
B4	Blank
B5	20A125V Duplex (4 Outlets)

B1	20A125V Duplex (4 Outlets)
B2	Blank
B3	Blank
B4	Blank
B5	VAC

L1	Blank
L2	Blank
L3	Blank
L4	CO2
L5	20A125V Duplex (4 Outlets)

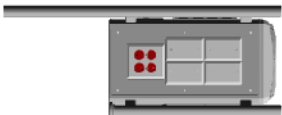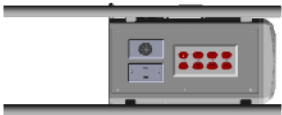

Data Communications

Qty	Description
1	Data Pass Thru
3	16 Blank Plate
1	Distribution Board

Gas Outlets

Qty	Gas Type	Key Style	Manufacturer
1	Carbon Dioxide (CO2)	D.I.S.S	Beacon Medicals
2	Vacuum	Chemron	Beacon Medicals

High Voltage

Main Power Type		Isolated			
Main Power Source	Emergency/				
Manufacturer	Location				
Loc.	Circuit Ref #	# of Circuits	Color	Outlet Box	Description
F1	1,2	2	Red	A	20A125V Duplex (8 Outlets)
RS	3	1	Red	A	20A125V Duplex (4 Outlets)
B1	4	1	Red	A	20A125V Duplex (4 Outlets)
LS	5	1	Red	A	20A125V Duplex (4 Outlets)

Circuits

Qty	Description
5	Total 15A/20A Circuits
1	Circuit for Motor and Brake

Front	Back
Multi-Functional Rail (MFR)	1000mm
Control	31mm Rear Only

I confirm the ceiling height and agree with the dimensions as shown. I confirm the equipment configuration as shown including arm lengths, platoms, gas key styles, brand, and locations, electronic, and low voltage selections and locations. I understand that any changes made after an order is in production will result in a change order fee and a delay in shipment.

NOTES:  
1. For weight, moment, and installation details, please refer to the Stryker Pre-installation manual.  
2. It is the owner's responsibility to provide the support structure to meet requirements stated in the Pre-install Manual.  
3. Customer is responsible for reviewing and approving Gas Key Style and Manufacturer.  
4. Total weight capacity available for all Stryker and customer supplied accessories, based on weight moments listed in S-SERIES Pre-install Manual.  
5. Bottom of Stryker mounting plate must be installed at 3.0' above finished floor. Stryker mechanical boom dimensions shown in drawing are dependent on this requirement.

Stryker Communications  
501 Shawnee Blvd  
Decorah, IA 52101  
Phone: (877) 788-8706  
Fax: (402) 724-2269  
www.stryker.com

Sales Representative :  
Brian Kipfel  
brian.kipfel@stryker.com

CUSTOMER APPROVALS	SIGNATURE	PRINT NAME & TITLE	DATE
CLINICAL REPRESENTATIVE			
FACILITY ENGINEERING			

Project:  
Customer: WINN-SHEK MED CTR  
Equip ID: SPS-3-C  
Group Name: Endo Rooms 1 and 2  
Quote No.: 10179548  
Quote Date: 15-Aug-2023  
Quote Fax No.: 4  
DWG Rev No.: 3  
DWG No.: 10179548-003

Proposal # 10179548 v. 4 | Proposal Year: 2023 | Effective Through: 03-Apr-2023

WINN-SHEK MED CTR Proposal | Page 2 of 20

# WinnMed

Room: Endo Rooms 1 and 2

TC Equipment Boom



## S-Series Standard Equipment Management System

Introducing a new standard in equipment management. With a completely redesigned user interface and a compact, fully customizable system, it has never been easier to manage your services and maneuver your equipment.

PART #	DESCRIPTION	QTY	LIST PRICE	EXT LIST PRICE
SPS-3-C	S-SERIES, STANDARD POWERED, 3 ROW, 2 A	2		
<div> <div> <b>Mounting Details</b>            Mounting Plate: Single Common Plate            Multiple Suspension Mounting: TC Only            Ceiling Cover: Standalone            Brake System: Electric         </div> <div> <b>Shelves</b>            Shelves: 4            Shelf Rail Type: Fairfield            Shelf 1: 1000mm            Shelf 2: 750mm w/Controls            Shelf 3: 750mm            Shelf 4: 750mm         </div> <div> <b>High Voltage Services</b>            20A/125V Duplex (8 Outlets): 1            20A/125V Duplex (4 Outlets): 3  <b>Low Voltage Services</b>            Blank Plate: 9            Distribution Bd Plate: 1            Data Pass Thru Plate: 1         </div> <div> <b>Additional Cables</b> </div> <div> <b>Gas Services</b>            Gas Manufacturer: Beacon Medical            Gas Fitting Type: Chemtron            CO2 Gas: 1            Vac Gas: 2         </div> </div>				
<b>MFR Configuration</b> Front MFR Length: 1000mm Rear MFR Length: 531mm MFR Controls: Rear Only				
PART #	DESCRIPTION	QTY	LIST PRICE	EXT LIST PRICE
P40075	ASM, HANDLE AND SHELF WITH FAIRFIELD R	2		
P36143	ASM, SHELF MOUNT HDW	8		
P40239	ASM, SHELF WITH FAIRFIELD RAILS, 1000	2		
P40238	ASM, SHELF WITH FAIRFIELD RAILS, 750	4		
P34414	KIT, FOOT PEDAL STORAGE DRAWER, ATLAS	2		
Configuration Total:				

# WinnMed

WinnMed

Issue Date:

3/6/2024

Expansion and Renovation

Decorah, IA 52101

Furniture Specifications

CONTACT:

Ben Stevens - CFO

PHONE NUMBER:

563-387-3109

ITEM NUMBER:	26
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ITEM NAME:	Ceiling Mounted Anesthesia Boom		
ROOM NUMBER:		QUANTITY:	


## SPECIFICATION INFORMATION

MANUFACTURER: Stryker  
MODEL #: SFS-2  
DIMENSIONS: Endo Room 1 & 2  
DESCRIPTION: Ceiling Mounted Anesthesia Boom; 2 Row; 2 Arm, Air (1); VAC (2); N2O (1); O2 (2);  
WAGD (1)


## FURNITURE & EQUIPMENT IMAGE



# WinnMed

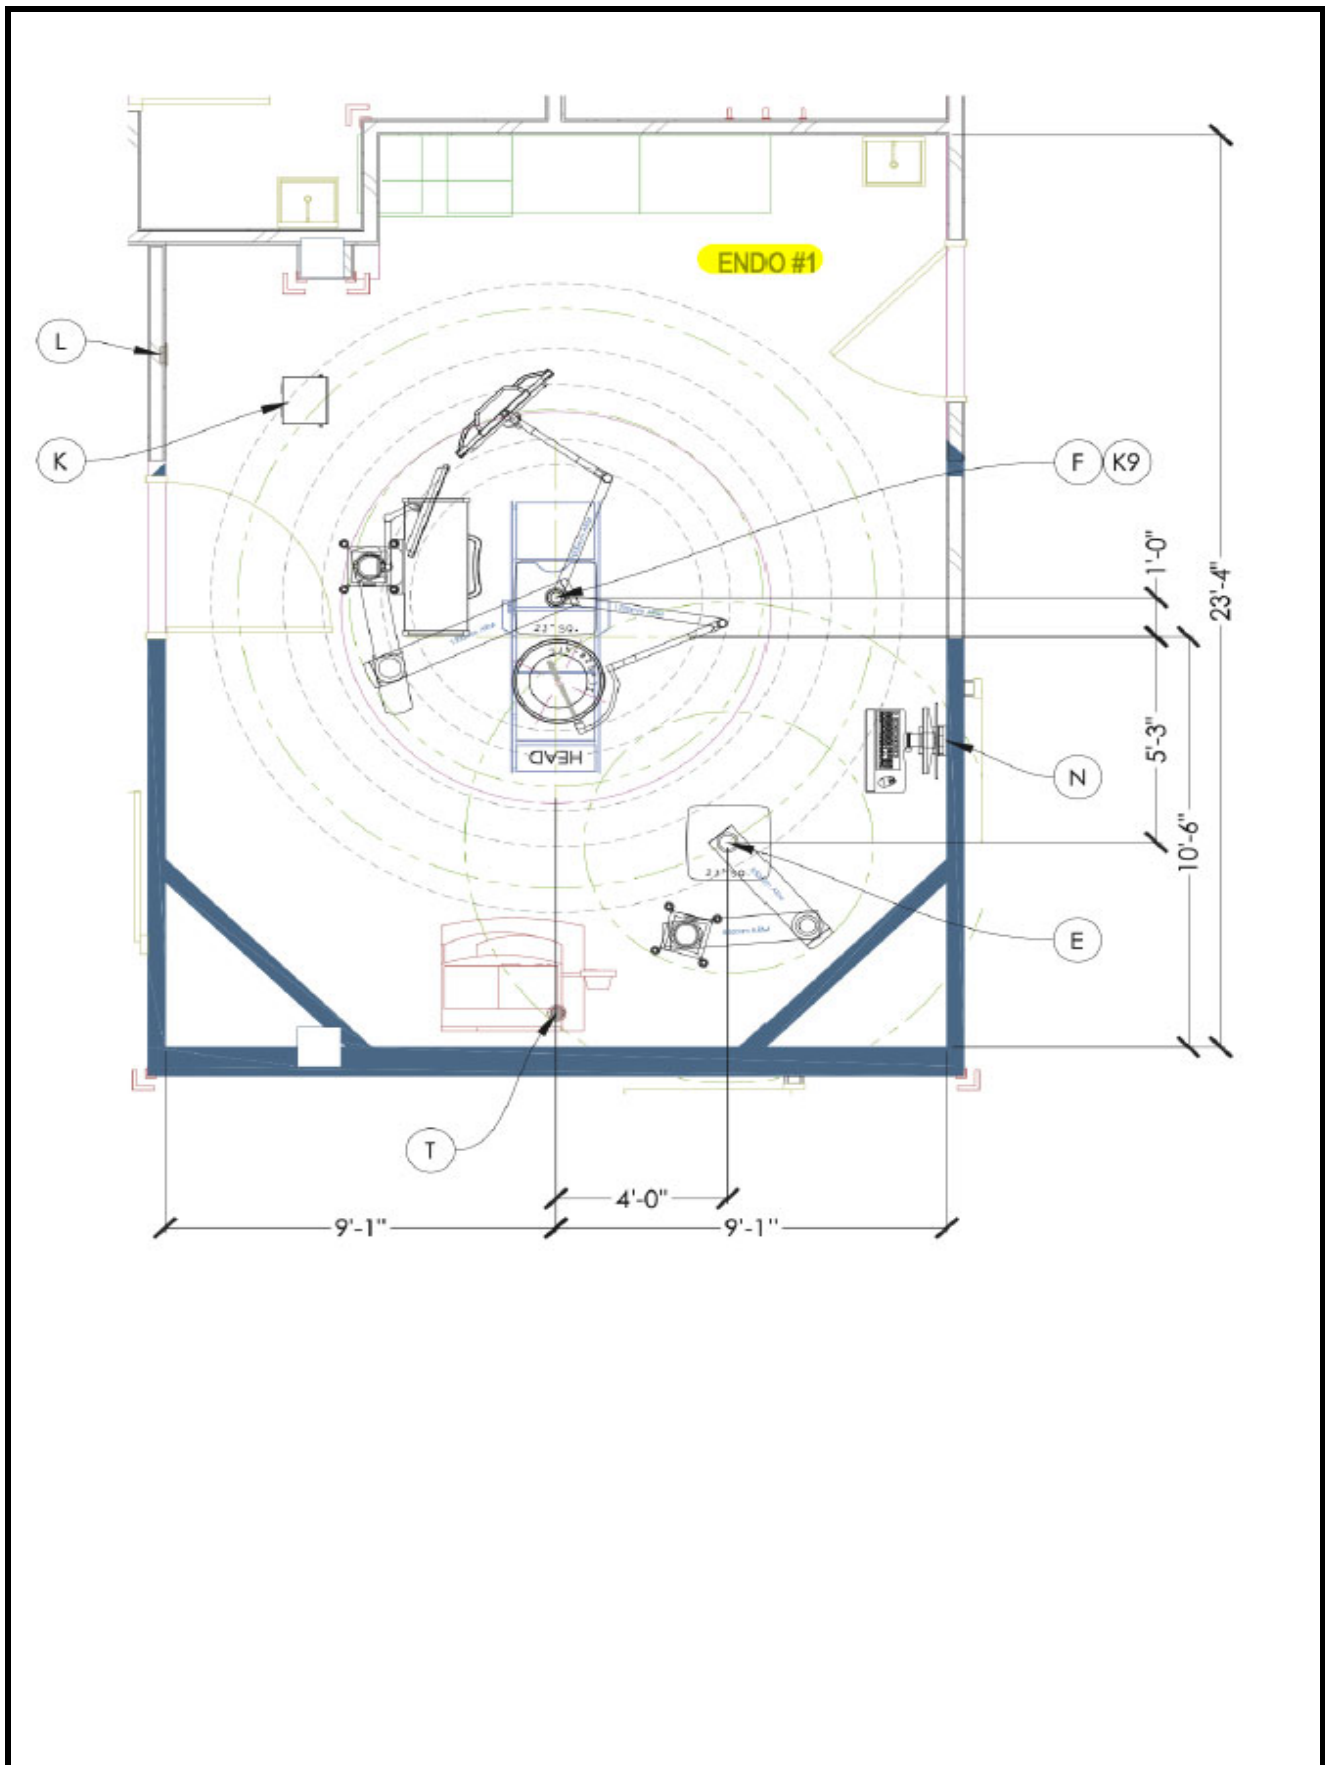


# WinnMed

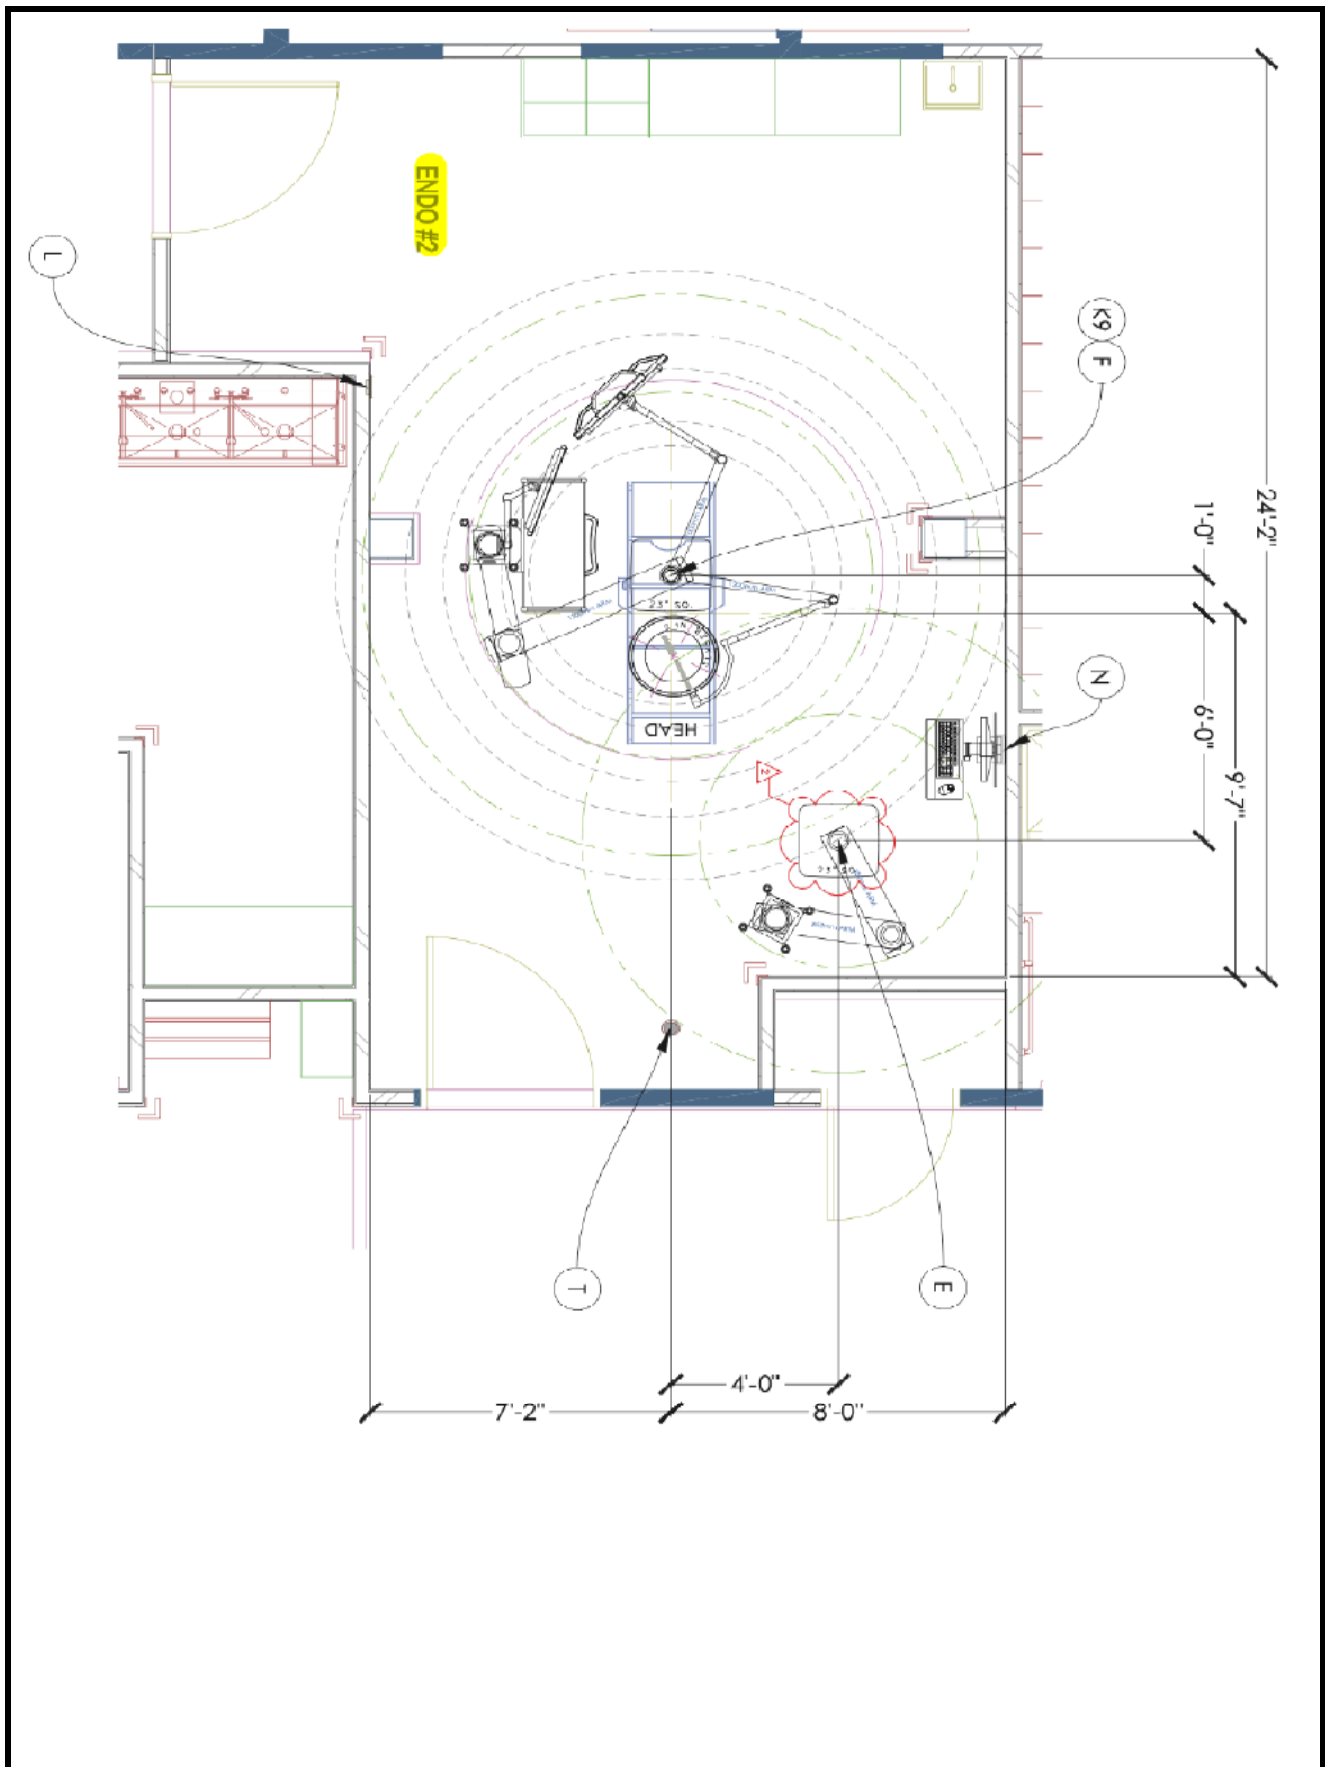

901 Montgomery Street  
Decorah, IA 52101

PHONE 563-382-2911  
FAX 563-387-3102

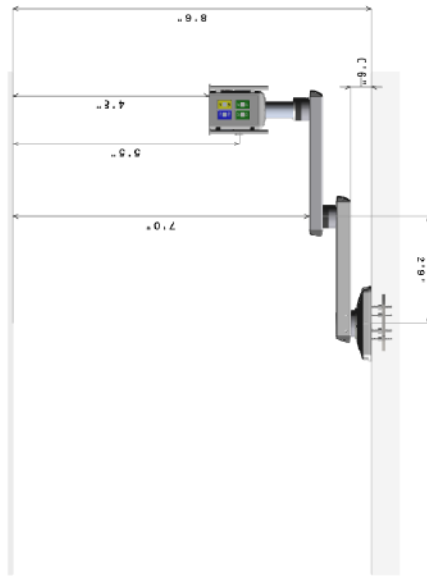

Suspension	
Brake System	Electric
Medical Rail Type	Flareball
Top Arm Length	850mm
Bottom Arm Length	850mm
Column Tube Length	260mm
Weight Capacity (see note 4)	500 lbs.
Total Travel Length (ft)	4.9
Gas Hose Length (ft)	11.98
Packaging Type	Stand Up
Manufacturing Notes	Assemble All MFR's

<p>Confirm the ceiling height and type with the dimensions as shown. I confirm the equipment configuration as shown including arm lengths, platforms, gas key, styles, brand, and locations, electronic, and low voltage selections and locations. I understand that any changes made after an order is in production will result in a change order fee and a delay in shipment.</p>			
CUSTOMER APPROVALS	SIGNATURE	PRINT NAME & TITLE	DATE
CLINICAL REPRESENTATIVE			
FACILITY ENGINEERING			
NOTES:		<p>1 For weights, moments, and installation details, please refer to the Stryker Pre-Installation manual.</p> <p>2 Stryker Communications is responsible to provide the support structure to meet requirements listed in the Pre-Install Manual.</p> <p>3 Customer is responsible for reviewing and approving Gas Key Style and Manufacturer.</p> <p>4 Total weight capacity available for all Stryker and customer supplied accessories, based on weights moments listed in S-SERIES Pre-Install Manual.</p> <p>5 Bottom of Stryker mounting plate must be installed a 3.0" above finished ceiling. Stryker anesthesia boom dimensions shown in drawing are dependent on this requirement.</p>	
<p>Stryker Communications 571 Steven Blvd. Parker, MN 55450 Phone: (763) 754-3900 Fax: (763) 754-3909 www.stryker.com</p>		<p>Stryker Representative : Brian Kipling brankipling@stryker.com</p>	
Project:		Customer: WINNESHX MED CTR	
City: DECORAH		State: Iowa	
Equip ID: SFS-2		Group Name: Endo Rooms 1 and 2	
Quote No.: 10179648		Quote Rev No.: 4	
Quote Date: 15 Aug 2023		Qty: 2	
Circle Line #:		Block #: 18	
DWG Rev No.: 6		DWG No.: 10179648S016	

Left

Circuits	
Qty	Description
3	Total 15A/20A Circuits
1	Circuit for Motor and Bunk
Multi-Functional Rail (MFR)	
Front	40mm
Back	40mm
Control	Rear Only

PHONE 563-382-2911  
FAX 563-387-3102



# WinnMed

Room: Endo Rooms 1 and 2

			Anesthesia Boom	
PART #	DESCRIPTION	QTY	LIST PRICE	EXT LIST PRICE
SFS-2	S-SERIES, STANDARD FIXED, 2 ROW, 2 ARM	2		
<b>Mounting Details</b>				
Mounting Plate	Single Common Plate			
Ceiling Cover	Standalone			
Brake System	Electric			
<b>MFR Configuration</b>				
Front MFR Length	406mm			
Rear MFR Length	406mm			
MFR Controls	Rear Only			
<b>High Voltage Services</b>				
	20A/125V-5-20R Duplex	1		
	20A/125V Duplex (4 Outlets)	2		
<b>Low Voltage Services</b>				
	Blank Plate	1		
	3rd Party Data Plate 1G Plate	1		
	Single DVI Plate	1		
	Distribution Bd Plate	1		
<b>Additional Cables</b>				
<b>Gas Services</b>				
	Gas Manufacturer	Beacon Medical		
	Gas Fitting Type	Chematron		
	Air Gas	1		
	Vac Gas	2		
	N2O Gas	1		
	O2 Gas	2		
	WAGD Gas	1		
PART #	DESCRIPTION	QTY	LIST PRICE	EXT LIST PRICE
P38064	ASSEMBLY, SINGLE DVI PLATE AND CABLE	2		
<b>Configuration Total:</b>				

# WinnMed

WinnMed

Issue Date:

3/6/2024

Expansion and Renovation

Decorah, IA 52101

Furniture Specifications

CONTACT:

Ben Stevens - CFO

PHONE NUMBER:

563-387-3109

ITEM NUMBER:	27
--------------	----

ITEM NAME:	Endoscopy Room Ancillary Parts		
ROOM NUMBER:		QUANTITY:	

## SPECIFICATION INFORMATION

MANUFACTURER: Stryker

MODEL #:

DIMENSIONS: Endo Room 1 & 2

DESCRIPTION: Endoscopic Room Ancillary Parts; DVI Monitor Ports (Total 6); Cable Assembly; Fiber Optic; DVI Plate; BNC Plate and Cable

## FURNITURE & EQUIPMENT IMAGE



# WinnMed

Room: Endo Rooms 1 and 2

**stryker**

## Ancillary Parts

PART #	DESCRIPTION	QTY	LIST PRICE	EXT LIST PRICE
0678000541	DVI UPGRADE EXTRA MONITOR	6		
0100224468	CABLE ASSY, RUGGED FIBER OPTIC DVI	4		
0678000978	ASSY, SINGLE GANG DVI PLATE	2		
P38061	ASSEMBLY, SINGLE BNC PLATE AND CABLE	2		
Ancillary Parts Total:				

# WinnMed

WinnMed

Issue Date:

3/6/2024

Expansion and Renovation

Decorah, IA 52101

Furniture Specifications

CONTACT:

Ben Stevens - CFO

PHONE NUMBER:

563-387-3109

ITEM NUMBER:	28
--------------	----

ITEM NAME:	OR 1 Surgical Light		
ROOM NUMBER:		QUANTITY:	

## SPECIFICATION INFORMATION

MANUFACTURER: Stryker

MODEL #:


DIMENSIONS: OR 1


DESCRIPTION: OR 1 Surgical Light w/ Monitor; 2 Arm; Handle Integrated Camera; Wall Control Display; Sterile Control Prep & Light Handle

## FURNITURE & EQUIPMENT IMAGE



# WinnMed

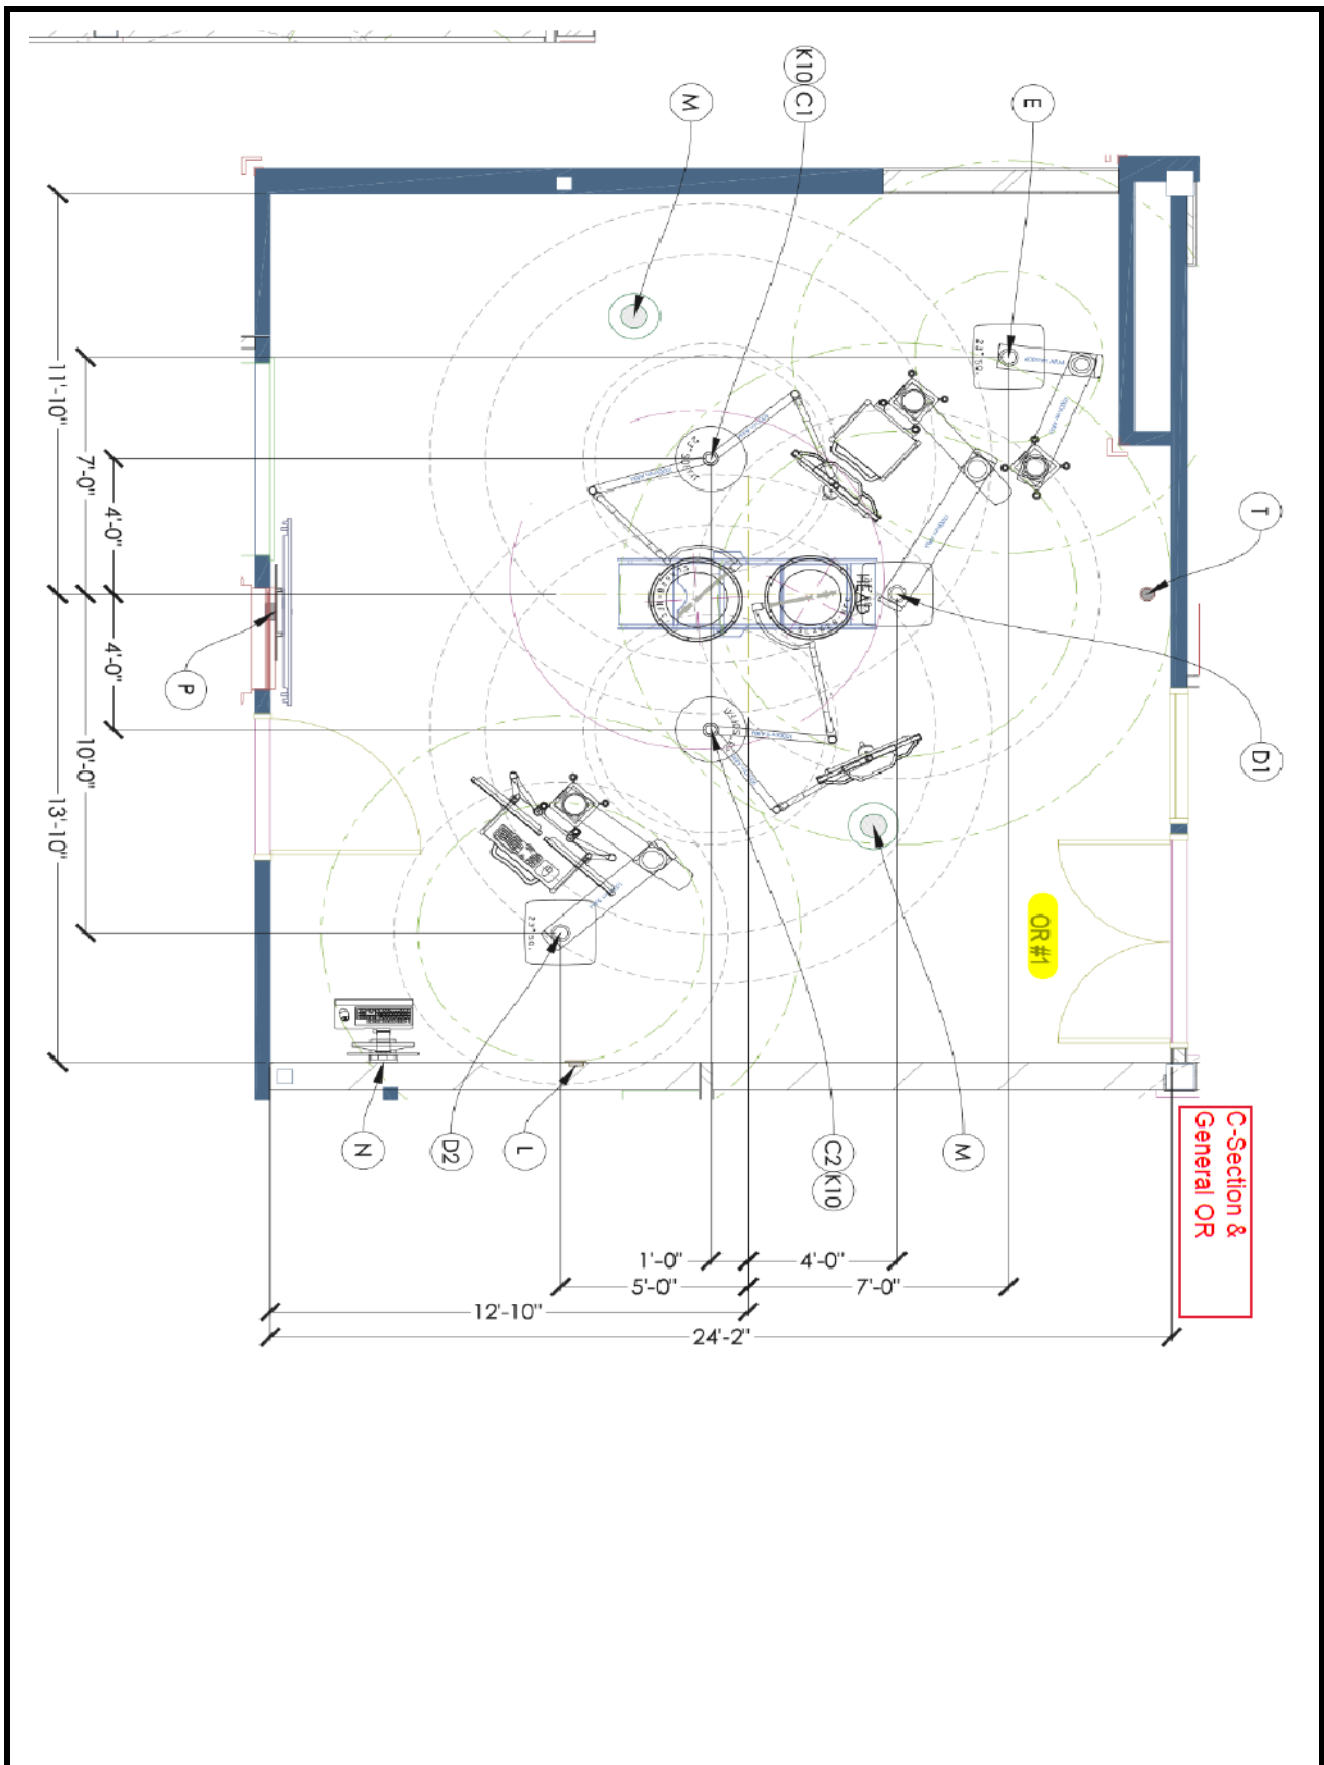

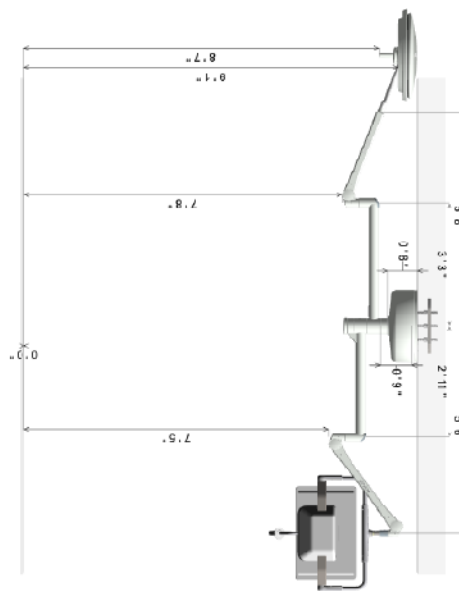stryker  
5'6"

arm No.1 (MP1)		arm No.2 (MP2)	
Equipment	GLX020	Equipment	JDM (19' - 32')
Horizontal Arm	1300	Horizontal Arm	300
HCT Length	None	HCT Length	None
Cardiac	MFC	HCT Control	No
Dial Control	No	First Monitor	JDM (19' - 32')
Alarm Voltage	120VAC	Video Bundle	Synedun

DATE

---

For weights, moments, and installation details, please refer to the Stryker Pre-Installation Manual.

Howe Mound, TX 75028  
PHONE: (877) 789-8106  
E-FAK: (408) 754-2969  
[www.styker.com](http://www.styker.com)

Quote No.: 10179548	Quote Rev No.: 4
Quote Date: 15-Aug-2023	QTY: 1

Original Line #:	
DWG Rev No.: 2	Block #: 11
DWG No.: 10179548-C002	

# WinnMed

Room: OR 1

SLX Light with UDM and ILC



## SLX Surgical Light

The Stryker Surgical Light combines innovative features, inspired by the best technology, to provide superior light quality for your surgical team. And with so many options to customize, configure, and control your light, you can now enhance the OR experience like never before.

PART #	DESCRIPTION	QTY	LIST PRICE	EXT LIST PRICE
FD 2203	LIGHT / SFP1	1		

### Mounting Details

Mounting Plate Single Common Plate

Multiple Suspension Mounting None

Ceiling Cover CB 5423004 590x197 TD 125mm

Drop Tube Length 230

### Controls

Wall Control Wall mounted (recessed)

Cardanic Control No

Control Unit Type Touch

Light Handle Type Sterile Control+ (Devon slip on)

### Power Supply

SK Box Above Ceiling or Surface Mount

### Configuration Details

Arm 1 Lighthouse

Arm Length 1000

Cardanic Style NFC

Camera Prep Yes

Arm 2 Monitor bracket

Arm Length 900

PART #	DESCRIPTION	QTY	LIST PRICE	EXT LIST PRICE
P36000	STRYKECAM FOR F-GEN	1		
P43779	BUNDLE, STRYKECAM READY	1		
CY 9000150	LIGHT OR FLAT PANEL HANDLE	1		
CY 9000103	UDM INTERSTITIAL AND SUSPENSION CABLES	1		
CY 9600105	PREPARATION CAMERA STRYKECAM HD	1		
CY 1008104	MULTI COLOR TOUCH WALL CONTROL DISPLAY FOR SINGLE, DUAL OR TRIPLE F-GENERATION LIGHT CONFIGURATION	1		
CY 9000122	STERILE CONTROL PREP	1		
CY 9000123	STERILE CONTROL+ LIGHT HANDLE	1		

Configuration Total:

# WinnMed

WinnMed

Issue Date:

3/6/2024

Expansion and Renovation

Decorah, IA 52101

Furniture Specifications

CONTACT:

Ben Stevens - CFO

PHONE NUMBER:

563-387-3109

ITEM NUMBER:	29
--------------	----

ITEM NAME:	OR 1 Surgical Light		
ROOM NUMBER:		QUANTITY:	

## SPECIFICATION INFORMATION

MANUFACTURER: Stryker

MODEL #:

DIMENSIONS: OR 1


DESCRIPTION: OR 1 Surgical Light w/ Monitor; 2 Arm; Sterile Control Prep & Light Handle



## FURNITURE & EQUIPMENT IMAGE





# WinnMed

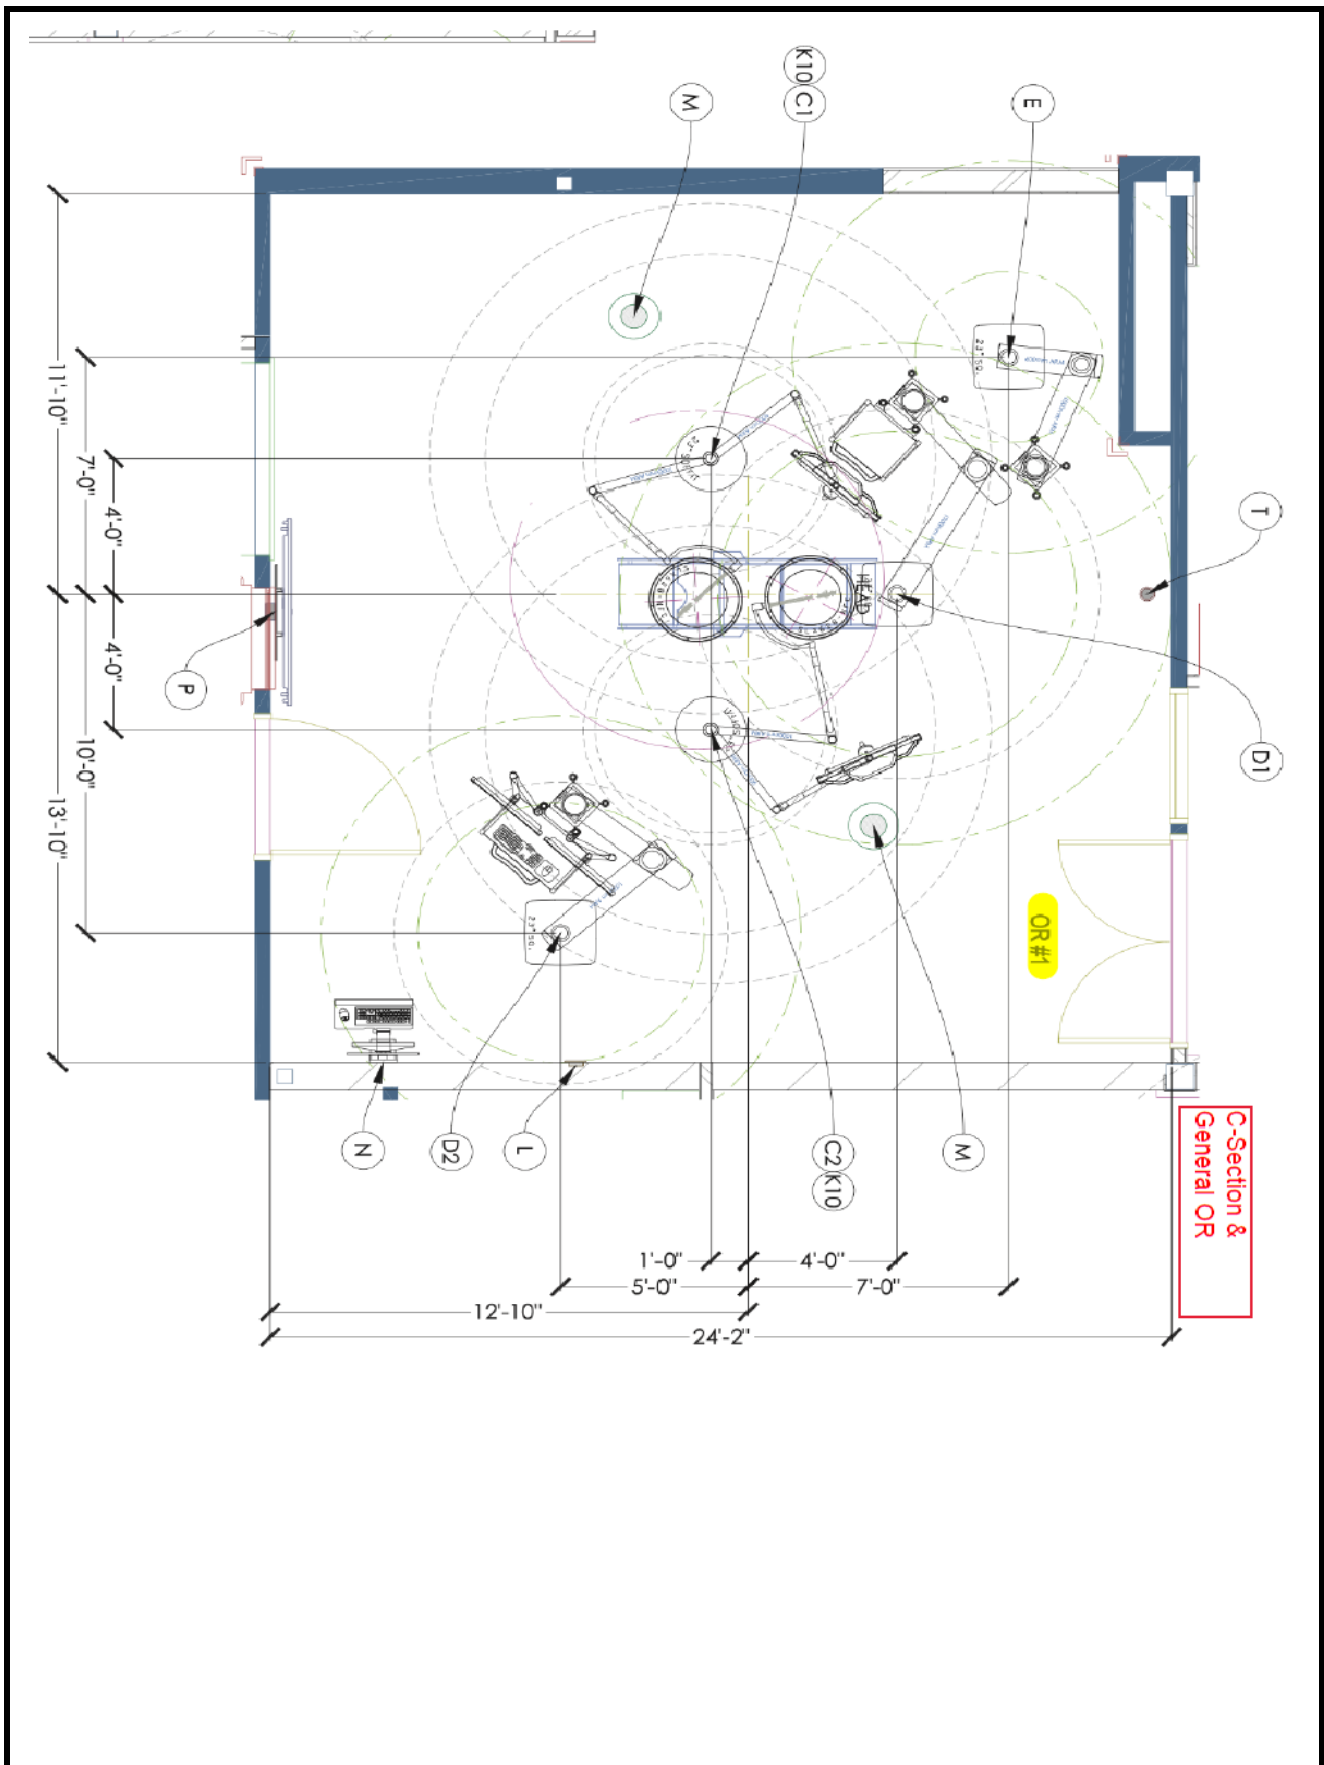

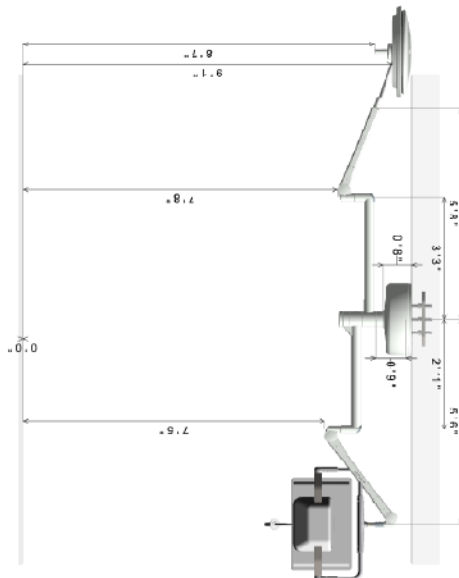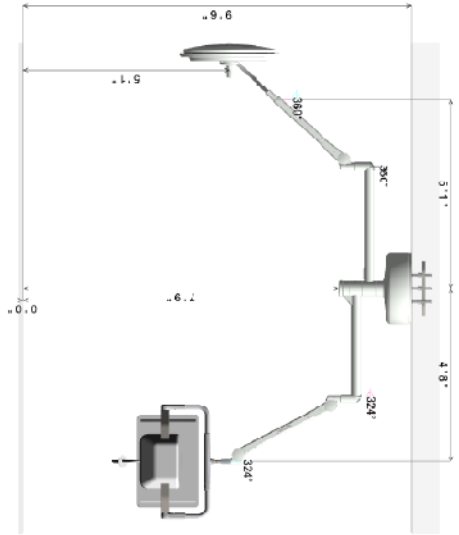

Main Mount	
Mounting Plate Type	Single Common Plate
Ceiling Coar	CB SL23004
Tube Length	230
Electronics in SK Box	No
Cable Type	None
Central Endb Use	No
Light Handle Type	Beckhold
First Configuration?	No

Arm No.1 (MP1)	
Equipment	SLX628
Horizontal Arm	1000
HCT Length	None
Cedarc	NFC
Dual Control	No
Main Voltage	120V/AC

Arm No.2 (MP2)	
Equipment	UDM (19" - 32")
Horizontal Arm	900
HCT Length	None
Cedarc	No
Dual Control	UDM (19" - 32")
First Member	UDM (19" - 32")
Video Bundle	StrykerUDM

I confirm the ceiling height and agree with the dimensions as drawn. I confirm the equipment configuration as shown including arm lengths, platforms, gas key styles, brand, and locations, electronic, and low voltage selections and locations. I understand that any changes made after an order is in production will result in a change order fee and a delay in shipment.

CUSTOMER APPROVALS	SIGNATURE	PRINT NAME & TITLE	DATE
Clinical Representative			
Facility Engineering			

NOTES:  
1. For weights, moments, and installation details, please refer to the Stryker Pre-installation manuals.  
2. It is the owner's responsibility to provide the support structure to meet requirements listed in the Pre-install Manual.

Stryker Communications  
501 Shalom Blvd  
Pawnee, ND 58454  
Phone: (701) 799-4116  
Fax: (701) 799-4269  
www.stryker.com  
Sales Representative:  
Brian Klopke@stryker.com

Project	
Customer: WINNESHIE MED CTR	State: Iowa
Equip ID: F6285CP	
Group Name: OR 1	Quote Rev No.: 4
Quote No.: 10179648	QTY: 1
Quote Date: 15-Aug-2023	
Once Line #	Block #: 12
DWG Rev No.: 3	
DWG No.: 10179648C003	

# WinnMed

Room: OR 1

SLX Light with UDM

PART #	DESCRIPTION	QTY	LIST PRICE	EXT LIST PRICE
FD 2203	LIGHT / SFP1	1		

Mounting Details

Mounting Plate: Single Common Plate

Multiple Suspension Mounting: None

Ceiling Cover: CB 5423004 590x197 TD 125mm

Drip Tube Length: 239

Controls

Wall Control: Wall mounted (recessed)

Cardanic Control: No

Control Unit Type: Touch

Light Handle Type: Sterile Control+ (Devon slip on)

Power Supply

SK Box: Above Ceiling or Surface Mount

Configuration Details

Arm 1: Lighthead

Arm Length: 1000

Cardanic Style: NFC

Camera Prep: No

Arm 2: Monitor bracket

Arm Length: 900

PART #	DESCRIPTION	QTY	LIST PRICE	EXT LIST PRICE
CY 9000150	LIGHT OR FLAT PANEL HANDLE	1		
CY 9000103	UDM INTERSTITIAL AND SUSPENSION CABLES	1		
CY 1008104	MULTI COLOR TOUCH WALL CONTROL DISPLAY FOR SINGLE, DUAL OR TRIPLE GENERATION LIGHT CONFIGURATION	1		
CY 9000122	STERILE CONTROL PREP	1		
CY 9000123	STERILE CONTROL+ LIGHT HANDLE	1		

Configuration Total:

# WinnMed

WinnMed

Issue Date:

3/6/2024

Expansion and Renovation

Decorah, IA 52101

Furniture Specifications

CONTACT:

Ben Stevens - CFO

PHONE NUMBER:

563-387-3109

ITEM NUMBER:	30
--------------	----

ITEM NAME:	OR 1 Ceiling Mounted Anesthesia Boom		
ROOM NUMBER:		QUANTITY:	


## SPECIFICATION INFORMATION


MANUFACTURER: Stryker  
MODEL #: SFS-2  
DIMENSIONS: OR 1  
DESCRIPTION: OR 1 Ceiling Mounted Anesthesia Boom; 2 Row, 2 Arm, 1 Air, 2 Vac, 1 N2O Gas, 2 O2, 1 WAGD Gas

## FURNITURE & EQUIPMENT IMAGE



# WinnMed

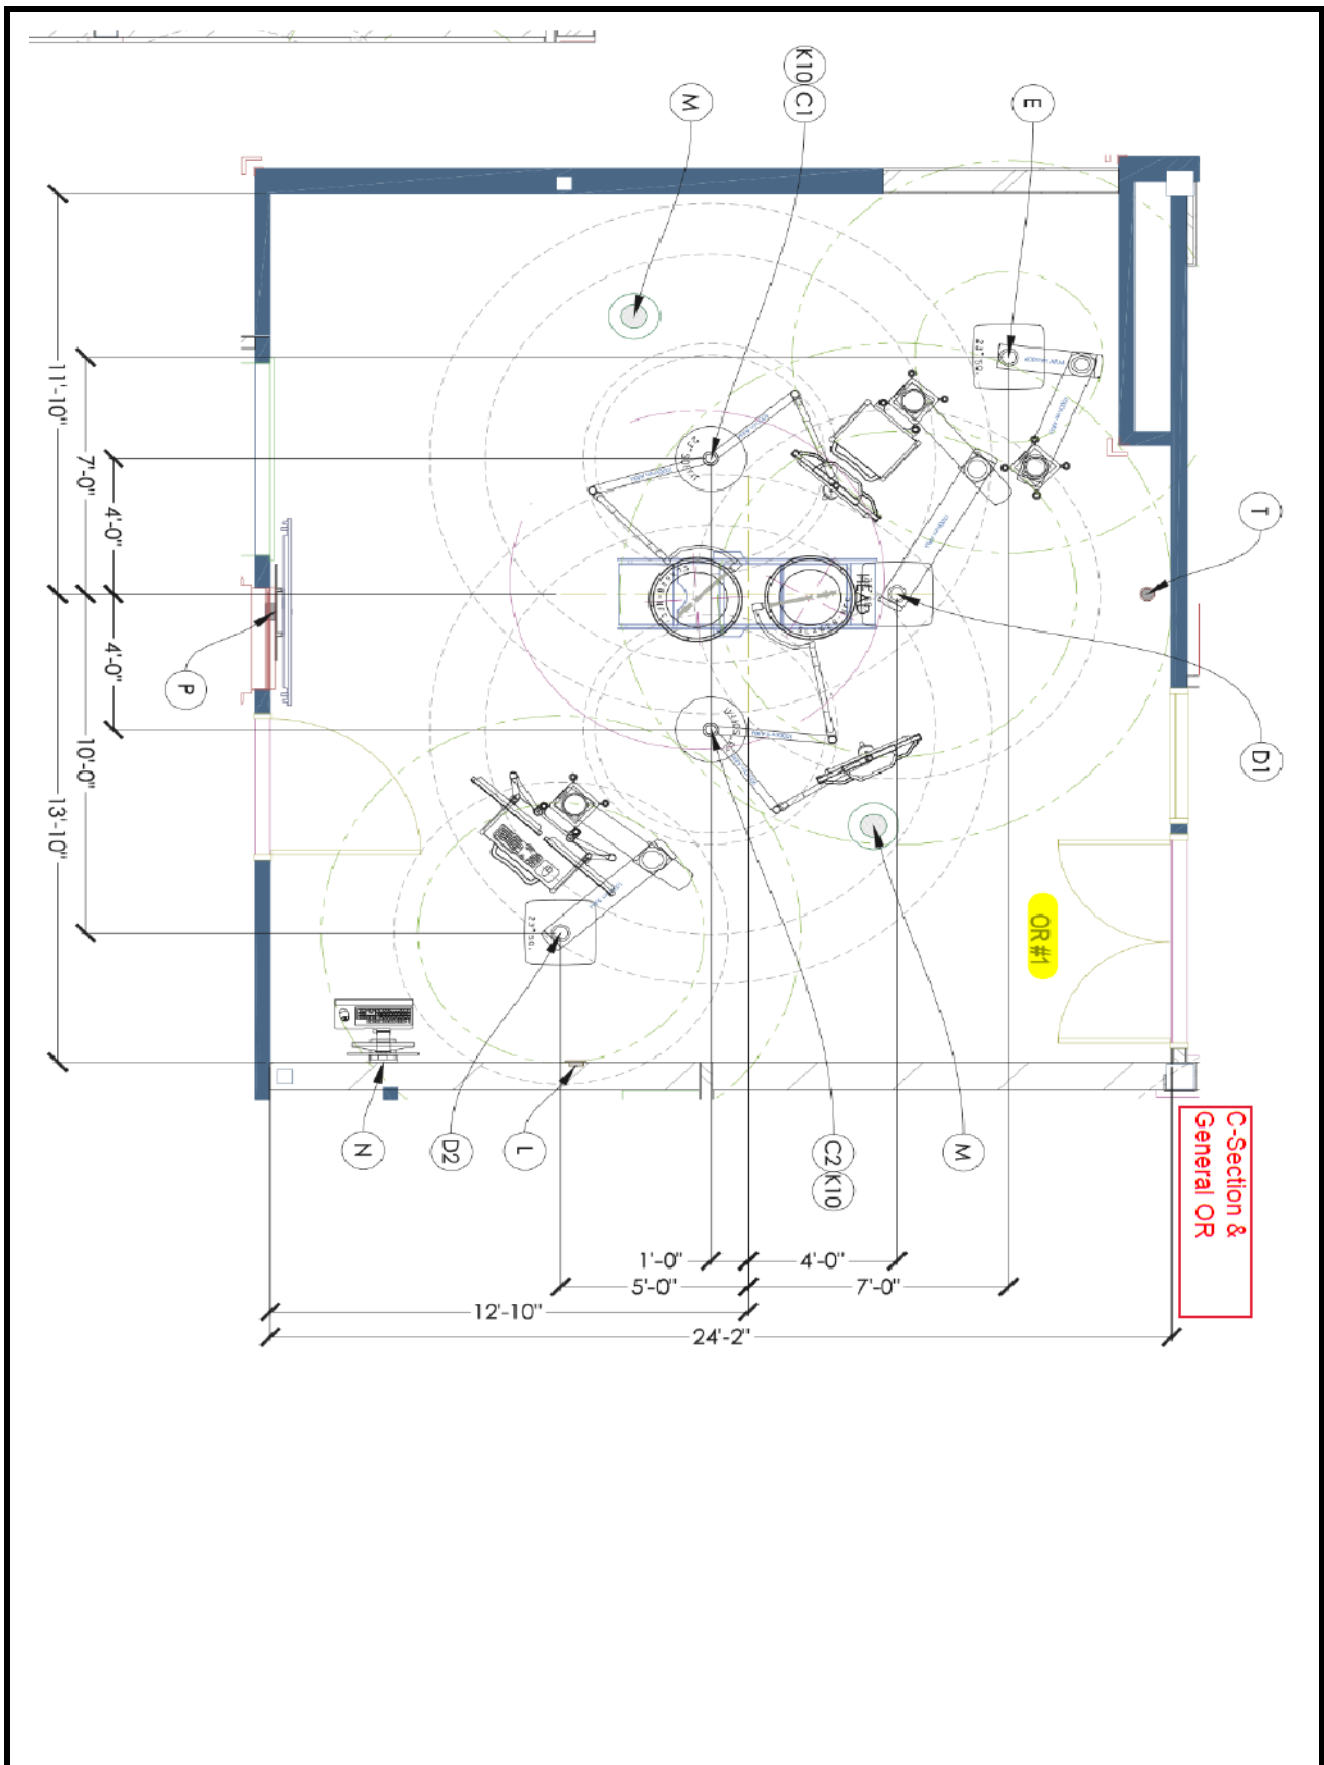

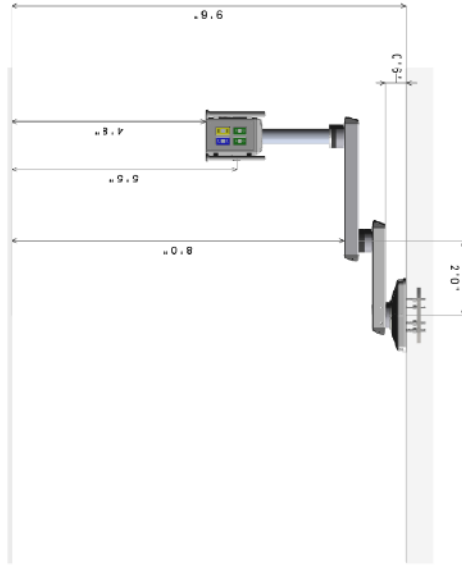

Suspension	
Brake System	Electric
Medical Rail Type	Fairfield
Top Arm Length	600mm
Bottom Arm Length	850mm
Column Tube Length	550mm
Weight Capacity (see note 4)	500 lbs
Total Travel (in)	53
Gas Hose Length (ft)	12.12
Padding Type	Static Up
Manufacturing Notes	Assemble All MFR's

I confirm the ceiling height and agree with the dimensions as drawn. I confirm the equipment configuration as shown including arm lengths, patterns, gas key styles, brand, and locations, electronic, and low voltage selections and locations. I understand that any changes made after an order is in production will result in a change order fee and a delay in shipment.			
CUSTOMER APPROVALS	SIGNATURE	PRINT NAME & TITLE	DATE
CLINICAL REPRESENTATIVE			
FACILITY ENGINEERING			
NOTES:			
1 For weight, moment, and installation details, please refer to the Stryker Pre-Installation Manual.			
2 It is the owner's responsibility to provide the support structure to meet requirements listed in the Pre-Installation Manual.			
3 Customer is responsible for reviewing and approving Gas Key Style and Manufacturer.			
4 Total weight capacity available for all Stryker and category 2 applied accessories, listed on this manual, is limited to 5,000 lbs. See the Pre-Installation Manual.			
5 Bottom of Stryker mounting plate must be installed at 2' 0" above finished ceiling plane. All vertical boom dimensions shown in drawing are dependent on this requirement.			
Stryker Communications 571 Silver Lake Pawnee, ND 58450 PHONE: (701) 794-6100 FAX: (701) 794-6100 www.stryker.com Email: sales@stryker.com			
Project:		Customer: WINNIESHEK MED CTR	
Cty: DECORAH		State: Iowa	
Equip ID: SF552			
Equip Name: UK 1			
Quote No.: 1017948		Quote Rev No.: 4	
Quote Date: 15-Aug-2013		Qty: 1	
Circle Line #:			
DWG Rev No.: 6		Block #: 17	
DWG No.: 1017948-001			

## OR 1 - Anesthesia Boom

Quote:10179648 Rev:4 Block#: 17

stryker

9'6"


FRONT

RIGHT

BACK

LEFT


F1	3rd Party Data Plate IG
F2	Distention Bd
F3	20A/125V Duplex (4 Outlets)

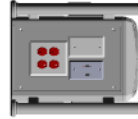

R1	O2
R2	O2
R3	Med Air
R4	N2O



B1	20A/125V Duplex (4 Outlets)
B2	COR Line 4-in-1
B3	20A/125V S-2DR Duplex

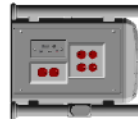

L1	WACD
L2	Blank
L3	WAC
L4	WAC



### Data Communications

Qty	Description
1	16 Blank Plate
2	16 Blank W/Sing
1	Distention Board
1	COR Line 4-in-1 Plate

### Gas Outlets

Qty	Gas Type	Key Style	Manufacturer
2	Oxygen (O2)	Chanticon	Beacon Medias
1	Nitrous Oxide (N2O)	Chanticon	Beacon Medias
1	Medical Air	Chanticon	Beacon Medias
2	Vacuum	Chanticon	Beacon Medias
1	WASD	Chanticon	Beacon Medias

### High Voltage

Main Power Type	Isolated
Main Power Source Emergency	
Manufacturer	Location
Loc	Circuit # & # of Circuits
E3	1
B1	2
B3	3
Color	Outlet Box
Red	A
Red	A
Red	A
Description	
20A/125V Duplex (4 Outlets)	
20A/125V Duplex (4 Outlets)	
20A/125V S-2DR Duplex	

### Circuits

Qty	Description
3	Total 15A/20A Circuits
1	Circuit for Motor and Brake

### Main Functional Rail (MFR)

Front	405mm
Back	405mm
Corrid	Rear Only

I confirm the ceiling height and agree with the dimensions as drawn. I confirm the equipment configuration as shown including the location of the equipment and the dimensions of the equipment. I understand that any changes made after an order is in production will result in a change order fee and a delay in shipment.

### NOTES:

- For weights, movements, and installation details, please refer to the Stryker Pre-Installation manuals.
- It is the customer's responsibility to provide the support structure to meet the weight and movement requirements of the equipment.
- Customer is responsible for reviewing and approving Gas Key Style and accessories, based on weights moments listed in S-SERIES Pre-Install Manual.
- Total weight capacity available for all Stryker and customer supplied accessories, based on weights moments listed in S-SERIES Pre-Install Manual.
- Bottom of Stryker mounting plate must be installed at 3'0" above finished ceiling plane. All vertical boom dimensions shown in drawings are dependent on this requirement.

### Stryker Communications

571 Simon Blvd.  
Power Medial TX 75028  
EPAK: 409.754.2690  
www.stryker.com

Sales Representative :  
Brian Hilde  
brian.hilde@stryker.com

Project	Customer: WINNESHIEK MED CTR	State: IOWA
City: DECORAH		
Equip ID: SFS-2		
Group Name: OR 1		
Quote No: 10179648	Quote Rev No.: 4	
Quote Date: 15-Aug-2023	QTY: 1	
Change Line #:		
DWG Rev No: 6	Block #: 17	
DWG No: 10179648S005		

# WinnMed

Room: OR 1

## Anesthesia Boom



## S-Series Standard Equipment Management System

Introducing a new standard in equipment management. With a completely redesigned user interface and a compact, fully customizable system, it has never been easier to manage your services and maneuver your equipment.

PART #	DESCRIPTION	QTY	LIST PRICE	EXT LIST PRICE
SFS-2	5-SERIES, STANDARD FIXED, 2 ROW, 2 ARM	1		
<b>Mounting Details</b>				
Mounting Plate	Single Common Plate			
Ceiling Cover	Standalone			
Brake System	Electric			
<b>Shelves</b>				
	Shelves 0			
<b>High Voltage Services</b>				
	20A/125V-5-20R Duplex 1			
	20A/125V Duplex (4 Outlets) 2			
<b>Additional Cables</b>				
<b>Gas Services</b>				
			Gas Manufacturer	Beacon Medias
			Gas Fitting Type	Chemtron
			Air Gas 1	
			Vac Gas 2	
			N2O Gas 1	
			O2 Gas 2	
			WAGD Gas 1	
<b>MFR Configuration</b>				
Front MFR Length	406mm			
Rear MFR Length	406mm			
MFR Controls	Rear Only			
<b>Low Voltage Services</b>				
	Blank Plate 1			
	3rd Party Data Plate 1G Plate 1			
	Distribution Bd Plate 1			
	COR Lite 4-in-1 Plate 1			
<b>Configuration Total:</b>				



# WinnMed

WinnMed

Issue Date:

3/6/2024

Expansion and Renovation

Decorah, IA 52101

Furniture Specifications

CONTACT:

Ben Stevens - CFO

PHONE NUMBER:

563-387-3109

ITEM NUMBER:	31
--------------	----

ITEM NAME:	OR 1 Ceiling Mounted Equipment Boom		
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ROOM NUMBER:		QUANTITY:	
--------------	--	-----------	--


## SPECIFICATION INFORMATION



MANUFACTURER: Stryker  
MODEL #: SPS-3-C  
DIMENSIONS: OR 1  
DESCRIPTION: Ceiling Mounted Equipment Management System; 3 Row, 4 Shelves; Foot Pedal Storage Drawer

## FURNITURE & EQUIPMENT IMAGE



# WinnMed

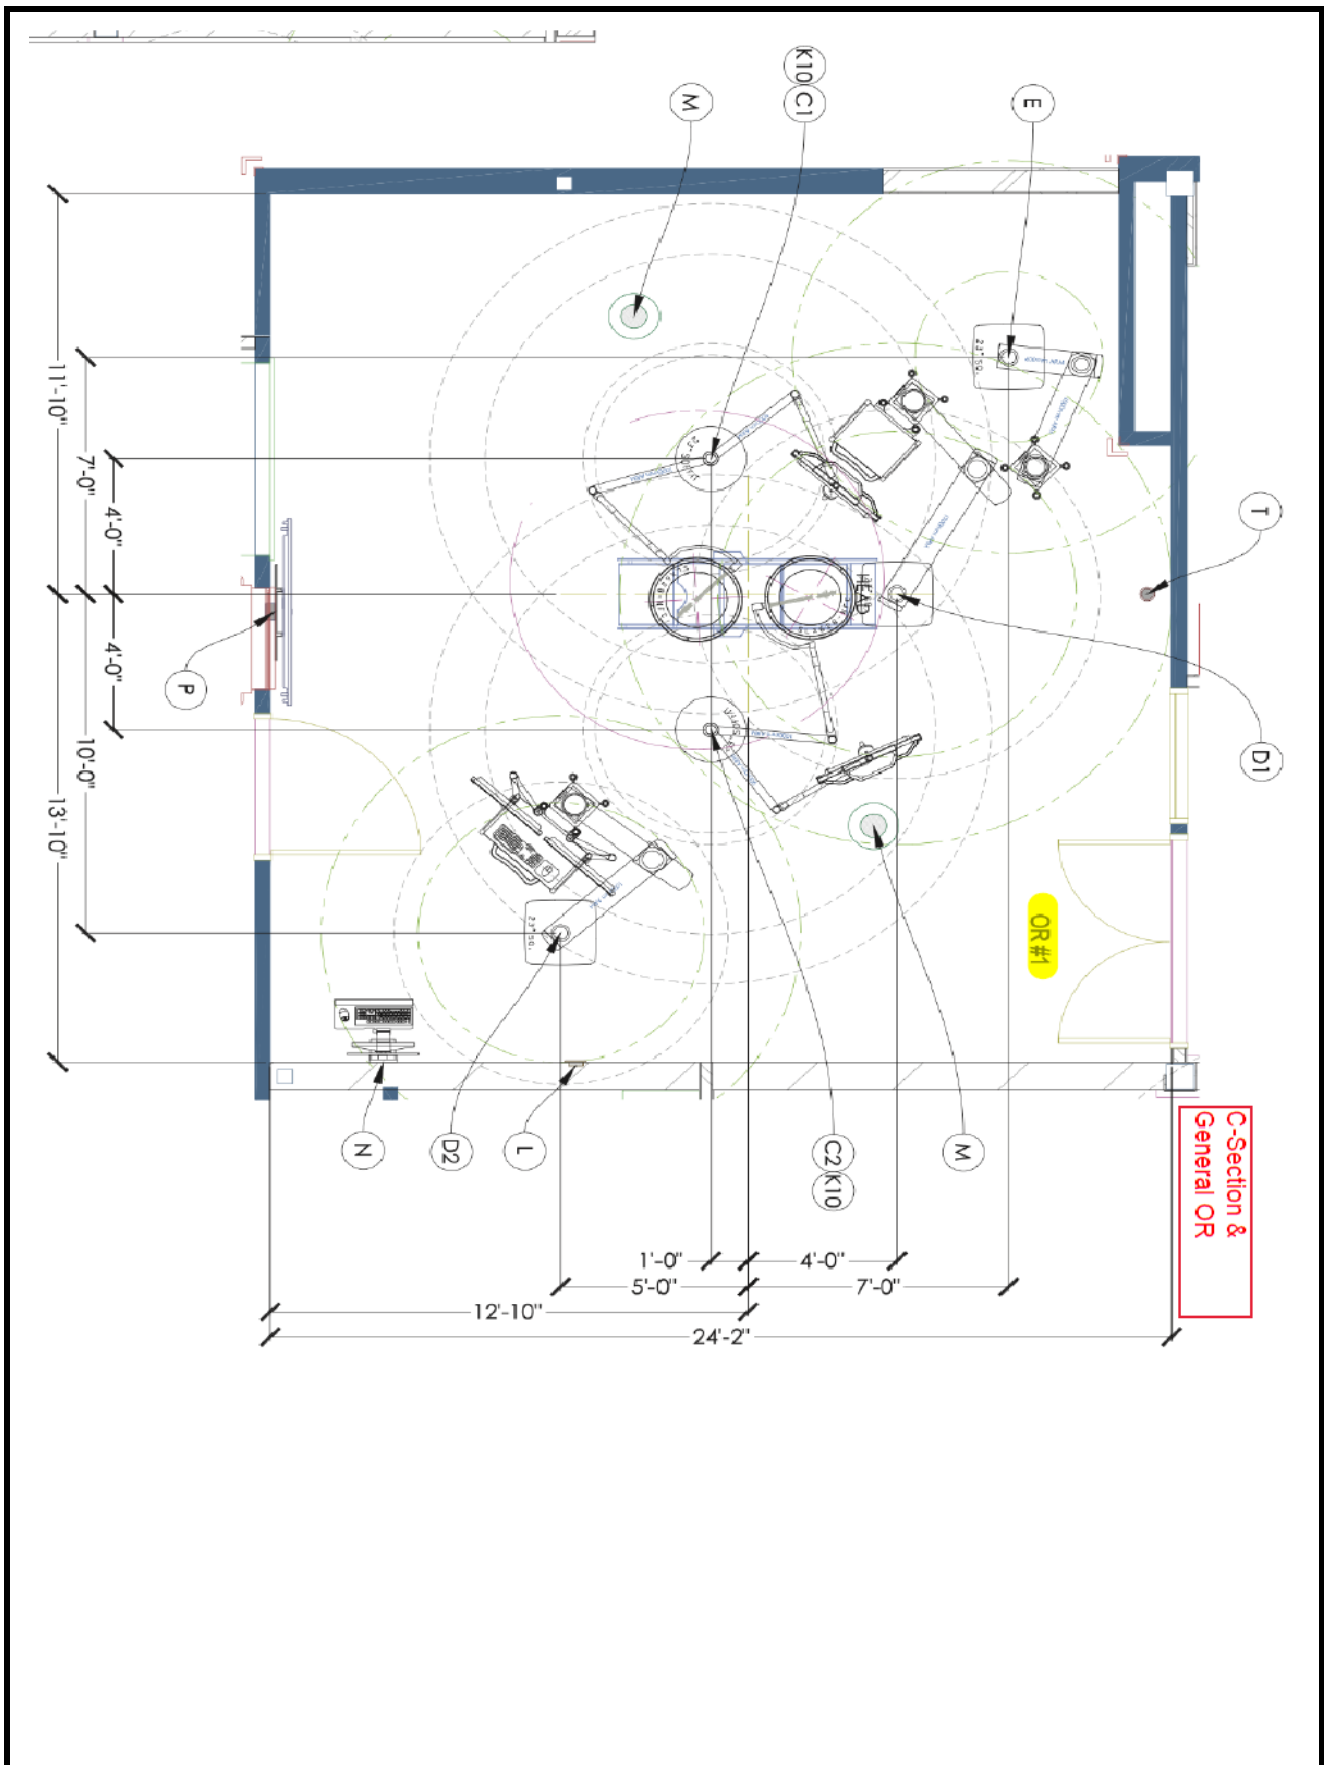

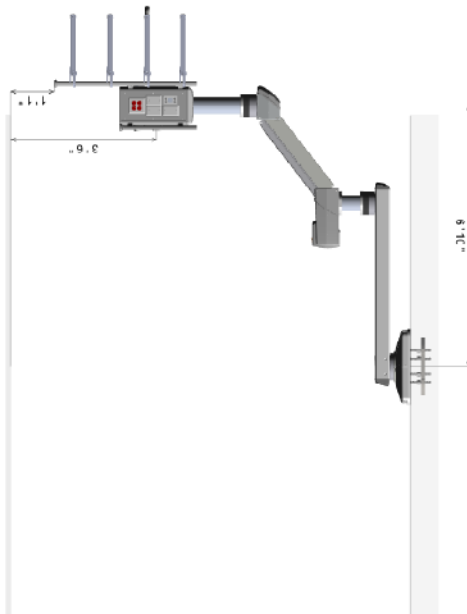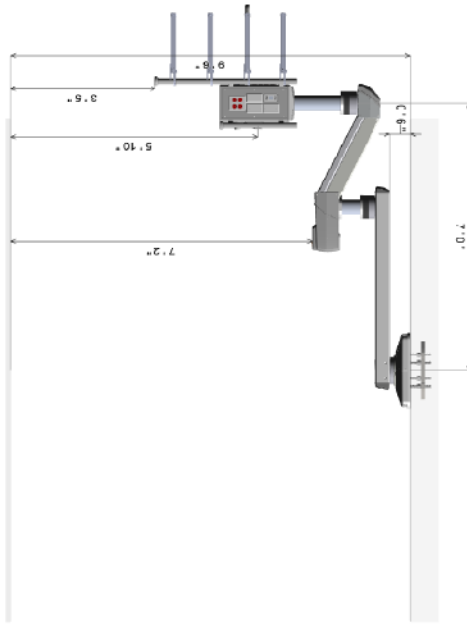


Suspension		S-Series Equipment Boom Shelves	
Brake System	Electric	Rail Type	Fairfield
Medical Rail Type	Fairfield	Shelf 1	315mm
Top Arm Length	1300mm	Shelf 2	315mm w/Controls
Bottom Arm Length	900mm	Shelf 3	315mm
Mid Tube Length	150mm	Shelf 4	315mm
Column Tube Length	400mm		
Weight Capacity (see note 4)	267 lbs		
Total Tross Used (%)	44		
Gas Hose Length (ft)	15.28		
Packaging Type	Stand Up		
Manufacturing Notes	Do Not Assemble From MFR		

I confirm the ceiling height and agree with the dimensions as drawn. I confirm the equipment configuration as shown including arm lengths, platforms, gas key styles, brand, and locations, electronic, and low voltage selections and locations. I understand that any changes made after an order is in production will result in a change order fee and a delay in shipment.			NOTES:		<b>Stryker Communications</b> Stryker Medical, TX 75038 PHONE: (877) 789-8106 FAX: (409) 342-9064 www.stryker.com  Sales Representative: Brian Kippel brian.kippel@stryker.com	<b>Project:</b> Customer: WINNESHIEK MED CTR City: DEORAH Equip ID: SPS-3 Group Name: ORs 1 Quote No.: 10179648 Quote Date: 15-Aug-2023 Credit Line #: DWG Rev No.: 3 DWG No.: 10179648S008
CUSTOMER APPROVALS	SIGNATURE	PRINT NAME & TITLE	DATE	1		
REPRESENTATIVE				2		
FACILITY ENGINEERING				3		
				4		
				5		

## ORs 1 - Equipment Boom

Quote:10179848 Rev:4 Block#:20


FRONT

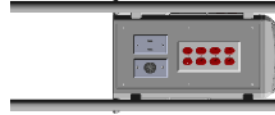

F1	20A125V Duplex (8 Outlets)
F2	Distribution B4
F3	COR Line Ends Camera


R1	CO2
R2	Bank
R3	Bank
R4	Bank
R5	20A125V Duplex (4 Outlets)

RIGHT

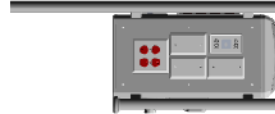

B1	COR Line 4-in-1 Plate
B2	Bank
B3	Bank
B4	Bank
B5	Inst Air Regulator

BACK

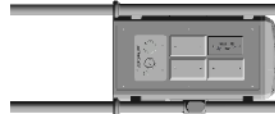

L1	20A125V Duplex (4 Outlets)
L2	Bank
L3	Bank
L4	VAC
L5	VAC

LEFT



### Data Communications

Qty	Description
8	116 Blank Plate
1	116 Blank W/String
1	Pre-Instal Power
1	COR Line 4-in-1 Plate

### Gas Outlets

Qty	Gas Type	Key Style	Manufacturer
1	Instrument Air Regulator	D13.S.	AMCO
1	Carbon Dioxide (CO2)	D13.S.	Bacon Medical
2	Vacuum	Chamber	Racoon Medical

### High Voltage

	Mean Power Type	Isolated			
	Main Power Source	Emergency			
Qty	Manufacturer	Location			
	Circuit Break #	# of Circuits	Color	Outer Box	Description
F1	12	2	Red	A	20A125V Duplex (8 Outlets)
R5	3	1	Red	A	20A125V Duplex (4 Outlets)
L1	4	1	Red	A	20A125V Duplex (4 Outlets)

### Circuits

Qty	Description
4	Total 15A/20A Circuits
1	Circuit for Motor and Brake

### Multi-Functional Rail (M-FR)

Front	1000mm
Back	531mm
Control	Rear Only

I confirm the ceiling height and agree with the dimensions as shown. I confirm the equipment configuration as shown including arm weight, patient, gas key style, view, and location, electronic, and bay voltage sections and locations. I understand that any changes made after an order is in production will result in a change order fee and a delay in shipment.

CUSTOMER APPROVALS	SIGNATURE	PRINT NAME & TITLE	DATE
CLINICAL REPRESENTATIVE			
FACILITY ENGINEERING			

### NOTES:

- For weights, moments, and installation details, please refer to the Stryker Pre-Installation manual.
- It is the owner's responsibility to provide the support structure to meet requirements listed in the Pre-Install Manual.
- Customer is responsible for reviewing and approving Gas Key Style and Moment.
- Total weight capacity available for all Stryker and customer supplied accessories, based on weights moments listed in S-SERIES Pre-Install Manual.
- Bottom of Stryker mounting plate must be installed at 30" above finished ceiling plane. All vertical column dimensions shown in drawing are dependent on this requirement.

Stryker Communications  
571 Seward Blvd.  
Riverside, CA 92508  
Phone: (951) 789-1100  
www.stryker.com

Sales Representative :  
Brian Mihal  
brian.mihal@stryker.com

Project	CUSTOMER WINNIEHEX MED CTR
City	Decorah, IA
Equip ID	SPC-3
Group Name	ORs 1
Quote No.	10179848
Quote Date	15-Aug-2023
Quote Line #	
DWG Rev No.: 3	Block #: 20

# WinnMed

Room: ORs 1 3 4

Equipment Boom



## S-Series Standard Equipment Management System

Introducing a new standard in equipment management. With a completely redesigned user interface and a compact, fully customizable system, it has never been easier to manage your services and maneuver your equipment.

PART #	DESCRIPTION	QTY	LIST PRICE	EXT LIST PRICE
SPS-3	S-SERIES, STANDARD POWERED, 3 ROW, 2 A	3		
<div> <div> <u>Mounting Details</u>            Mounting Plate Single Common Plate            Ceiling Cover Standalone            Brake System Electric         </div> <div> <u>Shelves</u>            Shelves 4            Shelf Rail Type Fairfield            Shelf 1 515mm            Shelf 2 515mm w/Controls            Shelf 3 515mm            Shelf 4 515mm         </div> <div> <u>High Voltage Services</u>            20A/125V Duplex (8 Outlets) 1            20A/125V Duplex (4 Outlets) 2    <u>Low Voltage Services</u>            Blank Plate 8            Distribution Bd Plate 1            COR Lite 4-in-1 Plate 1            COR Lite Endo Camera Plate 1         </div> <div> <u>Additional Cables</u> </div> <div> <u>Gas Services</u>            Gas Manufacturer Beacon Medaes            Gas Fitting Type Chemetron            CO2 Gas 1            Vac Gas 2            Instrument Air Gas 1         </div> </div>				
<div> <u>MFR Configuration</u>            Front MFR Length 1000mm            Rear MFR Length 531mm            MFR Controls Rear Only         </div>				
PART #	DESCRIPTION	QTY	LIST PRICE	EXT LIST PRICE
P40074	ASM, HANDLE AND SHELF WITH FAIRFIELD R	3		
P36143	ASM, SHELF MOUNT HDW	12		
P40237	ASM, SHELF WITH FAIRFIELD RAILS, 515,	9		
P34414	KIT, FOOT PEDAL STORAGE DRAWER, ATLAS	3		
Configuration Total:				

# WinnMed

WinnMed

Issue Date:

3/6/2024

Expansion and Renovation

Decorah, IA 52101

Furniture Specifications

CONTACT:

Ben Stevens - CFO

PHONE NUMBER:

563-387-3109

ITEM NUMBER:	32
--------------	----

ITEM NAME:	OR 3 Ceiling Mounted Equipment Boom		
------------	-------------------------------------	--	--

ROOM NUMBER:		QUANTITY:	
--------------	--	-----------	--


## SPECIFICATION INFORMATION

MANUFACTURER: Stryker  
MODEL #: SPS-3-C  
DIMENSIONS: OR 3  
DESCRIPTION: Ceiling Mounted Equipment Management System; 3 Row, 4 Shelves; Foot Pedal Storage Drawer



## FURNITURE & EQUIPMENT IMAGE



# WinnMed

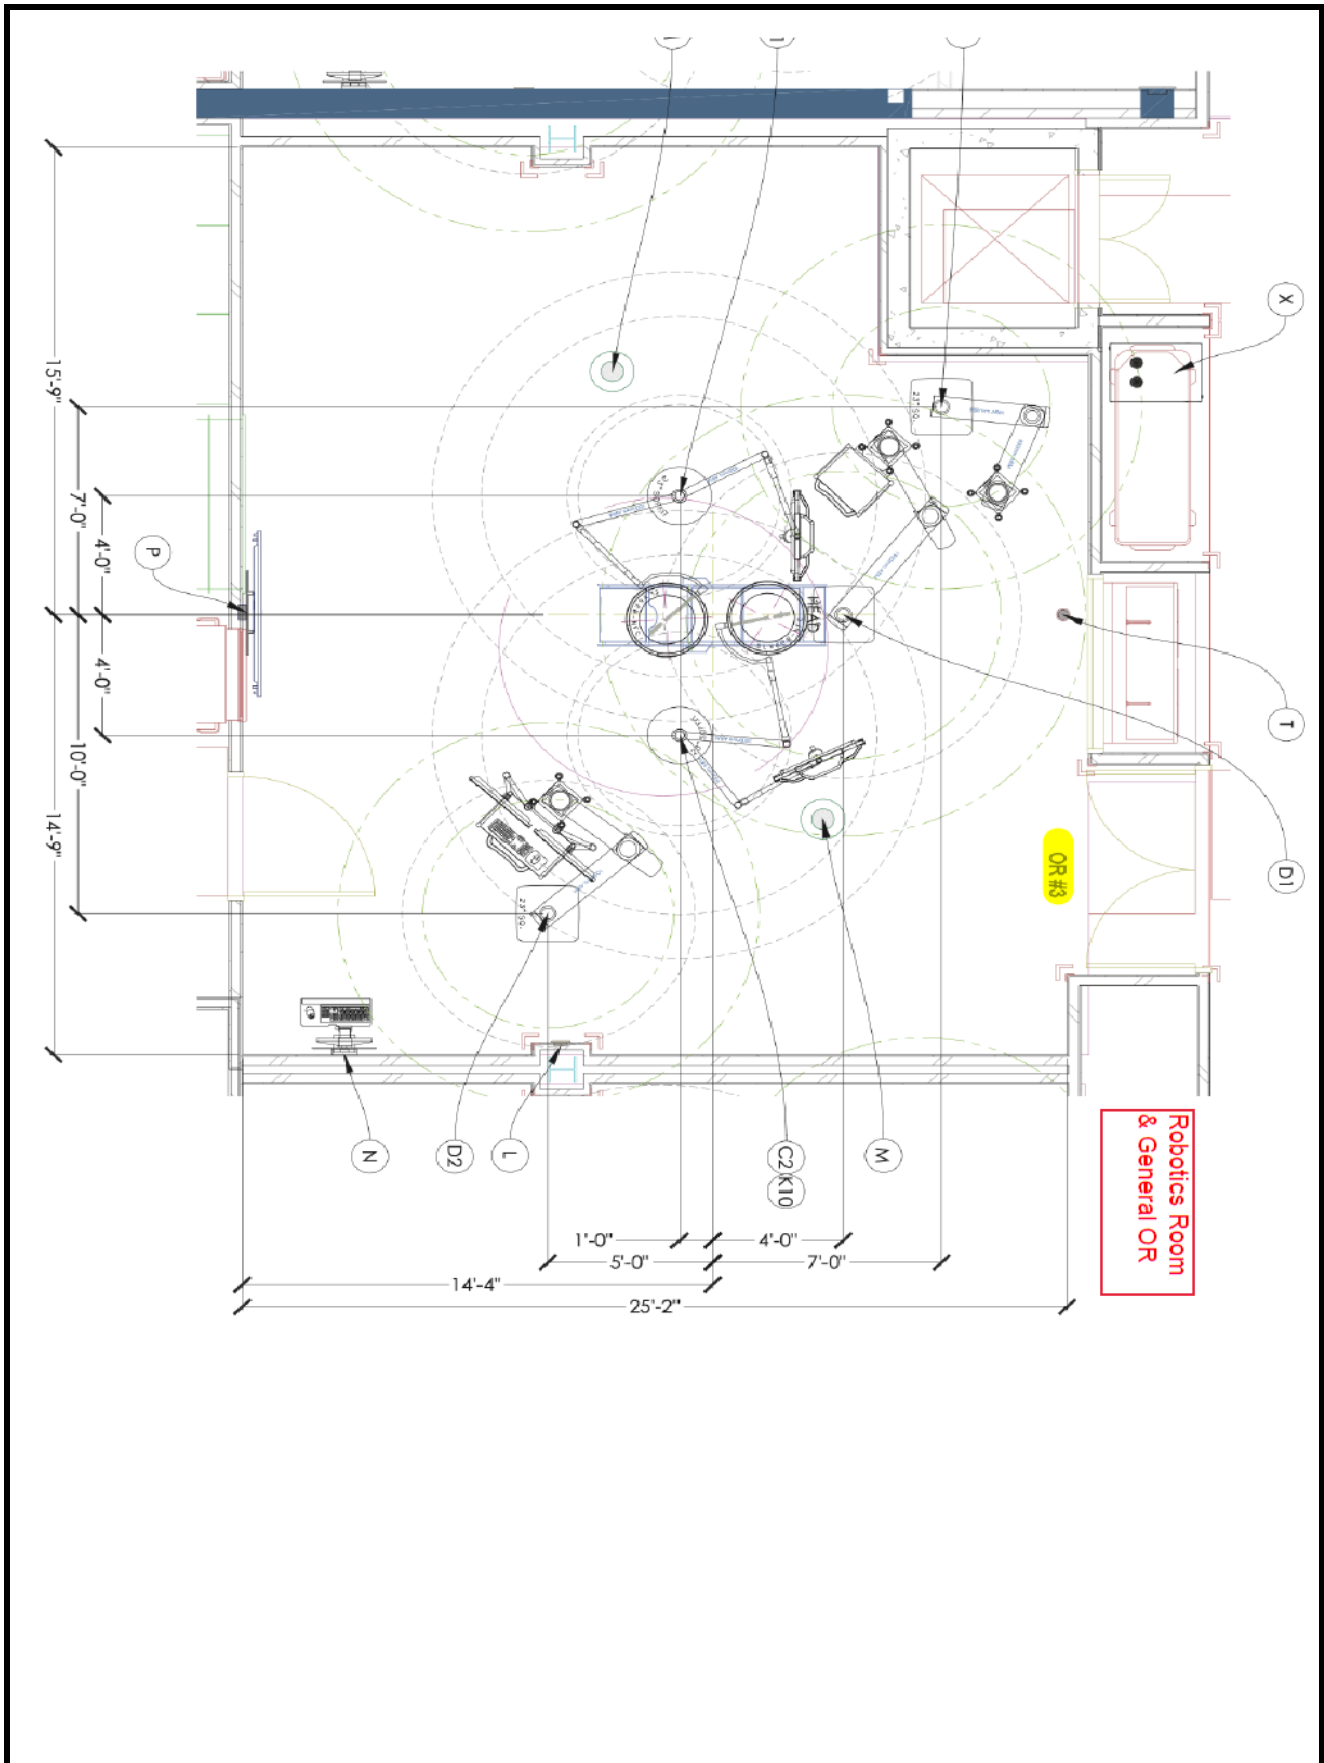



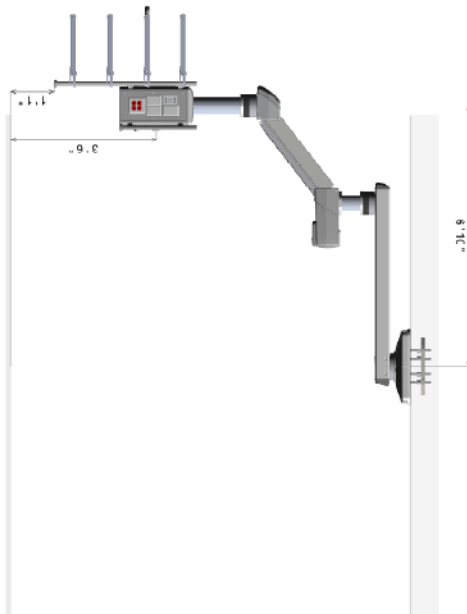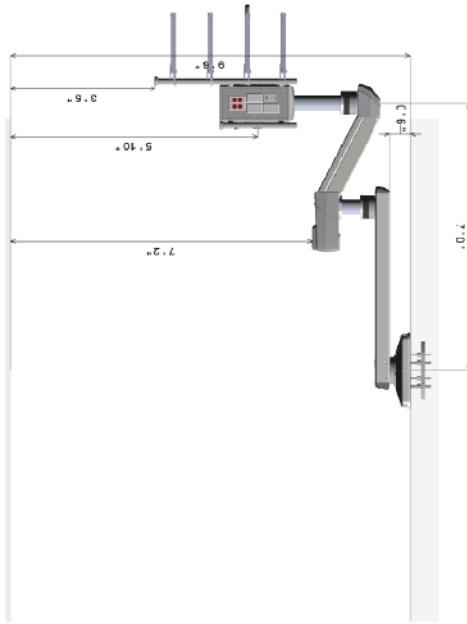

Suspension		S-Series Equipment Boom Shelves	
Brake System	Electric	Rail Type	Fairfield
Medical Rail Type	Fairfield	Shelf 1	315mm
Top Arm Length	1300mm	Shelf 2	315mm w/Controls
Bottom Arm Length	900mm	Shelf 3	315mm
Mid Tube Length	150mm	Shelf 4	315mm
Column Tube Length	400mm		
Weight Capacity (see note 4)	267 lbs		
Total Tross Used (%)	44		
Gas Hose Length (ft)	15.28		
Packaging Type	Stand Up		
Manufacturing Notes	Do Not Assemble From MFR		

I confirm the ceiling height and agree with the dimensions as drawn. I confirm the equipment configuration as shown including arm lengths, platforms, gas key styles, brand, and locations, electronic, and low voltage selections and locations. I understand that any changes made after an order is in production will result in a change order fee and a delay in shipment.			NOTES:		Stryker Communications 5000 West 10th Street Suite 1000 Omaha, NE 68106 PHONE: (402) 796-8106 FAX: (402) 796-8106 www.stryker.com Sales Representative: Brian Kippel brian.kippel@stryker.com	Project: Customer: WINNESHAK MED CTR City: DECORAH Equip ID: SPS-3 Group Name: ORS 1 Quote No.: 10179648 Quote Date: 15-Aug-2023 Credit Line #: _____ DWG Rev No.: 3 Block #: 20
CUSTOMER APPROVALS	SIGNATURE	PRINT NAME & TITLE	DATE	1		
REPRESENTATIVE				2		
FACILITY ENGINEERING				3		
				4		
				5		




## ORs 1 - Equipment Boom

Quote:10179848 Rev:4 Block#:20

stryker


FRONT

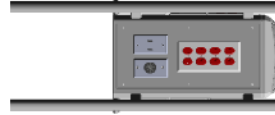

F1	20A125V Duplex (8 Outlets)
F2	Distribution B4
F3	COR Line Ends Camera

R1	CO2
R2	Bank
R3	Bank
R4	Bank
R5	20A125V Duplex (4 Outlets)

RIGHT

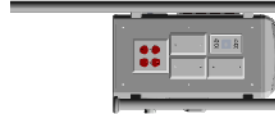


B1	COR Line 4-in-1 Plate
B2	Bank
B3	Bank
B4	Bank
B5	Inst Air Regulator

BACK



L1	20A125V Duplex (4 Outlets)
L2	Bank
L3	Bank
L4	VAC
L5	VAC

LEFT

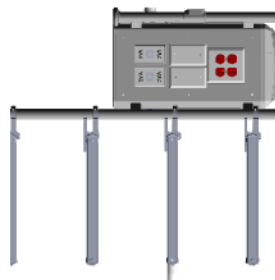

### Data Communications

Qty	Description
8	116 Blank Plate
1	116 Blank W/String
1	Pre-Instal Power
1	COR Line End Camera

### Gas Outlets

Qty	Gas Type	Key Style	Manufacturer
1	Instrument Air Regulator	D13.S	AMCO
1	Carbon Dioxide (CO2)	D13.S	Bacon Medical
2	Vacuum	Chamber	Racoon Medical

### High Voltage

Qty	Main Power Type	Isolated	Manufacturer	Source	Emergency
1	116 Blank Plate	1	116 Blank W/String	1	116 Blank W/String
1	116 Blank Plate	1	116 Blank W/String	1	116 Blank W/String
1	116 Blank Plate	1	116 Blank W/String	1	116 Blank W/String
1	116 Blank Plate	1	116 Blank W/String	1	116 Blank W/String

### Circuits

Qty	Description
4	Total 15A/20A Circuits
1	Circuit for Motor and Brake
1	Multi-Functional Rail (M-FR)
1	100mm
1	53mm
1	Rear Only

<p>I confirm the ceiling height and agree with the dimensions as shown. I confirm the equipment configuration as shown including arm weight, patient, gas key style, view, and location, electronic, and bay voltage sections and locations. I understand that any changes made after an order is in production will result in a change order fee and a delay in shipment.</p>		<p>NOTES:</p> <p>1 For weights, moments, and installation details, please refer to the Stryker Pre-Installation manual.</p> <p>2 It is the customer's responsibility to provide the support structure to meet requirements listed in the Pre-Install Manual.</p> <p>3 Customer is responsible for reviewing and approving Gas Key Style and accessories, based on weights moments listed in S-SERIES Pre-Install Manual.</p> <p>4 Bottom of Stryker mounting plate must be installed at 30" above finished ceiling plane. All vertical column dimensions shown in drawing are dependent on this requirement.</p>	
CUSTOMER APPROVALS	SIGNATURE	PRINT NAME & TITLE	DATE
CLINICAL REPRESENTATIVE			
FACILITY ENGINEERING			

Stryker Communications  
571 Seward Blvd.  
Riverside, CA 92508  
Phone: (951) 789-1100  
www.stryker.com

Project: WINNIESHEK MED CTR  
Customer: WINNIESHEK MED CTR  
City: Decorah, IA  
State: Iowa  
Zip: 52001  
Quote No.: 10179848  
Quote Date: 10/17/2023  
Quote Rev: 4  
Quote Line #: 1  
Quote Rev: 3  
Quote Date: 10/17/2023  
Quote Rev: 20

# WinnMed

Room: ORs 1 3 4

Equipment Boom



## S-Series Standard Equipment Management System

Introducing a new standard in equipment management. With a completely redesigned user interface and a compact, fully customizable system, it has never been easier to manage your services and maneuver your equipment.

PART #	DESCRIPTION	QTY	LIST PRICE	EXT LIST PRICE
SPS-3	S-SERIES, STANDARD POWERED, 3 ROW, 2 A	3		
<div> <div> <u>Mounting Details</u>            Mounting Plate Single Common Plate            Ceiling Cover Standalone            Brake System Electric         </div> <div> <u>Shelves</u>            Shelves 4            Shelf Rail Type Fairfield            Shelf 1 515mm            Shelf 2 515mm w/Controls            Shelf 3 515mm            Shelf 4 515mm         </div> <div> <u>High Voltage Services</u>            20A/125V Duplex (8 Outlets) 1            20A/125V Duplex (4 Outlets) 2    <u>Low Voltage Services</u>            Blank Plate 8            Distribution Bd Plate 1            COR Lite 4-in-1 Plate 1            COR Lite Endo Camera Plate 1         </div> <div> <u>Additional Cables</u> </div> <div> <u>Gas Services</u>            Gas Manufacturer Beacon Medaes            Gas Fitting Type Chemetron            CO2 Gas 1            Vac Gas 2            Instrument Air Gas 1         </div> </div>				
<div> <u>MFR Configuration</u>            Front MFR Length 1000mm            Rear MFR Length 531mm            MFR Controls Rear Only         </div>				
PART #	DESCRIPTION	QTY	LIST PRICE	EXT LIST PRICE
P40074	ASM, HANDLE AND SHELF WITH FAIRFIELD R	3		
P36143	ASM, SHELF MOUNT HDW	12		
P40237	ASM, SHELF WITH FAIRFIELD RAILS, 515,	9		
P34414	KIT, FOOT PEDAL STORAGE DRAWER, ATLAS	3		
Configuration Total:				

# WinnMed

WinnMed

Issue Date:

3/6/2024

Expansion and Renovation

Decorah, IA 52101

Furniture Specifications

CONTACT:

Ben Stevens - CFO

PHONE NUMBER:

563-387-3109

ITEM NUMBER:	33
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ITEM NAME:	OR 4 Ceiling Mounted Equipment Boom		
------------	-------------------------------------	--	--

ROOM NUMBER:		QUANTITY:	
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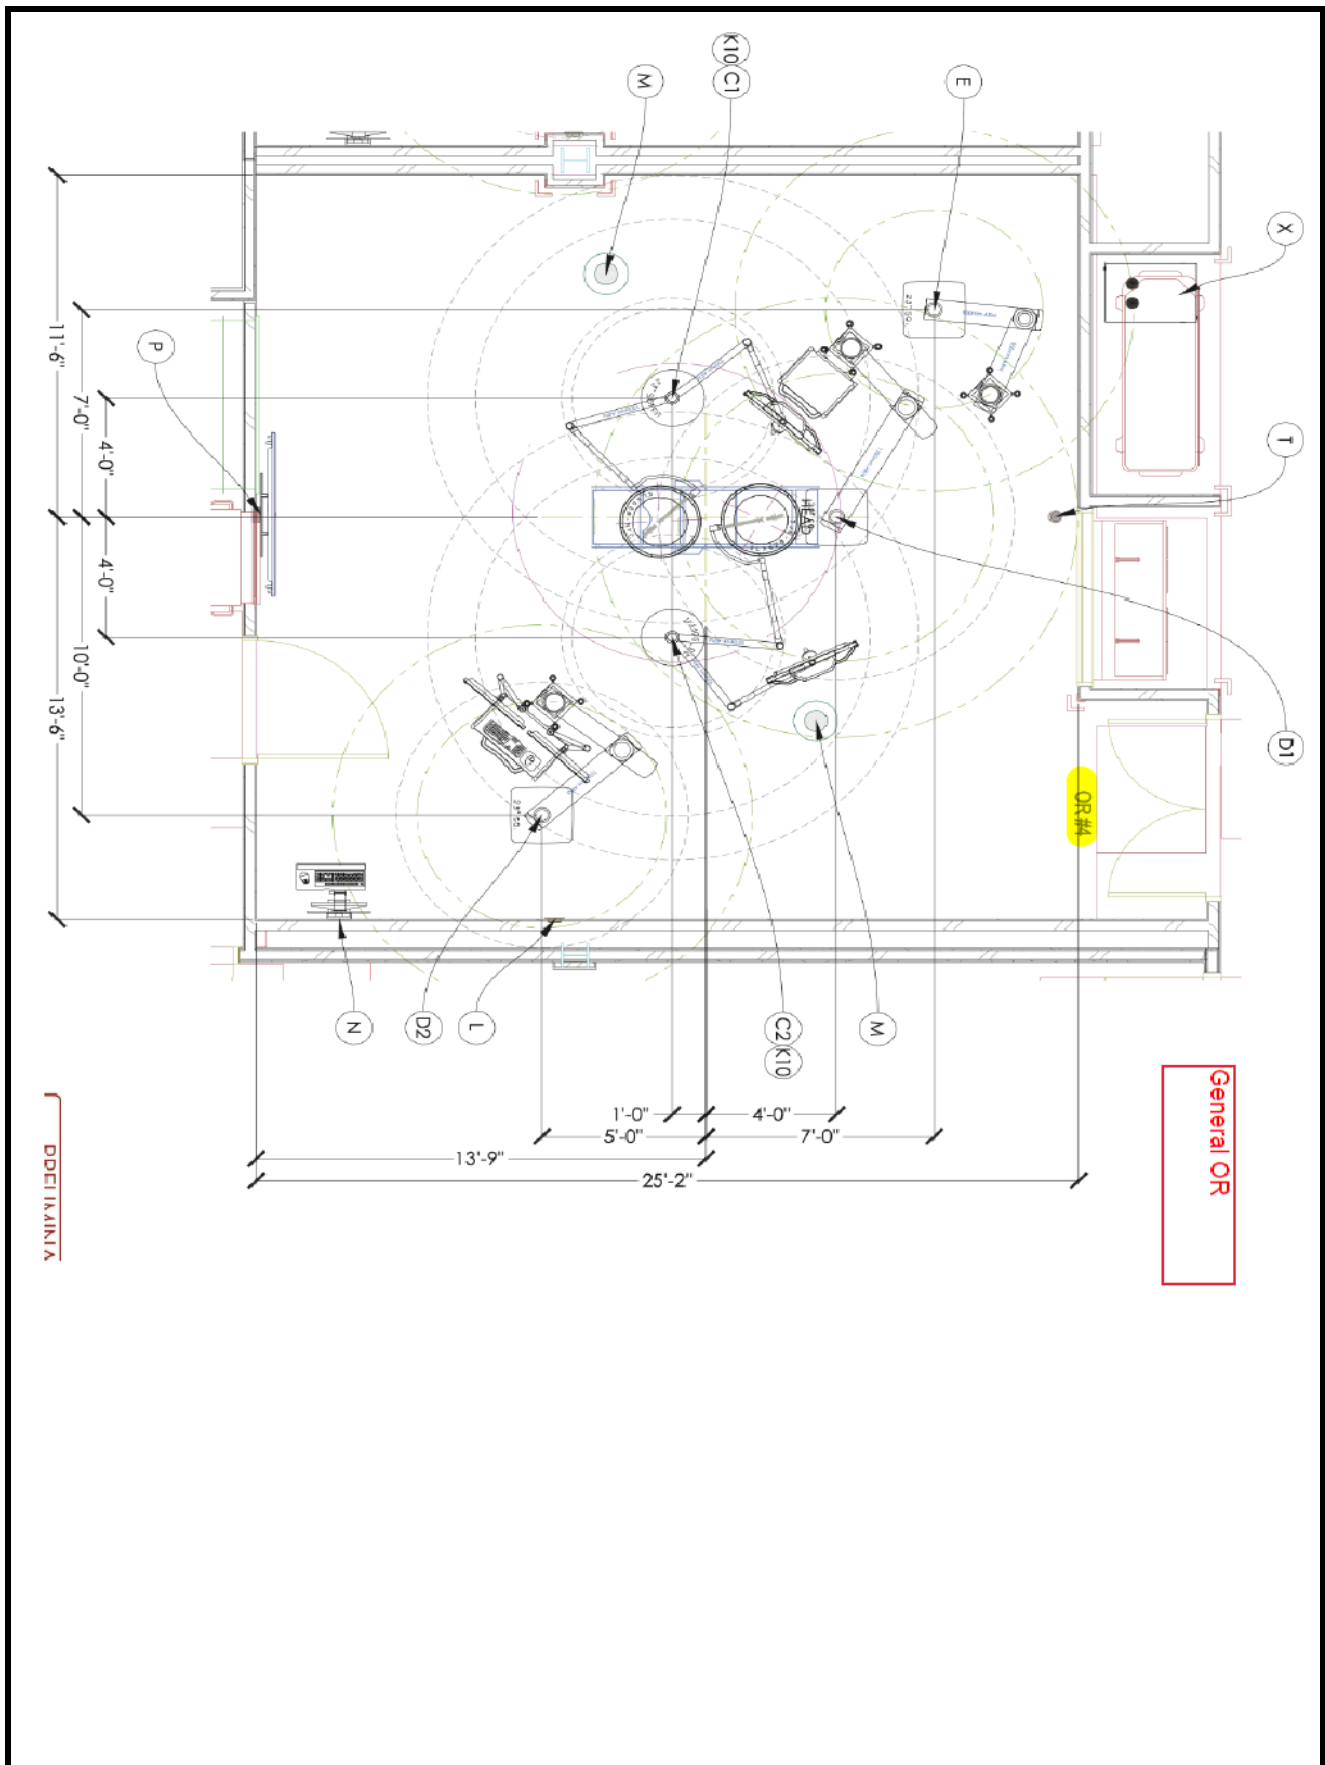
## SPECIFICATION INFORMATION



MANUFACTURER: Stryker  
MODEL #: SPS-3-C  
DIMENSIONS: OR 4  
DESCRIPTION: Ceiling Mounted Equipment Management System; 3 Row, 4 Shelves; Foot Pedal Storage Drawer

## FURNITURE & EQUIPMENT IMAGE



# WinnMed



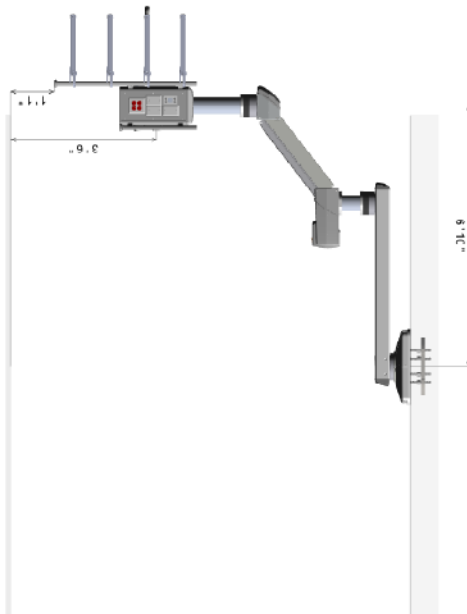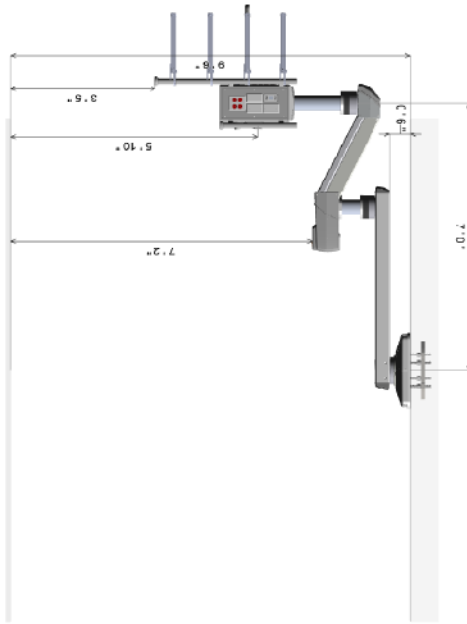


Suspension		S-Series Equipment Boom Shelves	
Brake System	Electric	Rail Type	Fairfield
Medical Rail Type	Fairfield	Shelf 1	315mm
Top Arm Length	1300mm	Shelf 2	315mm w/Controls
Bottom Arm Length	900mm	Shelf 3	315mm
Mid Tube Length	150mm	Shelf 4	315mm
Column Tube Length	400mm		
Weight Capacity (see note 4)	267 lbs		
Total Tross Used (%)	44		
Gas Hose Length (ft)	15.28		
Packaging Type	Stand Up		
Manufacturing Notes	Do Not Assemble From MFR		

I confirm the ceiling height and agree with the dimensions as drawn. I confirm the equipment configuration as shown including arm lengths, platforms, gas key styles, brand, and locations, electronic, and low voltage sections and locations. I understand that any changes made after an order is in production will result in a change order fee and a delay in shipment.			NOTES:		<b>Stryker Communications</b> Stryker Medical, TX 75038 PHONE: (877) 789-8106 FAX: (409) 342-9064 www.stryker.com  Sales Representative : Brian Kippel brian.kippel@stryker.com  Project: Customer: WINNESHAK MED CTR City: DEORAH State: Iowa Equip ID: SPS-3 Group Name: ORS 1 Quote No.: 10179648 Quote Rev No.: 4 Quote Date: 15-Aug-2023 QTY: 1 Credit Line #: Block #: 20 DWG Rev No.: 3 DWG No.: 10179648S008
CUSTOMER APPROVALS	SIGNATURE	PRINT NAME & TITLE	DATE	1	
CLINICAL REPRESENTATIVE				2	
FACILITY ENGINEERING				3	
				4	

## ORs 1 - Equipment Boom

Quote:10179848 Rev:4 Block#:20


FRONT

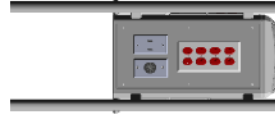

F1	20A125V Duplex (8 Outlets)
F2	Distribution B4
F3	COR Line Endo Camera


R1	CO2
R2	Bank
R3	Bank
R4	Bank
R5	20A125V Duplex (4 Outlets)

RIGHT

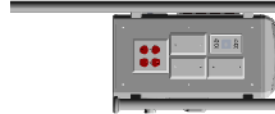


B1	COR Line 4-in-1 Plate
B2	Bank
B3	Bank
B4	Bank
B5	Instal Air Regulator

BACK

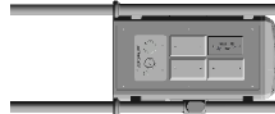

L1	20A125V Duplex (4 Outlets)
L2	Bank
L3	Bank
L4	VAC
L5	VAC

LEFT

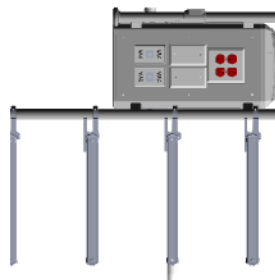

### Data Communications

Qty	Description
8	116 Blank Plate
1	116 Blank W/String
1	Pre-Instal Power
1	COR Line Endo Camera

### Gas Outlets

Qty	Gas Type	Key Style	Manufacturer
1	Instrument Air Regulator	D13.S	AMCO
1	Carbon Dioxide (CO2)	D13.S	Bacon Medical
2	Vacuum	Chamber	Racoon Medical

### High Voltage

Qty	Main Power Type	Isolated	Manufacturer	Source	Emergency
1	116 Blank Plate	1	116 Blank Plate	116 Blank Plate	116 Blank Plate
1	116 Blank W/String	1	116 Blank W/String	116 Blank W/String	116 Blank W/String
1	Pre-Instal Power	1	Pre-Instal Power	Pre-Instal Power	Pre-Instal Power
1	COR Line Endo Camera	1	COR Line Endo Camera	COR Line Endo Camera	COR Line Endo Camera

### Circuits

Qty	Description
4	Total 15A/20A Circuits
1	Circuit for Motor and Brake

### Multi-Functional Rail (M-FR)

Front	100mm
Back	53mm
Control	Rail Only

I confirm the ceiling height and agree with the dimensions as shown. I confirm the equipment configuration as shown including arm weight, patient, gas key style, view, and location, electronic, and bay weight sections and location. I understand that any changes made after this order is in production will result in a change order fee and a delay in shipment.

CUSTOMER APPROVALS	SIGNATURE	PRINT NAME & TITLE	DATE
CLINICAL REPRESENTATIVE			
FACILITY ENGINEERING			

### NOTES:

- For weights, moments, and installation details, please refer to the Stryker Pre-Installation manual.
- It is the customer's responsibility to provide the support structure to meet requirements listed in the Pre-Instal Manual.
- Customer is responsible for reviewing and approving Gas Key Style and Moment.
- Total weight capacity available for all Stryker and customer supplied accessories, based on weights moments listed in S-SERIES Pre-Instal Manual.
- Bottom of Stryker mounting plate must be installed at 30" above finished ceiling plane. All vertical column dimensions shown in drawing are dependent on this requirement.

Stryker Communications

571 Seward Blvd.  
Riverside, CA 92508  
Phone: (951) 789-1100  
www.stryker.com

Sales Representative:

Brian Mihal  
brian.mihal@stryker.com

Project: Customer WINNIESHEK MED CTR

City: Decorah, IA State: Iowa

Equip ID: 575-3 Group Name: ORS 1

Quote No.: 10179848 Quote Rev No.: 4

Quote Date: 15-Aug-2023 QTY: 1

Quote Line #: DWS Rev No.: 3 Block #: 20

DWS No.: 10179848-3008

# WinnMed

Room: ORs 1 3 4

Equipment Boom



## S-Series Standard Equipment Management System

Introducing a new standard in equipment management. With a completely redesigned user interface and a compact, fully customizable system, it has never been easier to manage your services and maneuver your equipment.

PART #	DESCRIPTION	QTY	LIST PRICE	EXT LIST PRICE
SPS-3	S-SERIES, STANDARD POWERED, 3 ROW, 2 A	3		
<div> <div> <u>Mounting Details</u>  MOUNTING PLATE Single Common Plate  CEILING COVER Standalone  BRAKE SYSTEM Electric    <u>MFR Configuration</u>  FRONT MFR LENGTH 1000mm  REAR MFR LENGTH 531mm  MFR CONTROLS Rear Only </div> <div> <u>Shelves</u>  SHelves 4  SHelf Rail Type Fairfield  SHelf 1 515mm  SHelf 2 515mm w/Controls  SHelf 3 515mm  SHelf 4 515mm </div> <div> <u>High Voltage Services</u>  20A/125V Duplex (8 Outlets) 1  20A/125V Duplex (4 Outlets) 2    <u>Low Voltage Services</u>  Blank Plate 8  Distribution Bd Plate 1  COR Lite 4-in-1 Plate 1  COR Lite Endo Camera Plate 1 </div> <div> <u>Additional Cables</u> </div> <div> <u>Gas Services</u>  Gas Manufacturer Beacon Medaes  Gas Fitting Type Chemetron  CO2 Gas 1  Vac Gas 2  Instrument Air Gas 1 </div> </div>				
PART #	DESCRIPTION	QTY	LIST PRICE	EXT LIST PRICE
P40074	ASM, HANDLE AND SHELF WITH FAIRFIELD R	3		
P36143	ASM, SHELF MOUNT HDW	12		
P40237	ASM, SHELF WITH FAIRFIELD RAILS, 515,	9		
P34414	KIT, FOOT PEDAL STORAGE DRAWER, ATLAS	3		
Configuration Total:				

# WinnMed

WinnMed

Issue Date:

3/6/2024

Expansion and Renovation

Decorah, IA 52101

Furniture Specifications

CONTACT:

Ben Stevens - CFO

PHONE NUMBER:

563-387-3109

ITEM NUMBER:	34
--------------	----

ITEM NAME:	OR 1 Ceiling Mounted Nurse Station		
ROOM NUMBER:		QUANTITY:	

## SPECIFICATION INFORMATION


MANUFACTURER: Stryker  
MODEL #: SPS-2  
DIMENSIONS: OR 1  
DESCRIPTION: Ceiling Mounted Nurse Station; 1 Shelf



## FURNITURE & EQUIPMENT IMAGE





# WinnMed

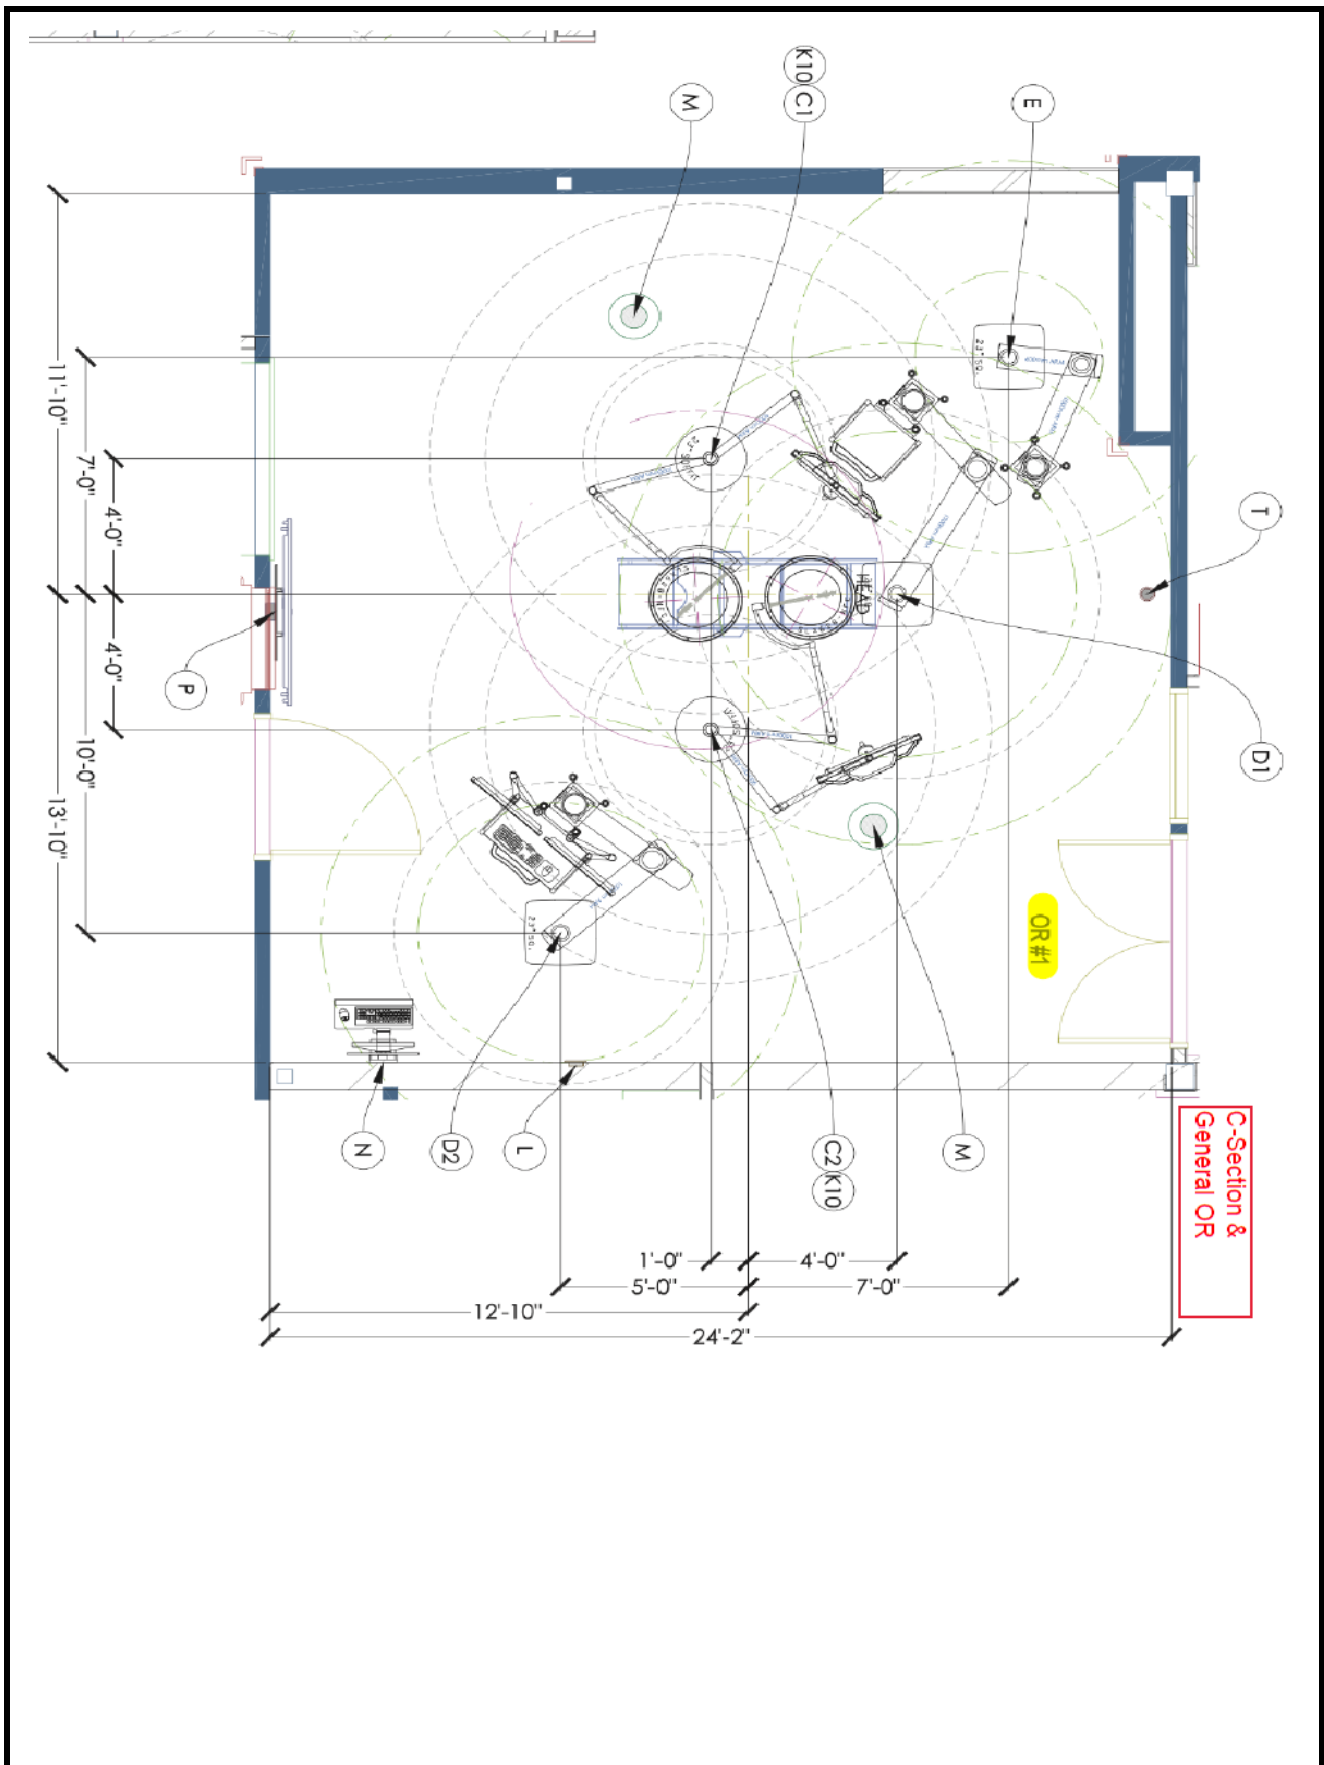

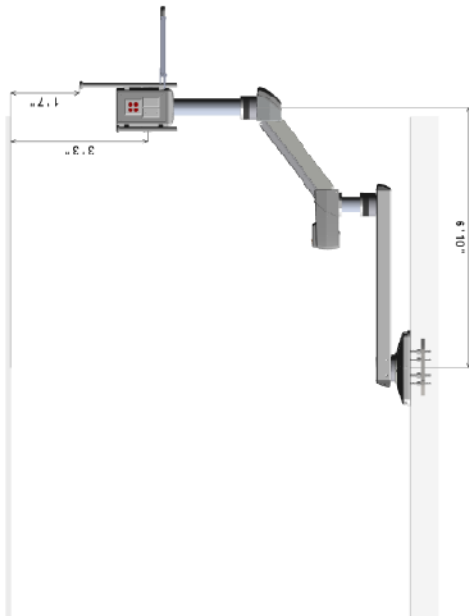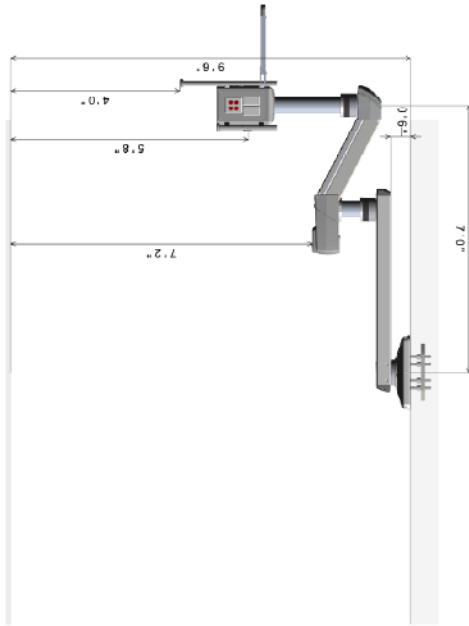

Suspension		S-Series Equipment Boom Stakes	
Brake System	Electric	Rail Type	Fairfield
Medical Rail Type	Painted	Shaft 1	750mm w/Conicos
Top Arm Length	1300mm	Shaft 2	None
Bottom Arm Length	900mm	Shaft 3	None
Mid Tube Length	150mm	Shaft 4	None
Column Tube Length	550mm		
Weight Capacity (see note 4)	279 lbs.		
Tied Thrust (lbs) (%)	29		
Gas Hose Length (ft)	15.37		
Packaging Type	Stand Up		
Manufacturing Notes	Do Not Assemble From MFR		

I confirm the ceiling height and agrees with the dimensions as drawn. I confirm the equipment configuration as shown including arm lengths, platform, gas key styles, brand, and locations, electronic, and low voltage sections and locations. I understand that any changes made after an order is in production will result in a change order fee and a delay in shipment.	
CUSTOMER APPROVALS	SIGNATURE
CLINICAL REPRESENTATIVE	DATE
ENGINEERING	

- NOTES:
- For weights, moments, and installation details, please refer to the Stryker Pre-Installation manual.
  - It is the owner's responsibility to provide the support structure to meet requirements listed in the Pre-Install Manual.
  - Customer is responsible for reviewing and approving Gas Key Style and Tied weight capacity available for all Stryker and customer supplied accessories, based on weights moments listed in S-SERIES Pre-Install Manual.
  - Bottom of Stryker mounting plate must be installed at 3.0" above finished ceiling plane. All vertical boom dimensions shown in drawing are dependent on this requirement.

Stryker Communications 571 Sierra Blvd Flower Mound, TX 75023 PHONE: 817/796-8100 FAX: 817/796-8100 Email: sales@stryker.com Brian.Hippen@stryker.com	
Project:	Customer: WINNESHEN MED CTR
Equip ID: JECOR4H	State: Iowa
Equip ID: SPS-2	
Equip Name: OR 1	
Quote No.: 10179648	Quote Rev No.: 4
Quote Date: 15-Aug-2023	QTY: 1
Order Line #:	
DWG Rev No.: 3	Block #: 19
DWG No.: 10179648-5007	

CR 1 - Nursing Boom  
Quote:10179648 Rev:4 Block#:19

stryker  
9/6"

FRONT

RIGHT

BACK

LEFT

F1	Distribution Bd
F2	3rd Party Data
F3	Blank Plate
F4	Blank Plate
F5	Blank Plate
F6	Blank Plate
F7	Blank Plate
F8	Blank Plate
F9	Blank Plate
F10	Blank Plate
F11	Blank Plate
F12	Blank Plate
F13	Blank Plate
F14	Blank Plate
F15	Blank Plate
F16	Blank Plate
F17	Blank Plate
F18	Blank Plate
F19	Blank Plate
F20	Blank Plate
F21	Blank Plate
F22	Blank Plate
F23	Blank Plate
F24	Blank Plate
F25	Blank Plate
F26	Blank Plate
F27	Blank Plate
F28	Blank Plate
F29	Blank Plate
F30	Blank Plate
F31	Blank Plate
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F98	Blank Plate
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R1	Blank
R2	Blank
R3	Blank
R4	Blank
R5	Blank
R6	Blank
R7	Blank
R8	Blank
R9	Blank
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R14	Blank
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R50	Blank
R51	Blank
R52	Blank
R53	Blank
R54	Blank
R55	Blank
R56	Blank
R57	Blank
R58	Blank
R59	Blank
R60	Blank
R61	Blank
R62	Blank
R63	Blank
R64	Blank
R65	Blank
R66	Blank
R67	Blank
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R69	Blank
R70	Blank
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R93	Blank
R94	Blank
R95	Blank
R96	Blank
R97	Blank
R98	Blank
R99	Blank
R100	Blank

B1	Blank
B2	Blank
B3	Blank
B4	Blank
B5	Blank
B6	Blank
B7	Blank
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B91	Blank
B92	Blank
B93	Blank
B94	Blank
B95	Blank
B96	Blank
B97	Blank
B98	Blank
B99	Blank
B100	Blank

L1	Blank
L2	Blank
L3	Blank
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L88	Blank
L89	Blank
L90	Blank
L91	Blank
L92	Blank
L93	Blank
L94	Blank
L95	Blank
L96	Blank
L97	Blank
L98	Blank
L99	Blank
L100	Blank

Qty	Description
5	1/8 Blank Plate
1	1/8 Blank w/Strap
1	Distribution Board

Qty	Gas Type	Key Style	Manufacturer
-----	----------	-----------	--------------

Main Power Type	Isolated
Manufacturer	Emergency
Loc.	Circuit Ref #
R1	1
R2	2
R3	3
R4	4
R5	5
R6	6
R7	7
R8	8
R9	9
R10	10
R11	11
R12	12
R13	13
R14	14
R15	15
R16	16
R17	17
R18	18
R19	19
R20	20
R21	21
R22	22
R23	23
R24	24
R25	25
R26	26
R27	27
R28	28
R29	29
R30	30
R31	31
R32	32
R33	33
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R35	35
R36	36
R37	37
R38	38
R39	39
R40	40
R41	41
R42	42
R43	43
R44	44
R45	45
R46	46
R47	47
R48	48
R49	49
R50	50
R51	51
R52	52
R53	53
R54	54
R55	55
R56	56
R57	57
R58	58
R59	59
R60	60
R61	61
R62	62
R63	63
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R68	68
R69	69
R70	70
R71	71
R72	72
R73	73
R74	74
R75	75
R76	76
R77	77
R78	78
R79	79
R80	80
R81	81
R82	82
R83	83
R84	84
R85	85
R86	86
R87	87
R88	88
R89	89
R90	90
R91	91
R92	92
R93	93
R94	94
R95	95
R96	96
R97	97
R98	98
R99	99
R100	100

Qty	Description
4	Total 15A/20A Circuits
1	Circuit for Motor and Brake

Qty	Description
1	Multi-Functional Rail (MFR)
1	Front
1	Back
1	Control

I confirm the ceiling height and agree with the dimensions as drawn. I confirm the equipment configuration as shown including the location of the equipment, the dimensions of the equipment, and the dimensions of the ceiling. I understand that any changes made after a work order is in production will result in a change order fee and a delay in shipment.		NOTES:	
1	For weights, moments, and installation details, please refer to the Stryker Pre-installation manual.	Stryker Communications	
2	It is the owner's responsibility to provide the support structure to meet the requirements listed in the Pre-install Manual.	7715 Shuman Blvd. Des Moines, IA 50319 Phone: 515.281.7400 Fax: 515.281.7400 www.stryker.com	
3	Customer is responsible for reviewing and approving Gas Key Style and Moment.	Project:	
4	Total weight capacity available for all Stryker and customer supplied accessories based on weights moments listed in S-SERIES Pre-install Manual.	Customer: WINNESHED MED CTR	
5	Bottom of Stryker mounting plate must be installed at 30" above finished ceiling plane. All vertical boom dimensions shown in drawing are dependent on this requirement.	Equip ID: SPS-2	
		Group Name: CR 1	
		Quote No.: 10179648	
		Quote Date: 15-Aug-2023	
		Order Line #:	
		Quote Ref No.: 3	
		Block #: 19	
		DWG No.: 10179648-007	

# WinnMed

Room: ORs 1 3 4

Nursing Boom

PART #	DESCRIPTION	QTY	LIST PRICE	EXT LIST PRICE
SPS-2	S-SERIES, STANDARD POWERED, 2 ROW, 2 A	3		
<div> <div> <b>Mounting Details</b>            Mounting Plate Single Common Plate            Ceiling Cover Standalone            Brake System Electric  <b>MFR Configuration</b>            Front MFR Length 676mm            Rear MFR Length 406mm            MFR Controls Rear Only         </div> <div> <b>Shelves</b>            Shelves 1            Shelf Rail Type Fairfield            Shelf 1 750mm w/Controls         </div> <div> <b>High Voltage Services</b>            20A/125V Duplex (4 Outlets) 4  <b>Low Voltage Services</b>            Blank Plate 6            3rd Party Data Plate 1G Plate 1            Distribution Bd Plate 1         </div> <div> <b>Additional Cables</b> </div> <div> <b>Gas Services</b>            Gas Manufacturer Beacon Medical            Gas Fitting Type Chemtron         </div> </div>				
PART #	DESCRIPTION	QTY	LIST PRICE	EXT LIST PRICE
P40075	ASM. HANDLE AND SHELF WITH FAIRFIELD R	3		
P36143	ASM. SHELF MOUNT HDW	3		
Configuration Total:				

# WinnMed

WinnMed

Issue Date:

3/6/2024

Expansion and Renovation

Decorah, IA 52101

Furniture Specifications

CONTACT:

Ben Stevens - CFO

PHONE NUMBER:

563-387-3109

ITEM NUMBER:	35
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ITEM NAME:	OR 3 Ceiling Mounted Nurse Station		
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ROOM NUMBER:		QUANTITY:	
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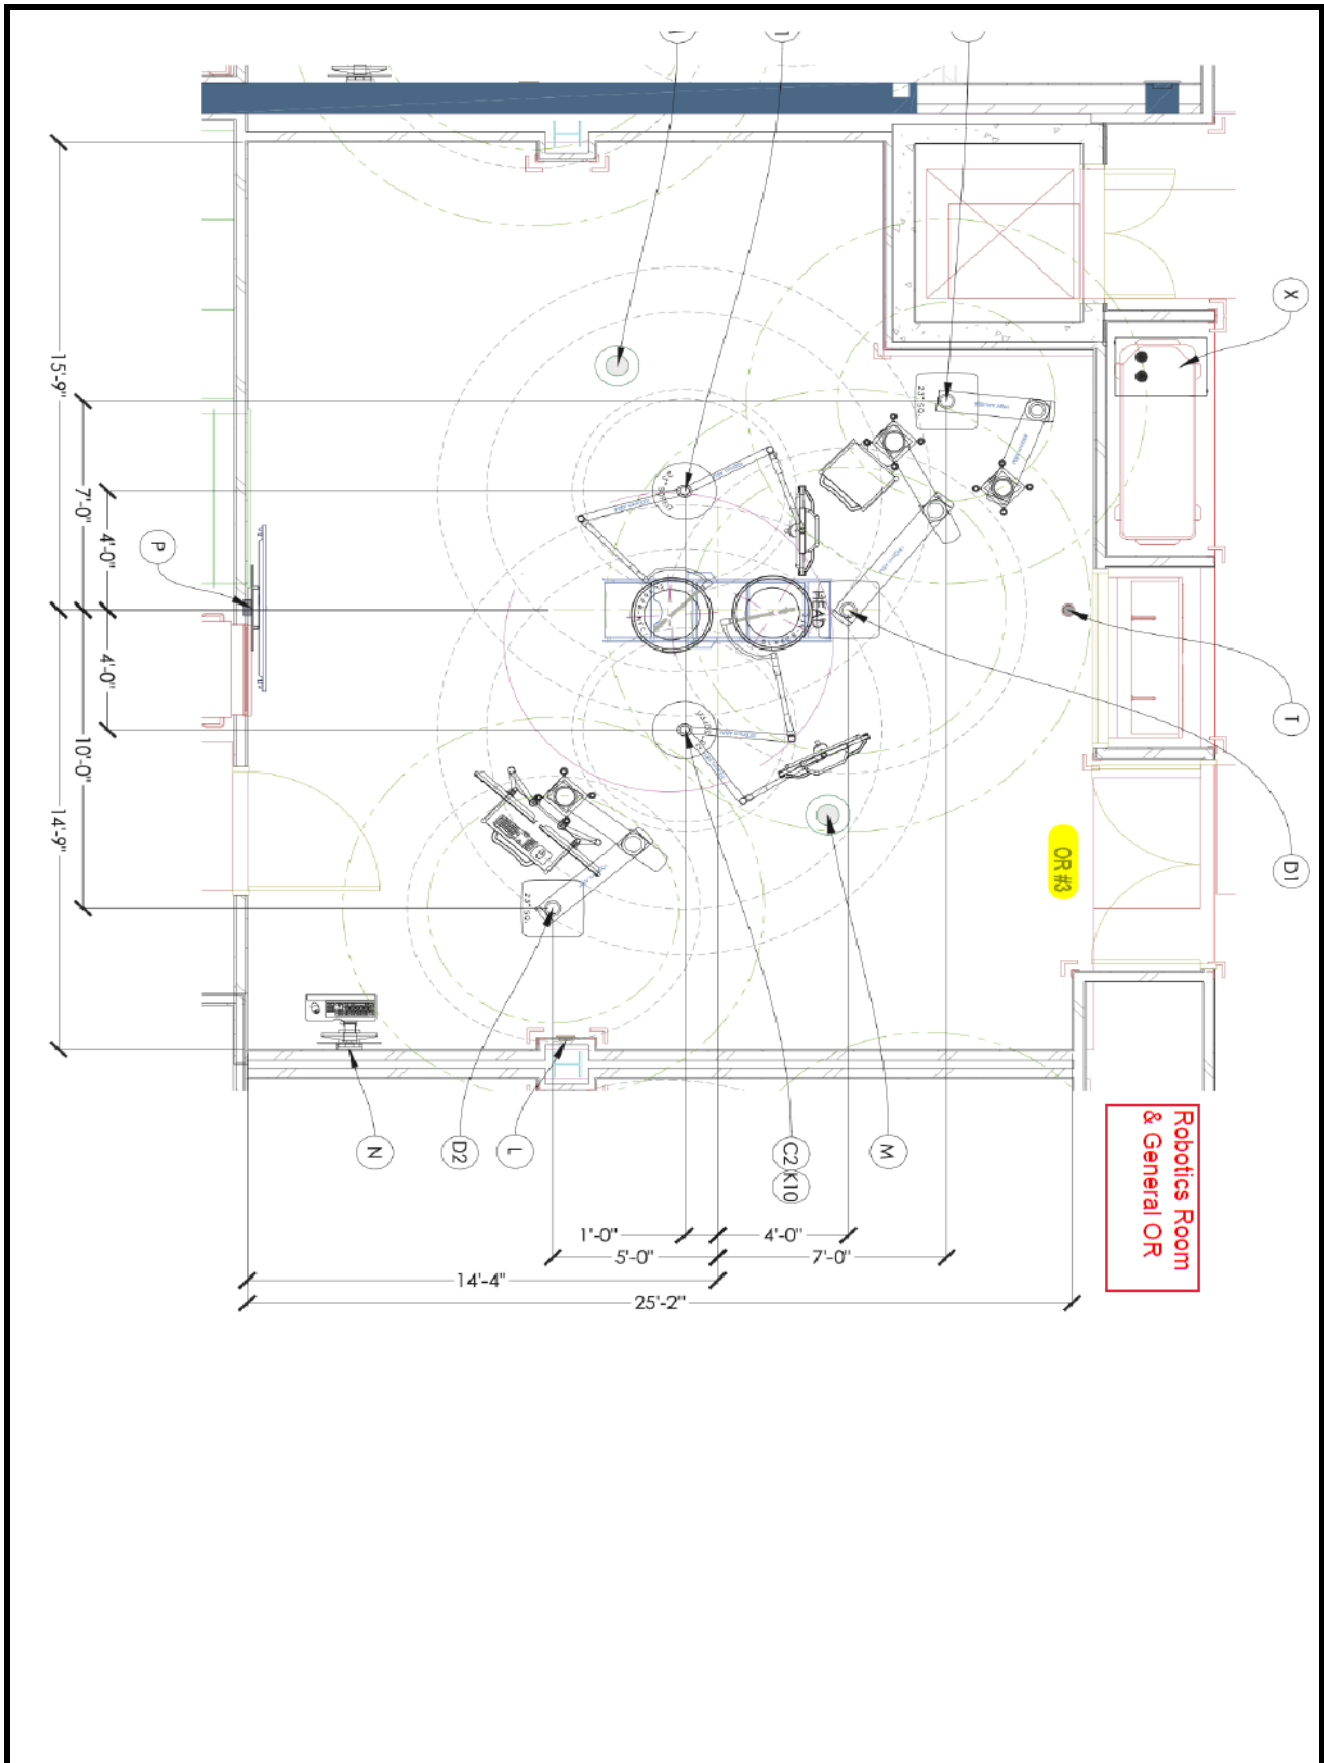
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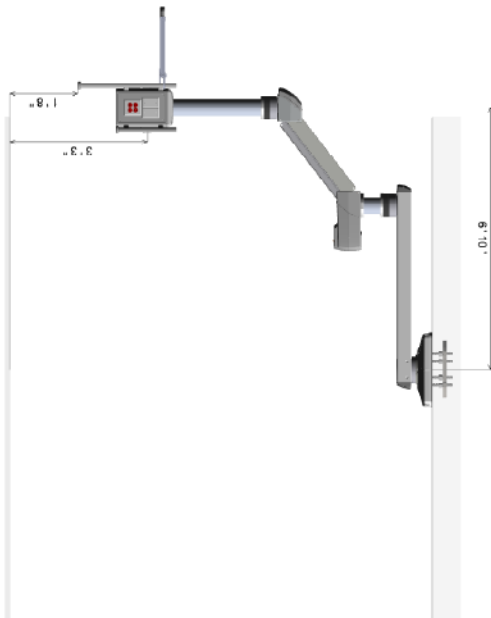
MANUFACTURER: Stryker  
MODEL #: SPS-2  
DIMENSIONS: OR 3  
DESCRIPTION: Ceiling Mounted Nurse Station; 1 Shelf

## FURNITURE & EQUIPMENT IMAGE



# WinnMed






S-Series Equipment Boom Shelves	
Rail Type	Fairlead
Shelf1	750mm w/Controls
Shelf2	None
Shelf3	None
Shelf4	None

CUSTOMER APPROVALS	I confirm the ceiling height and agree with the dimensions shown. I confirm the mounting configuration as shown including arm lengths, positions, gas key, styles, brand, and location, electronic, and low voltage selections and options. I understand that any changes made after an order is in production will result in a change order fee and a delay in shipment.	
	SIGNATURE	DATE
	PRINT NAME & TITLE	
QUINCY REPRESENTATIVE		
FACILITY ENGINEERING		
NOTES:		Styker Communications 571 Stevens Ave. Riverwood, TN 37028 Phone: 615.776.4105 FAX: 660.793.2469 <a href="http://www.styker.com">www.styker.com</a>
1. Fit, weight, moment, and installation details, please refer to the Styker Pre-Installation Manual.		
2. It is the owner's responsibility to provide the support structure to meet the requirements listed in the Pre-Install Manual.		
3. Customer is responsible for reviewing and approving Gas Key Style and Manufacturer.		
4. Total weight capacity available for all Styker and features applied. Moment capacity, based on weight moments listed in the STYKER Pre-Install Manual.		
5. Bottom of Styker mounting plate must be installed at 3' or above finished ceiling plane. All vertical boom dimensions shown in drawing are dependent on the requirement.		
Sales Representative : Brian J. Smith <a href="mailto:brian.smith@styker.com">brian.smith@styker.com</a>		Project: Customer: MINNESOTA MED CTR CTR, DEODHAY Equip ID: SP52 Group Name: ORE 3.4 Quote No.: 10175648 Quote Date: 15-Mar-2023 Order Line #: 1 DWG Rev No.: 1 DWG No.: 10175648-5004
		State: Iowa Block # 9


DWG No.: 10179648\$004

FRONT

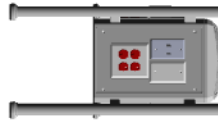


R1	Blank
R2	Blank
R3	200V125V Duplex (4 Outlets)

RIGHT

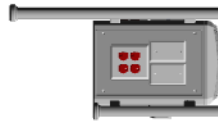

E1	Blank
E2	Blank
E3	200V125V Duplex (4 Outlets)

BACK

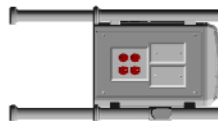

L1	Blank
L2	Blank
L3	200V125V Duplex (4 Outlets)

LEFT



## Data Communications

Qty	Description
6	IG Bank Panel
1	IG Bank Wiring
1	Distribution Board

## Gas Outlets

Qty	Gas Type	Key Style	Manufacturer
6	IG Bank Panel		
1	IG Bank Wiring		
1	Distribution Board		

## High Voltage

Loc.	Circuit Ref #	Manufacturer	Location	Emergency	Color	Outlet Box	Description
F3	1				Red	A	200V125V Duplex (4 Outlets)
R3	2				Red	A	200V125V Duplex (4 Outlets)
B3	3				Red	A	200V125V Duplex (4 Outlets)
L3	4				Red	A	200V125V Duplex (4 Outlets)

## Circuits

Qty	Description
4	Total 15A/20A Circuits
1	Circuit for Motor and Brake

## Multi-Functional Rail (WFR)

Front	675mm
Back	450mm
Center	Rear Only

I confirm the ceiling height and agree with the dimensions as drawn. I confirm the equipment configuration as shown including arm lengths, platforms, gas key styles, blank, and locations, electronic, and low voltage selections and locations. I understand that any changes made after an order is in production will result in a change order fee and a delay in shipment.

CUSTOMER APPROVALS

SIGNATURE

PRINT NAME & TITLE

DATE

CLINICAL REPRESENTATIVE

FACILITY PURCHASER NAME

Stryker Communications

571 Seward Blvd.  
Pawnee, ND 58454

PHONE: (701) 796-8100  
FAX: (701) 796-8100

www.stryker.com

Sales Representative:  
Brian.Hippen@stryker.com

Project:

Customer: WINNESHIEK MED CTR

City: DECORAH

Equip ID: 3P52

Quote No.: 10179648

Quote Date: 15-Aug-2023

Order Line #

DWG Rev: 1

DWG No.: 10179648-004

State: Iowa

Quote Rev No.: 4

QTY: 2

Rev: # 9





# WinnMed

WinnMed

Issue Date:

3/6/2024

Expansion and Renovation

Decorah, IA 52101

Furniture Specifications

CONTACT:

Ben Stevens - CFO

PHONE NUMBER:

563-387-3109

ITEM NUMBER:	36
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ITEM NAME:	OR 4 Ceiling Mounted Nurse Station		
ROOM NUMBER:		QUANTITY:	


## SPECIFICATION INFORMATION



MANUFACTURER: Stryker  
MODEL #: SPS-2  
DIMENSIONS: OR 4  
DESCRIPTION: Ceiling Mounted Nurse Station; 1 Shelf

## FURNITURE & EQUIPMENT IMAGE



# WinnMed

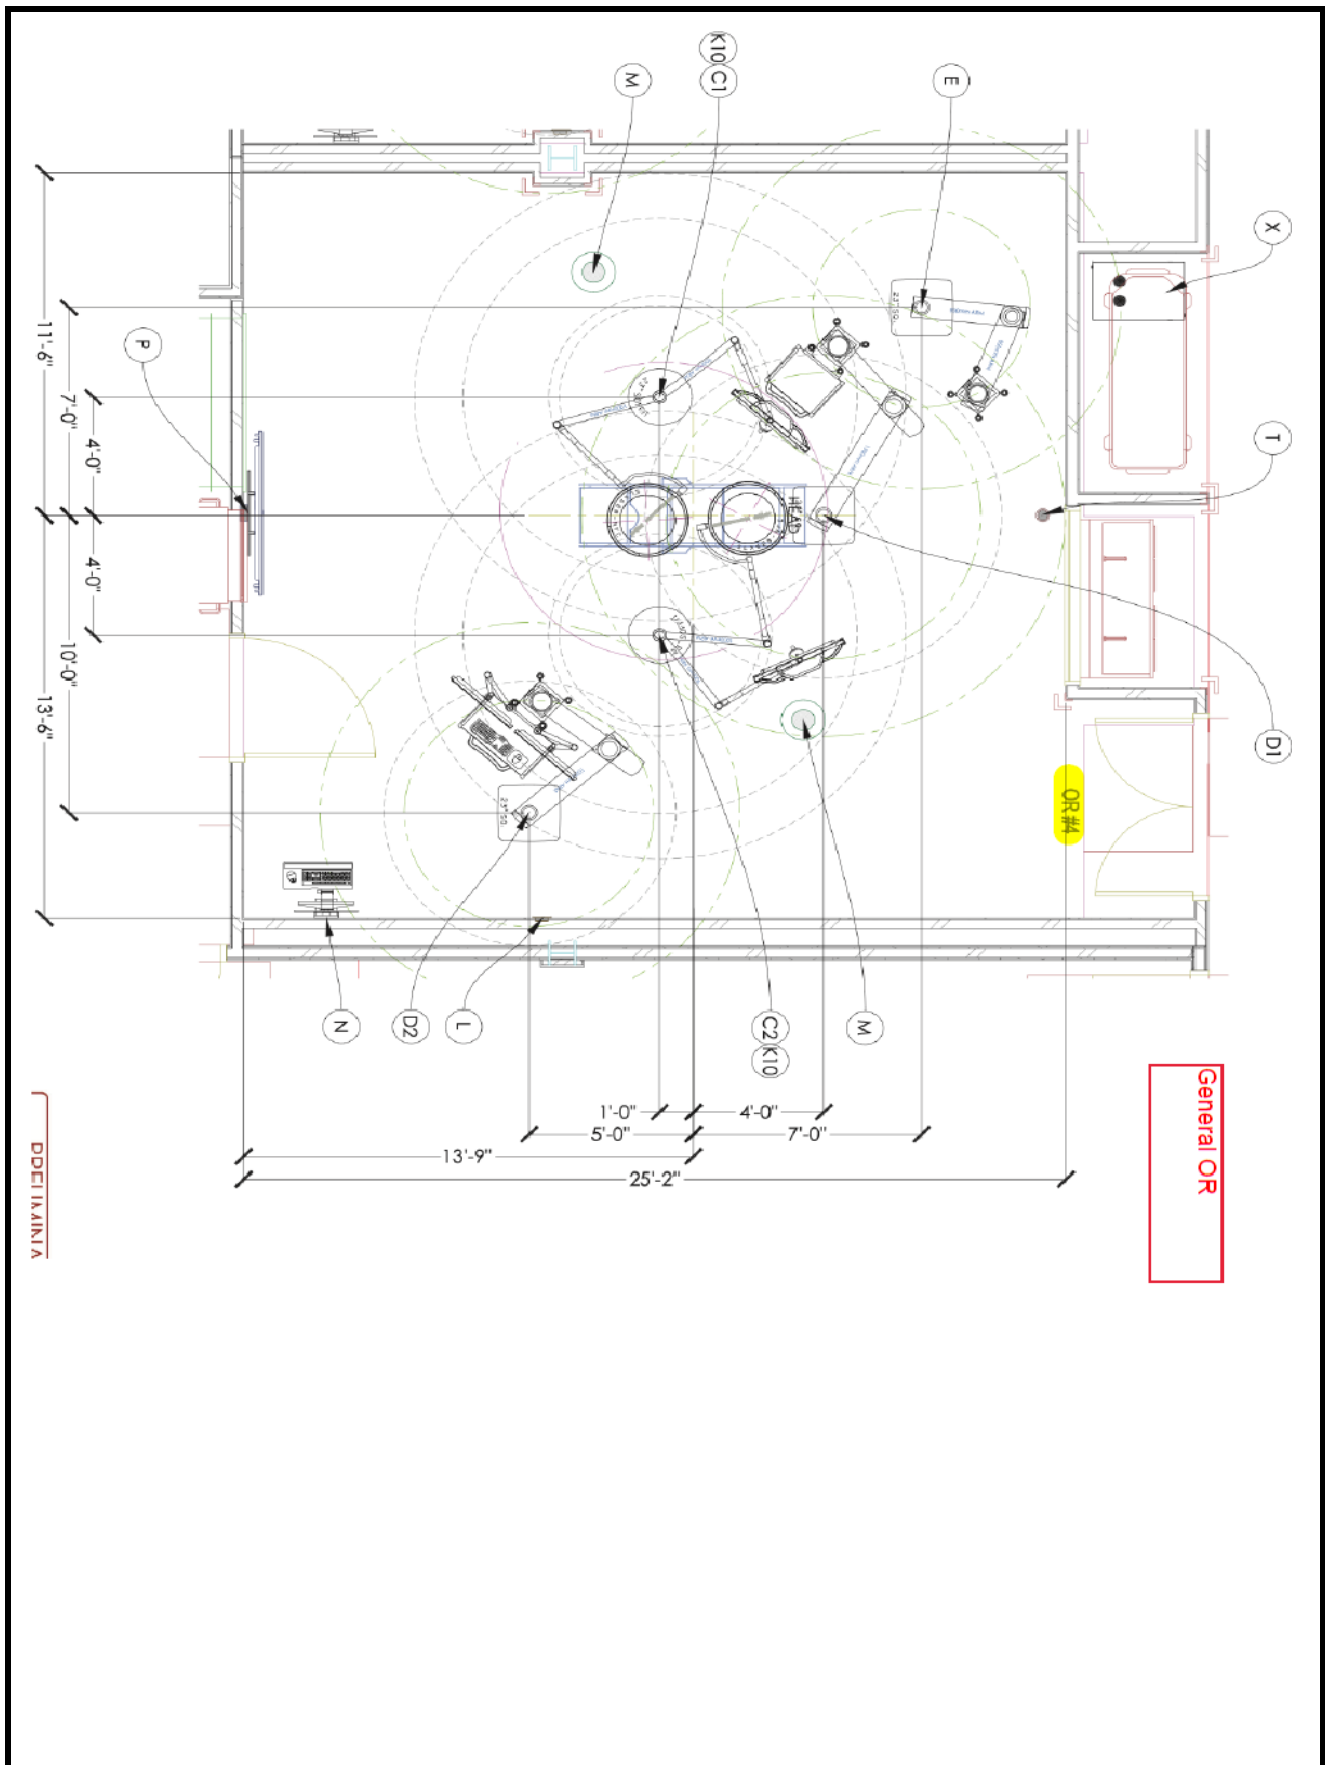


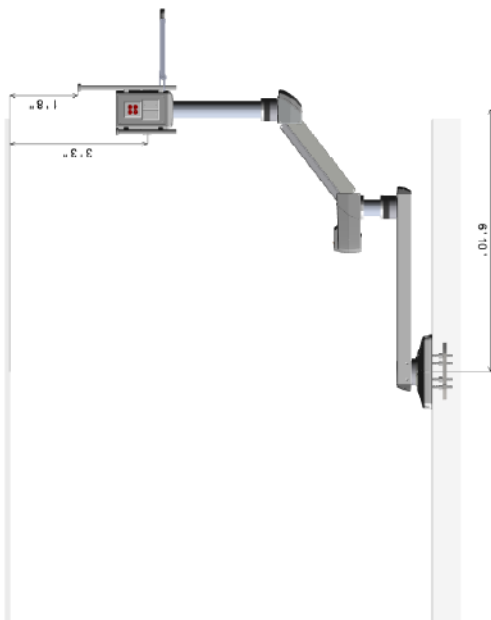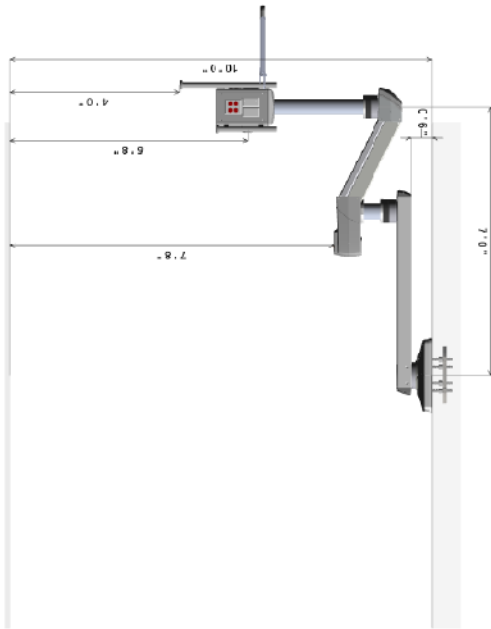


Suspension		S-Series Equipment Boom Shelves	
Brake System	Electric	Rail Type	Fairfield
Medical Rail Type	Fairfield	Shelf 1	750mm w/Controls
Top Arm Length	1300mm	Shelf 2	None
Bottom Arm Length	900mm	Shelf 3	None
Mid Tube Length	500mm	Shelf 4	None
Column Tube Length	700mm		
Weight Capacity (see note 1)	277 lbs		
Total Thrust Used (%)	29		
Gas Hose Length (ft)	15.91		
Packaging Type	Stand Up		
Manufacturing Notes	Do Not Assemble From MFR		

<p>I confirm the ceiling height and agree with the dimensions as shown. I confirm the equipment configuration as shown including arm lengths, platforms, gas key styles, brand, and locations; electronic, and low voltage selections and locations. I understand that any changes made after an order is in production will result in a change order fee and a delay in shipment.</p>			<p>NOTES:</p> <ol style="list-style-type: none"> <li>For weight, moments, and installation details, please refer to the Stryker Pre-installation manuals.</li> <li>It is the owner's responsibility to provide the support structure to meet requirements listed in the Pre-install Manual.</li> <li>Customer is responsible for reviewing and approving Gas Key Style and Manufacturer.</li> <li>Total weight capacity available for all Stryker and customer supplied accessories, based on weight moments listed in S-SERIES Pre-install Manual.</li> <li>Bottom of Stryker mounting plate must be installed at 3.0" above finished ceiling plane. All vertical boom dimensions shown in drawing are dependent on this requirement.</li> </ol>		
CUSTOMER APPROVALS	SIGNATURE	PRINT NAME & TITLE	DATE	Stryker Communications 3710 Montgomery Street Decorah, IA 52008 PHONE: (677) 784110 FAX: (660) 754-2969 www.stryker.com	
CLINICAL REPRESENTATIVE				Sales Representative: Brian Kipfel brankipfel@stryker.com	
FACILITY/ENGINEERING				<p>Project:</p> <p>Customer: WINNESHIEK MED CTR</p> <p>City: DECORAH State: Iowa</p> <p>Equip ID: SPS-2</p> <p>Group Name: ORs 3 &amp; 4</p> <p>Quote No.: 10179648</p> <p>Quote Date: 15-Aug-2023</p> <p>Quote Line #: 1</p> <p>DWG No.: 10179648S004</p> <p>State: Iowa</p> <p>Quote Rev No.: 4</p> <p>Qty: 2</p> <p>Block #: 9</p>	


FRONT

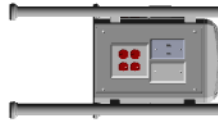

RIGHT

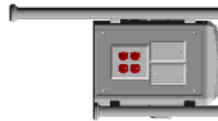

BACK

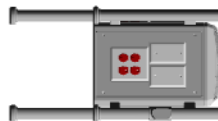

LEFT



F1	Distribution Box
F2	20A 125V Duplex
F3	20A 125V Duplex (4 Outlets)

R1	Blank
R2	Blank
R3	20A 125V Duplex (4 Outlets)

E1	Blank
E2	Blank
E3	20A 125V Duplex (4 Outlets)

L1	Blank
L2	Blank
L3	20A 125V Duplex (4 Outlets)

## Data Communications

Qty	Description
6	IG Bank Panel
1	IG Bank Wiring
1	Distribution Board

## Gas Outlets

Qty	Gas Type	Key Style	Manufacturer
1			

## High Voltage

Loc.	Circuit Ref #	Manufacturer	Location	Emergency	Color	Outlet Box	Description
F3	1				Red	A	20A 125V Duplex (4 Outlets)
R3	2				Red	A	20A 125V Duplex (4 Outlets)
B3	3				Red	A	20A 125V Duplex (4 Outlets)
L3	4				Red	A	20A 125V Duplex (4 Outlets)

## Circuits

Qty	Description
4	Total 15A/20A Circuits
1	Circuit for Motor and Brake

## Multi-Functional Rail (WFR)

Front	675mm
Back	450mm
Center	Rear Only

I confirm the ceiling height and agree with the dimensions as drawn. I confirm the equipment configuration as shown including arm lengths, platforms, gas key styles, blank, and locations, electronic, and low voltage selections and locations. I understand that any changes made after an order is in production will result in a change order fee and a delay in shipment.			
CUSTOMER APPROVALS	SIGNATURE	PRINT NAME & TITLE	DATE
CLINICAL REPRESENTATIVE			
FACILITY PURCHASER			

NOTES:			
1	For weight, moment, and installation details, please refer to the Stryker Pre-installation manual.	Stryker Communications 571 Seward Blvd Decorah, IA 52008 Phone: (877) 789-8105 Fax: (562) 542-2661 www.stryker.com	
2	It is the owner's responsibility to provide the support structure to meet requirements listed in the Pre-install Manual.		
3	Customer is responsible for reviewing and approving Gas Key Style and Manufacturer.		
4	Total weight capacity available for all Stryker and customer supplied components, listed on weight moments listed in S-STRYKER Pre-Install Manual.		
5	Bottom of Stryker mounting plate must be installed at 2' or above finished ceiling plane. All vertical boom dimensions shown in drawing are dependent on this requirement.		

Project:	Customer: WINNESHIEK MED CTR
City: DECORAH	State: Iowa
Equip ID: 3P52	
Group Name: ORS 3 4	Quote Ref No: 4
Quote No: 10179648	QTY: 2
Quote Date: 15-Aug-2023	
Order Line #	Part # 9
DWG Rev: 1	
DWG No.: 10179648-004	

# WinnMed

Room: ORs 1 3 4

Nursing Boom

PART #	DESCRIPTION	QTY	LIST PRICE	EXT LIST PRICE
SPS-2	S-SERIES, STANDARD POWERED, 2 ROW, 2 A	3		
<div> <div> <b>Mounting Details</b> </div> <div> <b>Shelves</b> </div> <div> <b>High Voltage Services</b> </div> <div> <b>Additional Cables</b> </div> <div> <b>Gas Services</b> </div> </div>				
Mounting Plate	Single Common Plate	Shelves 1	20A/125V Duplex (4 Outlets) 4	Gas Manufacturer Beacon Modems
Ceiling Cover	Standalone	Shelf Rail Type Fairfield		Gas Fitting Type Chemetron
Brake System	Electric	Shelf 1 750mm w/Controls	Low Voltage Services	
<b>MFR Configuration</b>			Blank Plate 6	
Front MFR Length	676mm	3rd Party Data Plate 1G Plate 1		
Rear MFR Length	406mm	Distribution Bd Plate 1		
MFR Controls	Rear Only			
PART #	DESCRIPTION	QTY	LIST PRICE	EXT LIST PRICE
P40075	ASM. HANDLE AND SHELF WITH FAIRFIELD R	3		
P36143	ASM. SHELF MOUNT HDW	3		
Configuration Total:				

# WinnMed

WinnMed

Issue Date:

3/6/2024

Expansion and Renovation

Decorah, IA 52101

Furniture Specifications

CONTACT:

Ben Stevens - CFO

PHONE NUMBER:

563-387-3109

ITEM NUMBER:	37
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ITEM NAME:	Integration System; Video Routing Platform		
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ROOM NUMBER:		QUANTITY:	
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## SPECIFICATION INFORMATION

MANUFACTURER: Stryker

MODEL #: 1678100004

DIMENSIONS:

DESCRIPTION: Integration System; Video Routing Platform

## FURNITURE & EQUIPMENT IMAGE



# WinnMed

Room: ORs 134

COR IP Integration



## Connected OR IP Integration System

The Connected OR IP Integration System is a modular, scalable and upgradeable operating room video routing platform. The 4K capable system provides intuitive control and routing of audio, video and data sources from a centrally located touch panel. Designed for the operating room, COR IP features customizable room presets, integrated surgical checklists, real-time messaging and centralized OR equipment controls. The system also seamlessly interfaces with additional Stryker platforms to improve clinical efficiency with optional EMR integration, two-way audio/video conferencing, remote in-room viewing, and server-based media asset management solutions.

PART #	DESCRIPTION	QTY	LIST PRICE	EXT LIST PRICE
1678100004	CONNECTED OR IP BASE PKG 004	3		

<u>Inputs</u>	<u>Boom Plates</u>	<u>Wall Plates</u>	<u>Outputs</u>	<u>Wall Display</u>	<u>Rack</u>	<u>Options</u>
<u>Sources</u>			<u>Suspension Display</u>			<u>Additional Packages</u>
Stryker 4K Endo Cam 1	HD-SDI Boom Plate 2		Stryker 4K Displays 2	Stryker 4K Displays 1	Install Type OR Adjacent	PIP/PBP/QUAD
Stryker HD ILC 1	4-in-1 Boom Plate 3				Stryker Provided UPS Yes	Mobile Phone Connection
Boom 4K HDMI 1					Stryker 24U Rack Yes	Secondary Audio
Boom HD DisplayPort 1					Switch Dedicated	Audio Package
						Basic - Ceiling Mounted
						Stryker 75in 4K Display 1
						<u>Encoders</u>

PART #	DESCRIPTION	QTY	LIST PRICE	EXT LIST PRICE
P30859	COMP. BARCO 21 SIN TP AND POWER SUPPLY	3		
P45613	CONNECTED OR IP USB 3.1 EXTENSION PKG	3		
P45670	CONNECTED OR IP STRYKER 4K DISPLAY FAIL-SAFE KIT	3		
P49719	CONNECTED OR IP DOUBLE HD VIDEO-PLATE INSTALL KIT	6		
P49718	CONNECTED OR IP SINGLE HD VIDEO-PLATE INSTALL KIT	3		
P45673	CONNECTED OR IP 2 CEILING SPEAKER PKG	3		
P45160	COMP. SELF-AMPLIFIED, MASTER IN-CEILING SPEAKER PAIR	3		
P49713	CONNECTED OR IP VIDEO COMPOSITOR PKG	3		
P43761	COMPONENT, BARCO MNA 240 TU SHELF	3		
P45644	CONNECTED OR IP MOBILE PHONE CONNECTIVITY PKG	3		
P47765	CONNECTED OR IP IN ROOM SECONDARY AUDIO INPUT KIT	3		
P47995	CABLE, BROADDATA 4K PLATE INPUT CABLE, 5M	6		
P47599	CABLE, NORTH AMERICA, MEDICAL GRADE, EC 60320 C13 TO NEMA 5-15, 120 VAC, 10 A, 3FT	15		
P49725	CONNECTED OR IP TOUCH PANEL INSTALL KIT	3		
P49689	CONNECTED OR IP STRYKER 4K ENDOCAM INSTALL KIT	3		
P49712	CONNECTED OR IP DVI OR HD HDMI IN-LIGHT CAMERA INSTALL KIT	3		
P49703	CONNECTED OR IP HD DP BOOM SOURCE INSTALL KIT	3		
P45641	CONNECTED OR IP 4K WALL DISPLAY INSTALL KIT	3		
P49707	CONNECTED OR IP 4K HDMI DISPLAY INSTALL KIT	6		
P45668	CONNECTED OR IP BOOM SUSPENSION MNA CABLE KIT	6		
P46220	DISPLAY, 75" 4K	3		
0100224156	MOUNT PLATE PLASMA/LCD	3		
P51445	CONNECTED OR IP SINGLE 4K VIDEO-PLATE INSTALL KIT	3		
P39292	CABLE, DUPLEX-LC-M TO DUPLEX-LC-M OM3, 2.0M	6		
P45623	CONNECTED OR IP 4K HDMI BOOM SOURCE INSTALL KIT	3		

Configuration Total:



# WinnMed

WinnMed

Issue Date:

3/6/2024

Expansion and Renovation

Decorah, IA 52101

Furniture Specifications

CONTACT:

Ben Stevens - CFO

PHONE NUMBER:

563-387-3109

ITEM NUMBER:	38
--------------	----

ITEM NAME:	Hospital Status System		
ROOM NUMBER:		QUANTITY:	

## SPECIFICATION INFORMATION

MANUFACTURER: Stryker  
MODEL #: 1678055001  
DIMENSIONS:  
DESCRIPTION: Hospital Status System

## FURNITURE & EQUIPMENT IMAGE



# WinnMed

Room: ORs 1 3 4 Endo Rooms 1 and 2

Hospital Status



## Hospital Status

Designed to improve hospital workflow and provide visibility into any area of the hospital by streaming live video feeds to your desktop or tablet. Hospital Status allows you to easily group and manage all your video feeds in one place.

PART #	DESCRIPTION	QTY	LIST PRICE	EXT LIST PRICE
1678055001	CONNECTED OR APPLICATION CENTER	1		
PART #	DESCRIPTION	QTY	LIST PRICE	EXT LIST PRICE
1678055003	CONNECTED OR HOSPITAL STATUS	1		
P48510	AXIS CAMERA RECESSED MOUNT	6		
8888880022	CAPITAL CAMERA NETWORK CAMERA	6		
P44028	CAMERA NETWORK	6		
8888882022	HOSPITAL STATUS MAINTENANCE AND SUPPORT, 1-15 CAMERAS	1		
8888889016	HOSPITAL STATUS, 1-15 CAMERAS	1		
Configuration Total:				

# WinnMed

WinnMed

Issue Date:

3/6/2024

Expansion and Renovation

Decorah, IA 52101

Furniture Specifications

CONTACT:

Ben Stevens - CFO

PHONE NUMBER:

563-387-3109

ITEM NUMBER:	39
--------------	----

ITEM NAME:	OR 3 Surgical Light		
ROOM NUMBER:		QUANTITY:	


## SPECIFICATION INFORMATION



MANUFACTURER: Stryker  
MODEL #: FD 2203  
DIMENSIONS: OR 3  
DESCRIPTION: OR 3 Surgical Light w/ Monitor; 2 Arm; Camera Ready; Sterile Control Prep & Light Handle

## FURNITURE & EQUIPMENT IMAGE



# WinnMed

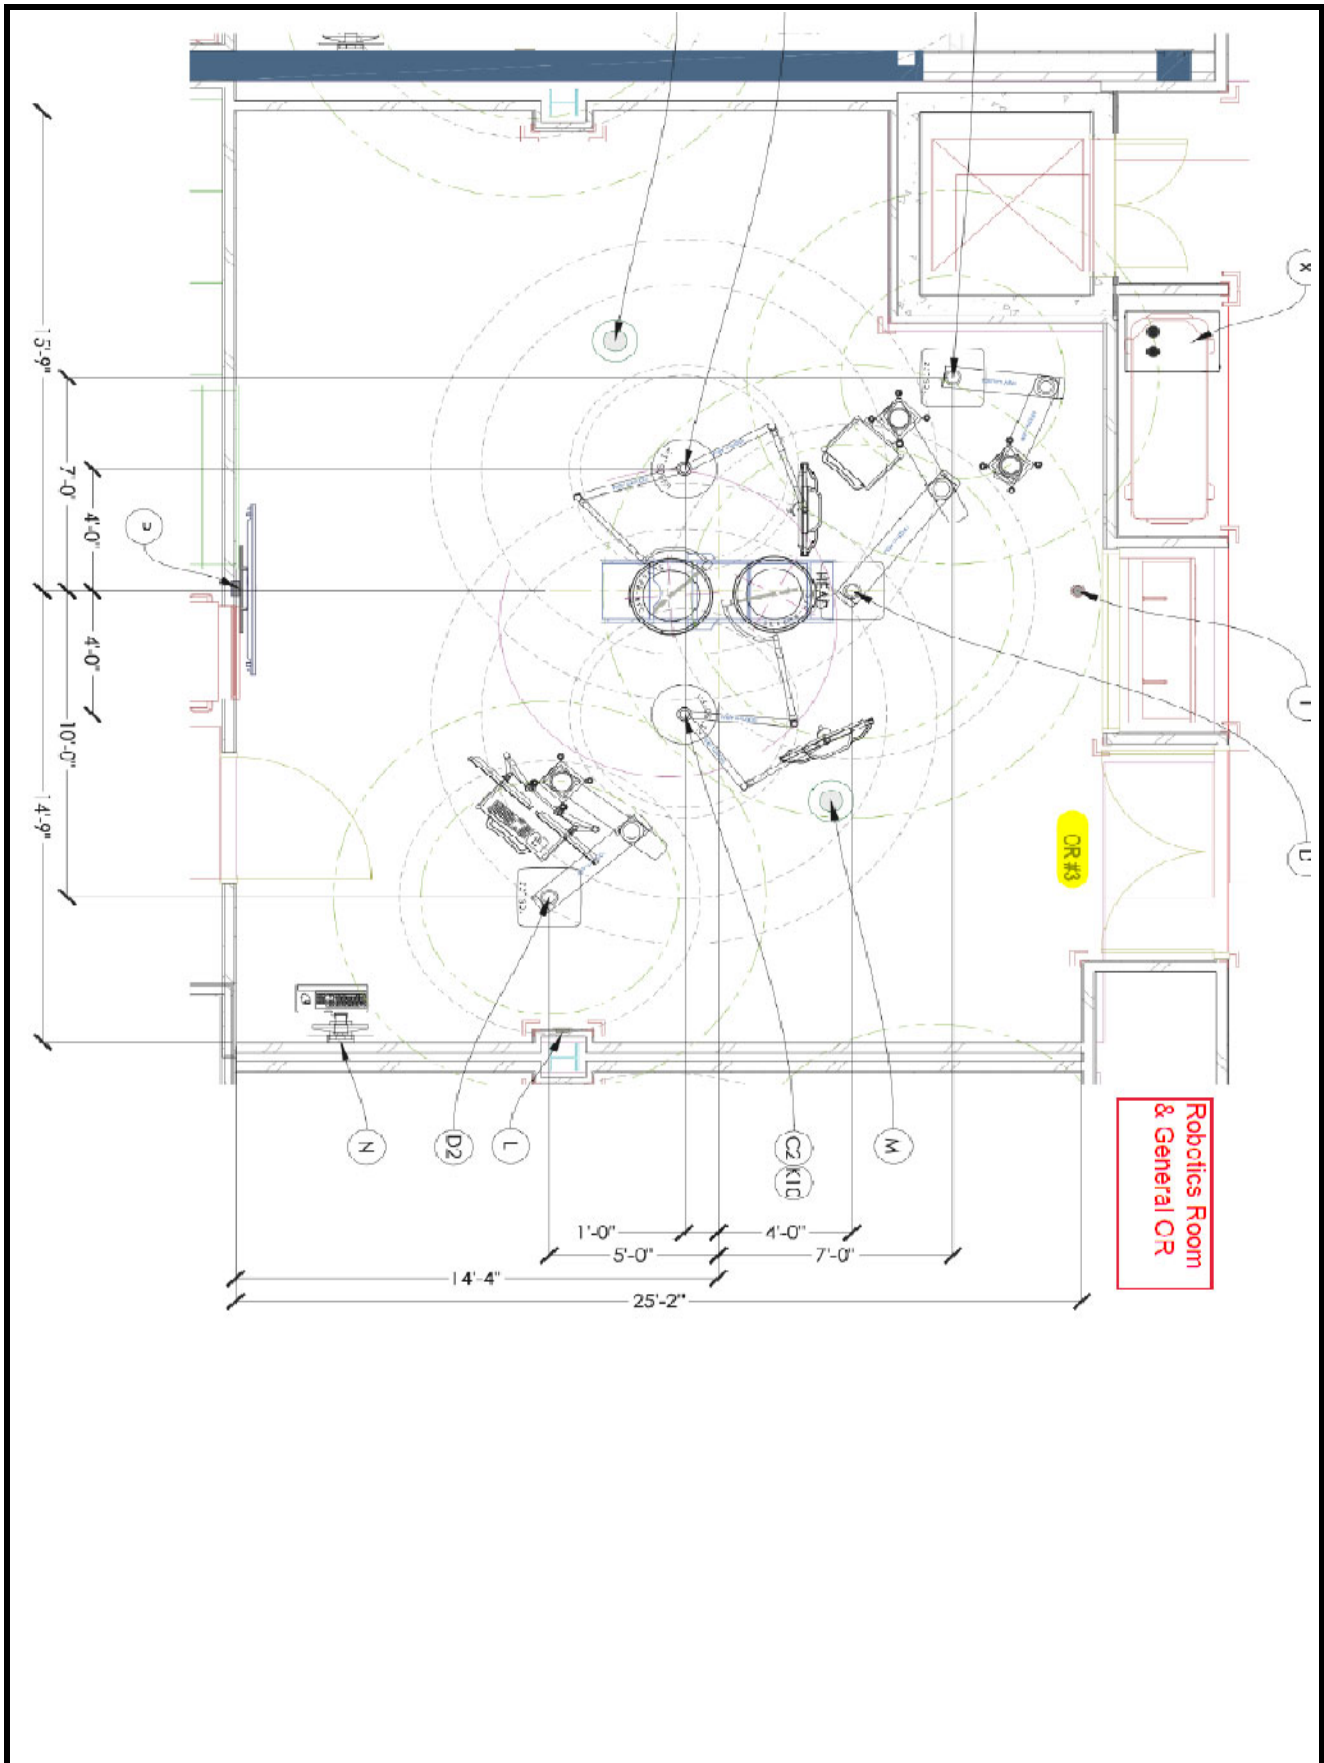

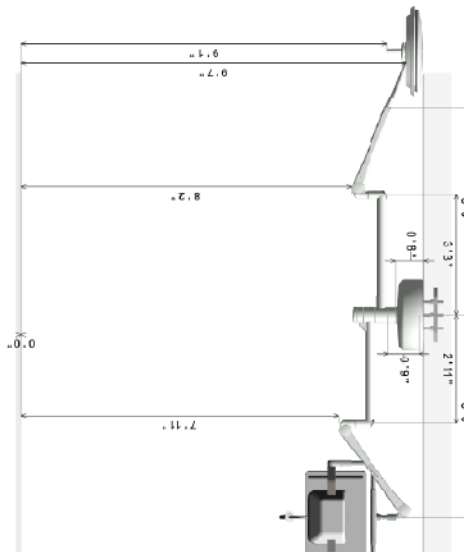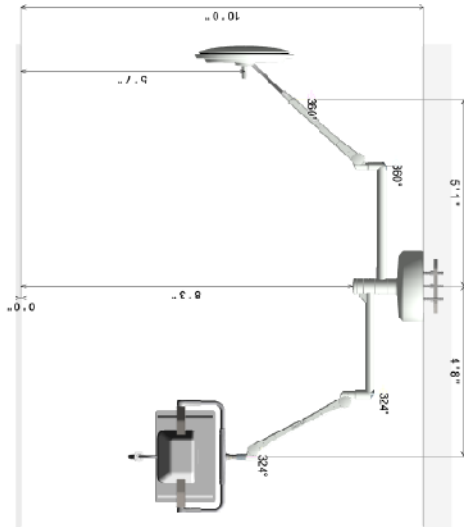

Main Mount	
Mounting Plate Type	Single Common Plate
Ceiling Corner	CE S423004
Tube Length	239
Electronics in SX Box	Yes
Wall Control?	Yes
Camera Type	30p/60p HD
Camera Endo Use	No
Wall Control Type	recessed
Light Handle Type	SC+ Devon slip on
Device Control	No
SX Box Type	surface mount

Arm No. 1 (MP1)	
Equipment	SLX28
Horizontal Arm	1000
HCT Length	None
Cardiac	NFC
Dual Control	No
Main Voltage	120VAC

Arm No. 2 (MP2)	
Equipment	UDM (13"-32")
Horizontal Arm	900
HCT Length	None
Dual Control	No
FPS Monitor	UDM (13"-32")
Video Bridge	StrykerUDM

I confirm the ceiling height and agree with the dimensions as drawn. I confirm the equipment configuration as shown including arm height, position, gas key styles, brand, and location, and low voltage selections and locations. I understand that any changes made after an order is in production will result in a change order fee and a delay in shipment.

CLINICAL REPRESENTATIVE	SIGNATURE	PRINT NAME & TITLE	DATE
FACILITY ENGINEERING			

- NOTES:
- For weights, movement, and installation details, please refer to the Stryker Pre-Installation Manual.
  - It is the user's responsibility to provide the support structure for arm requirements listed in the Pre-Install Manual.

Stryker Communications  
571 Seward Blvd.  
P.O. Box 6073  
Decorah, IA 52001  
www.stryker.com

Project:	
Customer:	WINNESHAK MED CTR
City:	DECORAH
State:	Iowa
Phone:	563-382-2911
Fax:	563-387-3102
Group Name:	CRS 3.4
Quote No.:	10179048
Quote Date:	15-Aug-2013
Quote Line #	QTY: 2
DWG Rev No.:	1
DWG Rev No.:	1
DWG Rev No.:	1

# WinnMed

Room: ORs 3 4

SLX Light with UDM



## SLX Surgical Light

The Stryker Surgical Light combines innovative features, inspired by the best technology, to provide superior light quality for your surgical team. And with so many options to customize, configure, and control your light, you can now enhance the OR experience like never before.

PART #	DESCRIPTION	QTY	LIST PRICE	EXT LIST PRICE
FD 2203	LIGHT / SFP1	2		

### Mounting Details

Mounting Plate Single Common Plate

Multiple Suspension Mounting None

Ceiling Cover CB 5423004 590x197 TD 125mm

Drop Tube Length 230

### Controls

Wall Control Wall mounted (recessed)

Cardanic Control No

Control Unit Type Touch

Light Handle Type Sterile Controls (Devon slip on)

### Power Supply

SK Box Above Ceiling or Surface Mount

### Configuration Details

Arm 1 Lighthead

Arm Length 1000

Cardanic Style NFC

Camera Prep Yes

Arm 2 Monitor bracket

Arm Length 900

PART #	DESCRIPTION	QTY	LIST PRICE	EXT LIST PRICE
P43779	BUNDLE, STRYKECAM READY	2		
CY 9000150	LIGHT OR FLAT PANEL HANDLE	2		
CY 9000103	UDM INTERSTITIAL AND SUSPENSION CABLES	2		
CY 9600105	PREPARATION CAMERA STRYKECAM HD	2		
CY 1008104	MULTI COLOR TOUCH WALL CONTROL DISPLAY FOR SINGLE, DUAL OR TRIPLE F- GENERATION LIGHT CONFIGURATION	2		
CY 9000122	STERILE CONTROL PREP	2		
CY 9000123	STERILE CONTROL+ LIGHT HANDLE	2		

Configuration Total:

# WinnMed

WinnMed  
Expansion and Renovation  
Decorah, IA 52101  
Furniture Specifications

Issue Date: 3/6/2024

**CONTACT:** Ben Stevens - CFO  
**PHONE NUMBER:** 563-387-3109

ITEM NUMBER:	40
--------------	----

ITEM NAME:	OR 4 Surgical Light		
ROOM NUMBER:		QUANTITY:	

## SPECIFICATION INFORMATION

MANUFACTURER: Stryker  
MODEL #: FD 2203  
DIMENSIONS: OR 4  
DESCRIPTION: OR 4 Surgical Light w/ Monitor; 2 Arm; Camera Ready; Sterile Control Prep & Light Handle

## FURNITURE & EQUIPMENT IMAGE





# WinnMed

WinnMed  
Expansion and Renovation  
Decorah, IA 52101  
Furniture Specifications

Issue Date: 3/6/2024

CONTACT: Ben Stevens - CFO  
PHONE NUMBER: 563-387-3109

ITEM NUMBER:	41
--------------	----

ITEM NAME:	OR 3 Surgical Light		
ROOM NUMBER:		QUANTITY:	

## SPECIFICATION INFORMATION

MANUFACTURER: Stryker  
MODEL #: FD 2203  
DIMENSIONS: OR 3  
DESCRIPTION: OR 3 Surgical Light w/ Monitor; 2 Arm; Sterile Control Prep & Light Handle

## FURNITURE & EQUIPMENT IMAGE





# WinnMed

WinnMed

Issue Date:

3/6/2024

Expansion and Renovation

Decorah, IA 52101

Furniture Specifications

CONTACT:

Ben Stevens - CFO

PHONE NUMBER:

563-387-3109

ITEM NUMBER:	42
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ITEM NAME:	OR 4 Surgical Light		
ROOM NUMBER:		QUANTITY:	


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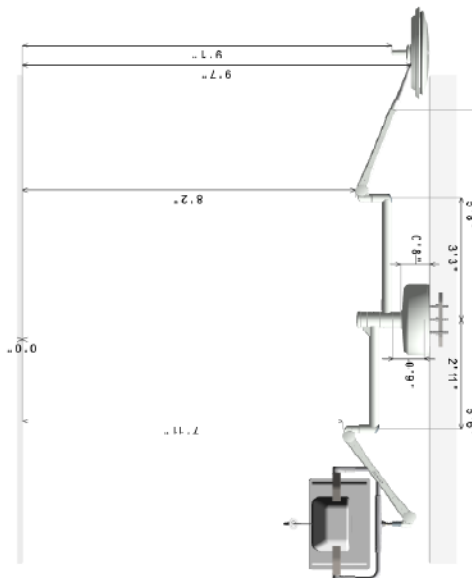
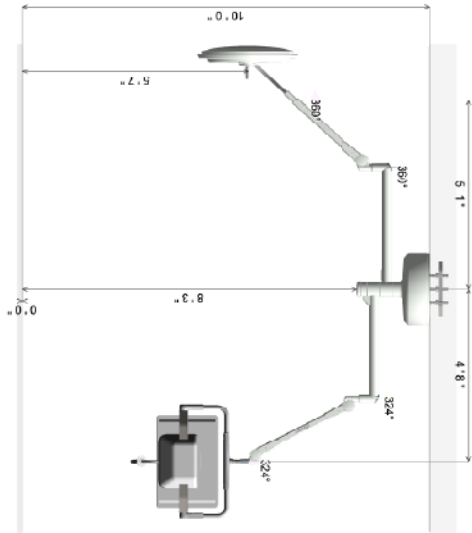
MANUFACTURER: Stryker  
MODEL #: FD 2203  
DIMENSIONS: OR 4  
DESCRIPTION: OR 4 Surgical Light w/ Monitor; 2 Arm; Sterile Control Prep & Light Handle

## FURNITURE & EQUIPMENT IMAGE



# WinnMed



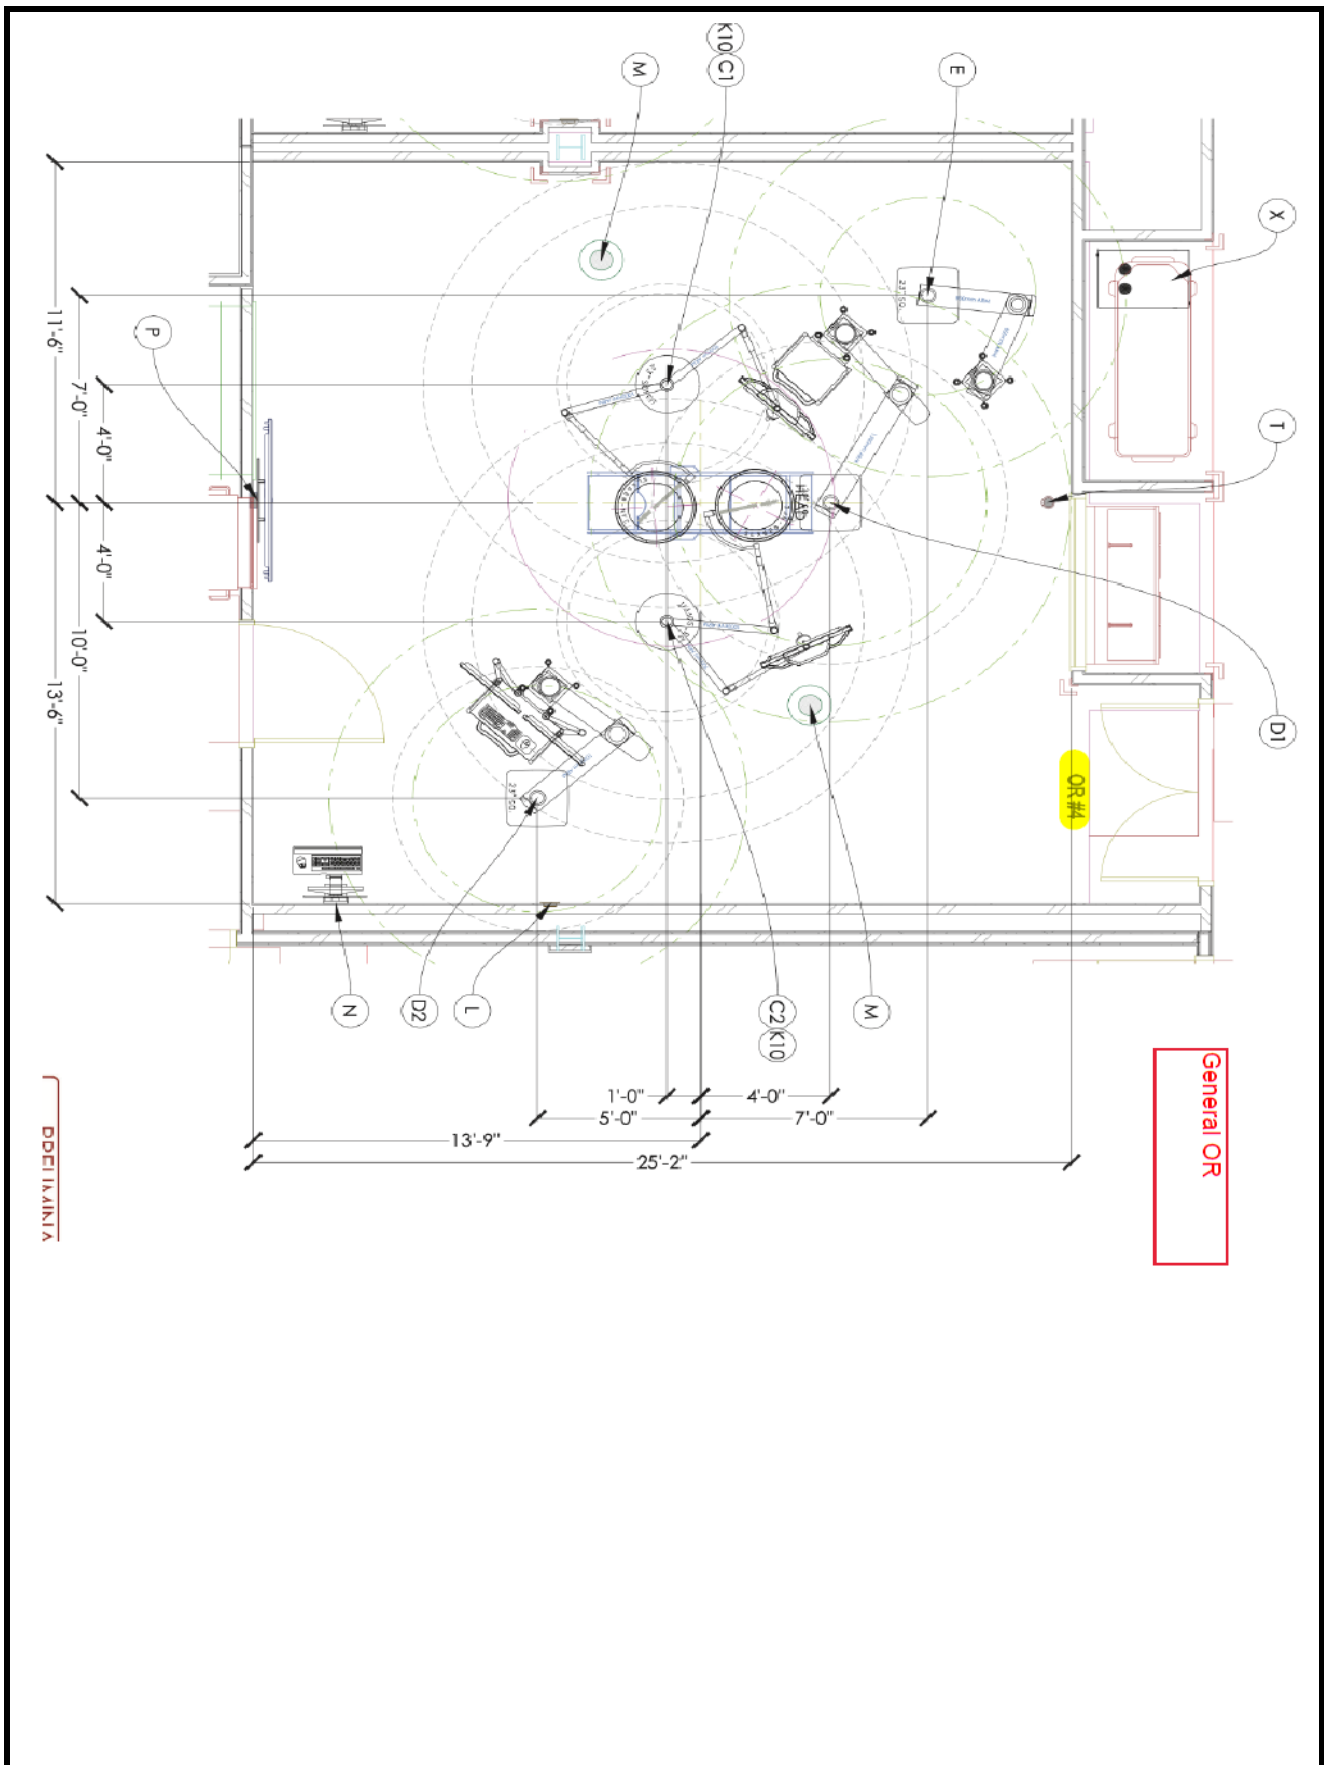

Main Mount	
Mounting Plate Type	Single Common Plate
Ceiling Cover	CS-342304
Tube Length	210
Electronics in SK Box	Yes
Wall Control?	Yes
Camera Type	None
Camera Endo Use	No
Wall Control Type	needed
Light Handle Type	SC+ Devon slip on
Device Control	No
SK Box Type	surface mount

Arm No.1 (MP1)	
Equipment	SLXs28
Horizontal Arm	1000
HCT Length	None
Circular	NFC
Dial Control	No
Mains Voltage	120VAC

Arm No.2 (MP2)	
Equipment	UDM (19" - 32")
Horizontal Arm	500
HCT Length	None
Dial Control	No
FRT Monitor	UDM (19" - 32")
Video Bundle	StrykerUDM

Confirm the ceiling height and space with the dimensions as shown. Confirm the equipment configuration as shown including arm lengths, platforms, gas key, styles, brand, and locations. electronic, and low voltage selections and locations. Understand that any changes made after an order is in production will result in a change order fee and a delay in shipment.

CUSTOMER APPROVALS	SIGNATURE	PRINT NAME & TITLE	DATE
CLINICAL REPRESENTATIVE			
FACILITY DRONCE/CRINO			

NOTES:  
 1 For weights, moments, and installation details, please refer to the Stryker Pre-installation manuals.  
 2 requirements listed in the Pre-install Manual.

Stryker Communications 571 Stryker Blvd. P.O. Box 17248 Kalamazoo, MI 49001 E-MAIL: (401) 754-2000 www.stryker.com	
Sales Representative : Brian Kipfel brian.kipfel@stryker.com	Project Customer: WINNEMED MED CTR City: DECORAH Equip ID: F-628S-FP Group Name: CRG 3.4 Quote No.: 10179548 Quote Date: 15 Aug 2023 Change Line #: 1 DWG Rev No.: 1
	State: Iowa Qty: 2 Quote Rev No.: 4 Back #: 14

# WinnMed

Room: ORs 3 4

SLX Light with UDM

PART #	DESCRIPTION	QTY	LIST PRICE	EXT LIST PRICE
FD 2203	LIGHT / SFP1	2		

## Mounting Details

Mounting Plate: Single Common Plate

Multiple Suspension Mounting: None

Ceiling Cover: CB 5423004 590x197 TD 125mm

Drop Tube Length: 230

## Controls

Wall Control: Wall mounted (recessed)

Cardanic Control: No

Control Unit Type: Touch

Light Handle Type: Sterile Control+ (Devon slip on)

## Power Supply

SK Box: Above Ceiling or Surface Mount

## Configuration Details

Arm 1: Lighthead

Arm Length: 1000

Cardanic Style: NFC

Camera Prep: No

Arm 2: Monitor bracket

Arm Length: 900

PART #	DESCRIPTION	QTY	LIST PRICE	EXT LIST PRICE
CY 9000150	LIGHT OR FLAT PANEL HANDLE	2		
CY 9000103	UDM INTERSTITIAL AND SUSPENSION CABLES	2		
CY 1008104	MULTI COLOR TOUCH WALL CONTROL DISPLAY FOR SINGLE, DUAL OR TRIPLE GENERATION LIGHT CONFIGURATION	2		
CY 9000122	STERILE CONTROL PREP	2		
CY 9000123	STERILE CONTROL+ LIGHT HANDLE	2		

Configuration Total:

# WinnMed

WinnMed

Issue Date:

3/6/2024

Expansion and Renovation

Decorah, IA 52101

Furniture Specifications

CONTACT:

Ben Stevens - CFO

PHONE NUMBER:

563-387-3109

ITEM NUMBER:	43
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ITEM NAME:	OR 3 Anesthesia Boom		
ROOM NUMBER:		QUANTITY:	


## SPECIFICATION INFORMATION

MANUFACTURER: Stryker  
MODEL #: SFS-2  
DIMENSIONS: OR 3  
DESCRIPTION: OR 3 Ceiling Mounted Anesthesia Boom; 2 Row, 2 Arm, 1 Air, 2 Vac, 1 N2O Gas, 2 O2, 1 WAGD Gas

## FURNITURE & EQUIPMENT IMAGE




# WinnMed

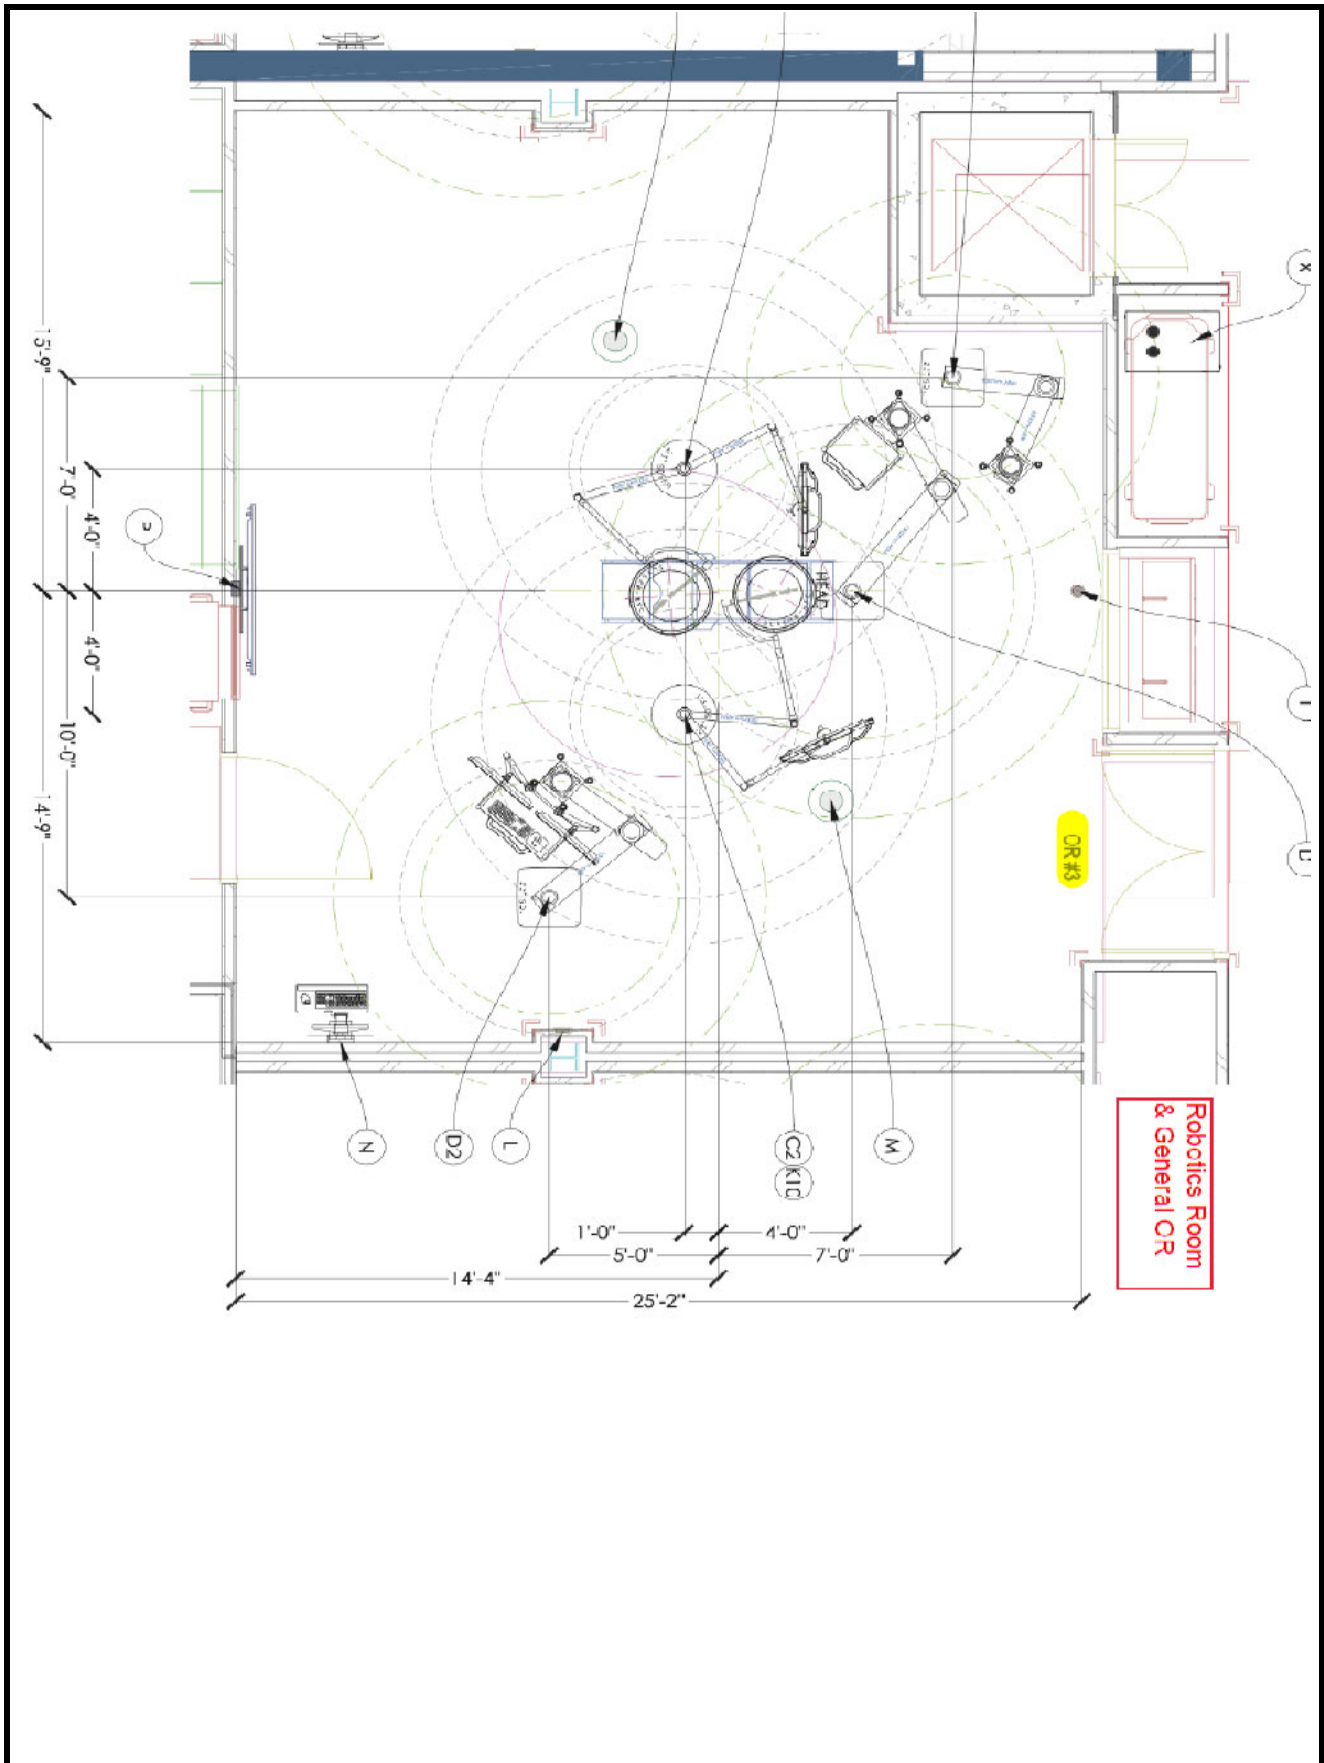

## ORs 3 & 4 - Anesthesia Boom

Quote: 10179648 Rev:4 Block#: 1

**stryker**  
10' 0"

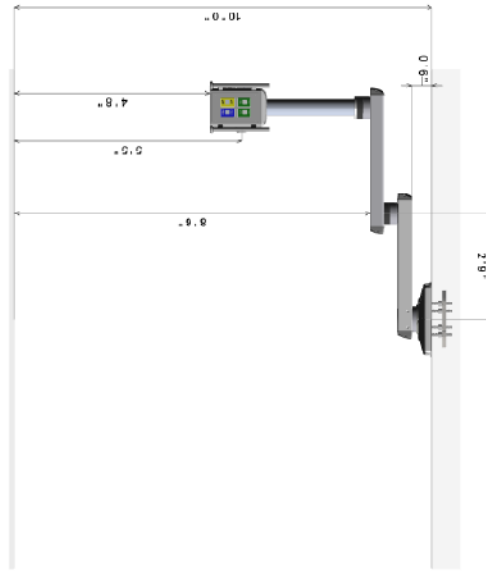

Suspension	
Brake System	Electric
Medical Rail Type	Extruded
Top Arm Length	850mm
Bottom Arm Length	850mm
Column Tube Length	700mm
Weight Capacity (see note 4)	500 lbs.
Total Throat Usable (%)	58
Gas Hose Length (ft)	13.56
Packaging Type	1 way Down
Manufacturing Notes	Assemble All MFR's

I confirm the ceiling height and agree with the dimensions as drawn. I confirm the equipment configuration as shown including arm lengths, platforms, gas key styles, brand, any locations, electronic, and low voltage selections and locations. I understand that any changes made after an order is in production will result in a change order fee and a delay in shipment.			NOTES:		<p>Stryker Communications Phone: (877) 786-8706 Fax: (404) 744-2959 www.stryker.com</p> <p>Sales Representative: Brian Kippel brankip@stryker.com</p>	<p>Project: Customer: WINNESHIEK MED CTR City: DECORAH Setup ID: 5F5Z2 Group Name: ORs 3 &amp; 4 Quote No.: 10179648 Quote Date: 15-Aug-2023 Crack Line #: QTY: 2 DMS Rev No.: 4 Block #: 1</p>
CUSTOMER APPROVALS	SIGNATURE	PRINT NAME & TITLE	DATE	1		
CLINICAL REPRESENTATIVE				2		
				3		
FACILITY ENGINEERING				4		
				5		




## ORs 3 4 - Anesthesia Boom

Quote 10179648 Rev.4 Block# 1

stryker  
10' 0"

FRONT

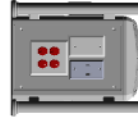

F1	3rd Pkg Data
F2	Paas US
F3	20A/125V Duplex (4 Outlets)

RIGHT



R1	O2
R2	O2
R3	Med Air
R4	N2O

BACK



B1	20A/125V Duplex (4 Outlets)
B2	30A Line 4-in-1
B3	20A/125V-5-20R Duplex

LEFT



L1	MACO
L2	Blank
L3	MAC
L4	MAC

### Data Communications

Qty	Description
1	1IG Blank Plate
2	1IG Blank W/Spring
1	Distribution Board
1	COR Line 4-in-1 Plate

### Gas Outlets

Qty	Gas Type	Key Style	Manufacturer
2	Oxygen (O2)	Chertnon	Beacon Medias
1	Nitrous Oxide (N2O)	Chertnon	Beacon Medias
1	Medical Air	Chertnon	Beacon Medias
2	Vacuum	Chertnon	Beacon Medias
1	MACO	Chertnon	Beacon Medias

### Light Voltage

Main Power Type	Isolated
Man Power Source	Emergency
Manufacturer	Lection
Loc	Circuit Ref #
F3	1
B1	2
B3	3
	1
	Red
	A
	20A/125V Duplex (4 Outlets)
	20A/125V-5-20R Duplex

### Circuits

Qty	Description
3	Total 15A/20A Circuits
1	Circuit for Motor and Brake

Front	400mm
Back	400mm
Control	Rear Only

I confirm the ceiling height and agree with the dimensions as given. I confirm the equipment configuration as shown including arm heights, platforms, gas key styles, brand, and locations, electronic, and low voltage selections and locations. I understand that any changes made after an order is in production will result in a change order fee and a delay in shipment.

### NOTES:

- For weights, moments, and installation details, please refer to the Stryker Pre-Installation Manual.
- It is the customer's responsibility to provide the support structure to meet requirements listed in the Pre-Installation Manual.
- Customer is responsible for reviewing and approving Gas Key Style and Manufacturer.
- Total weight capacity available for all Stryker and customer supplied accessories, based on weights moments listed in S-SERIES Pre-Instal Manual.
- Bottom of Stryker mounting plate must be installed at 1JC above finished ceiling. If ceiling is not level, the anesthesia boom dimensions shown in drawing are dependent on this requirement.

Stryker Communications

571 Swann Blvd  
Decorah, IA 52001  
Phone: (563) 382-2911  
Fax: (563) 387-3102  
www.stryker.com

Sales Representative :  
Brian Kugel  
brian.kugel@stryker.com

Project	Customer: WINNESHIER MED CTR	State: Iowa
Qty	DECORAH	
Equip ID	SFS-2	
Group Name	ORs 3 & 4	
Quote No.	10179648	Quote Rev No.: 4
Quote Date	15 Aug 2023	QTY: 2
Quote Line #		
DWG Rev No.: 4		Block # 1
DWG No.: 10179648/001		



# WinnMed

Room: ORs 3 4

Anesthesia Boom



## S-Series Standard Equipment Management System

Introducing a new standard in equipment management. With a completely redesigned user interface and a compact, fully customizable system, it has never been easier to manage your services and maneuver your equipment.

PART #	DESCRIPTION		QTY	LIST PRICE	EXT LIST PRICE
SFS-2	S-SERIES, STANDARD FIXED, 2 ROW, 2 ARM		2		
<b>Mounting Details</b>					
Mounting Plate	Single Common Plate	Shelves 0	20A/125V-3-20R Duplex 1	Gas Services	
Ceiling Cover	Standalone		20A/125V Duplex (4 Outlets) 2	Gas Manufacturer	Beacon Medical
Brake System	Electric			Gas Fitting Type	Chematron
				Air Gas	1
				Vac Gas	2
<b>MFR Configuration</b>				N2O Gas	1
Front MFR Length	406mm		3rd Party Data Plate 1G Plate 1	O2 Gas	2
Rear MFR Length	406mm		Distribution Bd Plate 1	WAGD Gas	1
MFR Controls	Rear Only		COR Lite 4-in-1 Plate 1		
<b>Configuration Total:</b>					

# WinnMed

WinnMed

Issue Date:

3/6/2024

Expansion and Renovation

Decorah, IA 52101

Furniture Specifications

CONTACT:

Ben Stevens - CFO

PHONE NUMBER:

563-387-3109

ITEM NUMBER:	44
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ITEM NAME:	OR 4 Anesthesia Boom		
ROOM NUMBER:		QUANTITY:	


## SPECIFICATION INFORMATION

MANUFACTURER: Stryker  
MODEL #: SFS-2  
DIMENSIONS: OR 4  
DESCRIPTION: OR 4 Ceiling Mounted Anesthesia Boom; 2 Row, 2 Arm, 1 Air, 2 Vac, 1 N2O Gas, 2 O2, 1 WAGD Gas

## FURNITURE & EQUIPMENT IMAGE




# WinnMed

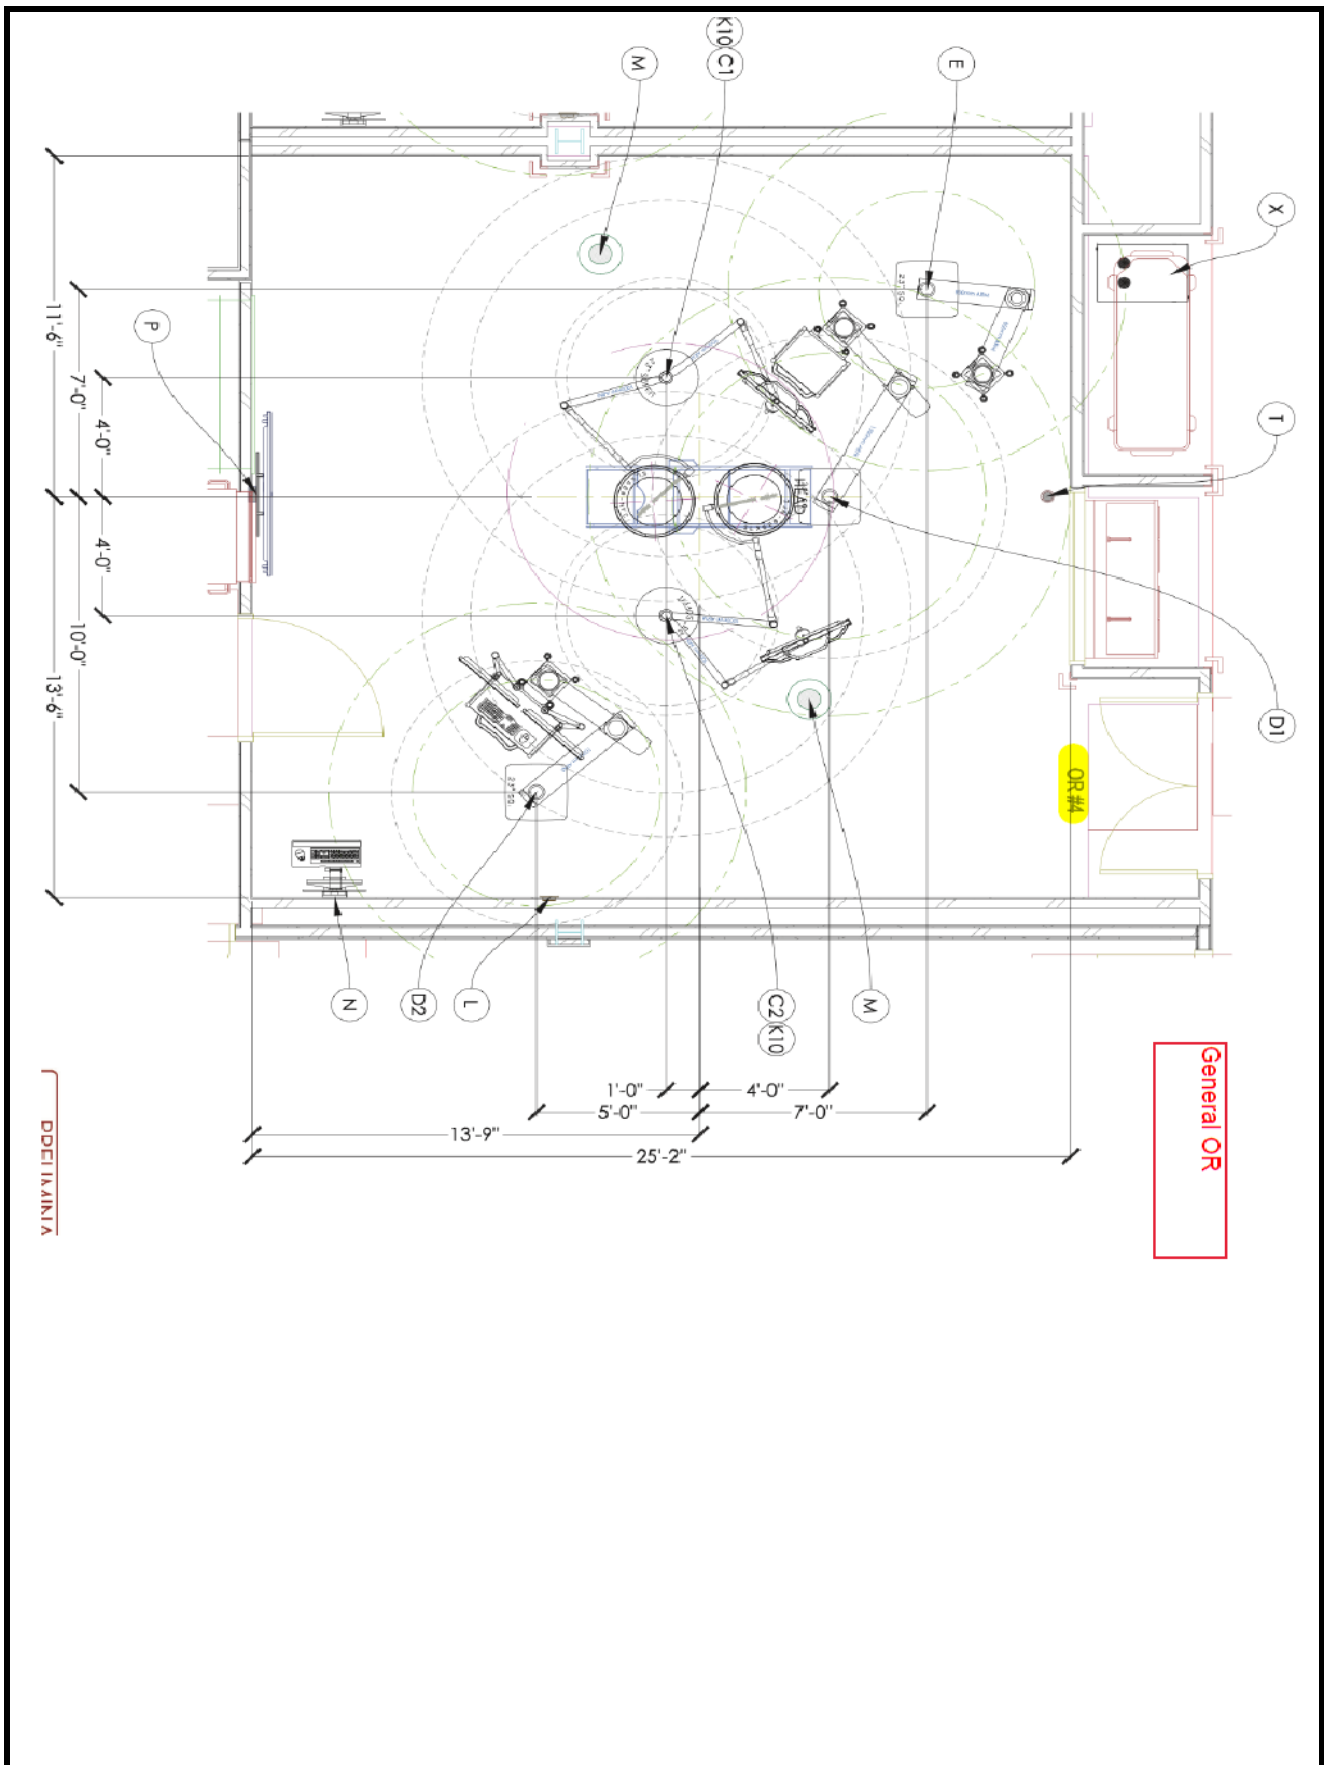

## ORs 3 & 4 - Anesthesia Boom

Quote: 10179648 Rev:4 Block#: 1

**stryker**  
10' 0"

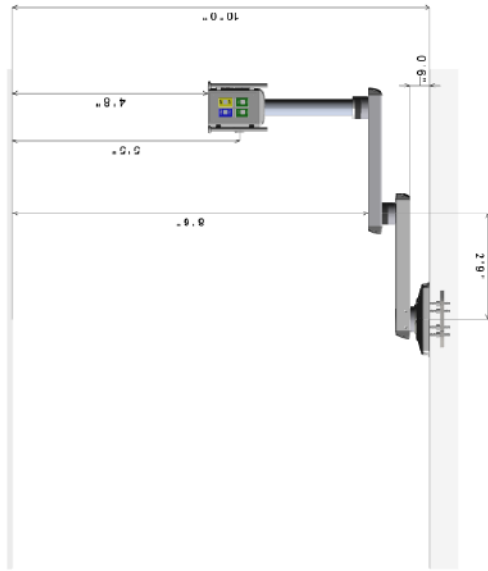

Suspension	
Brake System	Electric
Medical Rail Type	Extruded
Top Arm Length	850mm
Bottom Arm Length	850mm
Coumn Tube Length	700mm
Weight Capacity (see note 4)	500 lbs.
Total Throat Usable (%)	58
Gas Hose Length (ft)	13.56
Packaging Type	1 way Down
Manufacturing Notes	Assemble All MFR's


I confirm the ceiling height and agree with the dimensions as drawn. I confirm the equipment configuration as shown including arm lengths, platforms, gas key styles, brand, any locations, electronic, and low voltage selections and locations. I understand that any changes made after an order is in production will result in a change order fee and a delay in shipment.							
CUSTOMER APPROVALS	SIGNATURE	PRINT NAME & TITLE	DATE				
CLINICAL REPRESENTATIVE							
FACILITY ENGINEERING							
<p><b>NOTES:</b></p> <p>1 For weights, moments, and installation details, please refer to the Stryker Pre-Installation Manual.</p> <p>2 It is the owner's responsibility to provide the support structure to meet requirements listed in the Pre-Install Manual.</p> <p>3 Customer is responsible for reviewing and approving Gas Key Style and Manufacturer.</p> <p>4 Total weight capacity available for all Stryker and customer supplied Manual works, based on weights/moments listed in Stryker's Pre-Install Manual.</p> <p>5 Person of Stryker mounting plate must be installed as 1' or above finished ceiling plane. All vertical boom dimensions shown in drawing are dependent on this requirement.</p>				<p>Stryker Communications 3150 Sutter Blvd. Pleasanton, CA 94588 PHONE: (877) 786-8706 FAX: (408) 444-2959 www.stryker.com</p> <p>Sales Representative: : Brian Kippel brankip@stryker.com</p>			
				Project: WINNESHIEK MED CTR			
				Customer: WINNESHIEK MED CTR			
				City: DECORAH			
				State: Iowa			
				Setup ID: 5F5Z2			
				Group Name: ORs 3 & 4			
				Quote Ref No.: 4			
				Quote No.: 10179648			
				Quote Date: 15-Aug-2023			
				Crack Line #: QTY: 2			
				DWG Rev No.: 4			
				Block #: 1			
				DWG No.: 10179648S001			

## ORs 3 4 - Anesthesia Boom

Quote 10179648 Rev.4 Block# 1

stryker  
10' 0"

FRONT

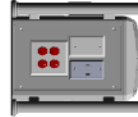

F1 3rd Pkg Data
F2 Gas IS
F3 Distribution Bd
F4 20A/125V Duplex (4 Outlets)

RIGHT



R1 O2
R2 O2
R3 Med Air
R4 N2O

BACK



B1 20A/125V Duplex (4 Outlets)
B2 30A Line 4-in-1
B3 20A/125V-5-20R Duplex

LEFT



L1 MACO
L2 Blank
L3 MAC
L4 MAC

### Data Communications

Qty	Description
1	1IG Blank Plate
2	1IG Blank W/Strip
1	Distribution Board
1	COR Line 4-in-1 Plate

### Gas Outlets

Qty	Gas Type	Key Style	Manufacturer
2	Oxygen (O2)	Chertnon	Beacon Medias
1	Nitrous Oxide (N2O)	Chertnon	Beacon Medias
1	Medical Air	Chertnon	Beacon Medias
2	Vacuum	Chertnon	Beacon Medias
1	MACO	Chertnon	Beacon Medias

### Light Voltage

Main Power Source		Emergency			
Manufacturer	Location				
Loc.	Circuit Ref #	# of Circuits	Color	Outlet Box	Description
F3	1	1	Red	A	20A/125V Duplex (4 Outlets)
B1	2	1	Red	A	20A/125V Duplex (4 Outlets)
B3	3	1	Red	A	20A/125V-5-20R Duplex

### Circuits

Qty	Description
3	Total 15A/20A Circuits
1	Circuit for Motor and Brake

Front	400mm
Back	400mm
Control	Rear Only

I confirm the ceiling height and agree with the dimensions as given. I confirm the equipment configuration as shown including arm heights, platforms, gas key styles, brand and locations, electronic, and low voltage selections and locations. I understand that any changes made after an order is in production will result in a change order fee and a delay in shipment.

### NOTES:

- For weights, moments, and installation details, please refer to the Stryker Pre-Installation Manual.
- The manufacturer's instructions must be followed to provide the support structure to meet requirements listed in the Pre-Installation Manual.
- Customer is responsible for reviewing and approving Gas Key Style and Manufacturer.
- Total weight capacity available for all Stryker and customer supplied accessories, based on weights moments listed in S-SEFRES Pre-Instal Manual.
- Bottom of Stryker mounting plate must be installed at 1JC above finished ceiling. The ceiling height and dimensions shown in drawing are dependent on this requirement.

### Stryker Communications

571 Swann Blvd  
Decorah, IA 52101  
Phone: (563) 382-2911  
Fax: (563) 387-3102  
www.stryker.com

Sales Representative :  
Brian Kugel  
brian.kugel@stryker.com

Project	Customer: WINNESHIER MED CTR	State: Iowa
Qty DECORAH	Equip ID: SFS-2	
Group Name: ORs 3 4	Quote No.: 10179648	Quote Rev No.: 4
Quote Date: 15 Aug 2023	QTY: 2	
Quote Line #: 4	Block #: 1	
DWG No.: 10179648/001		

# WinnMed

Room: ORs 3 4

Anesthesia Boom



## S-Series Standard Equipment Management System

Introducing a new standard in equipment management. With a completely redesigned user interface and a compact, fully customizable system, it has never been easier to manage your services and maneuver your equipment.

PART #	DESCRIPTION		QTY	LIST PRICE	EXT LIST PRICE
SFS-2	S-SERIES, STANDARD FIXED, 2 ROW, 2 ARM		2		
<u>Mounting Details</u>		<u>Shelves</u>	<u>High Voltage Services</u>	<u>Additional Cables</u>	<u>Gas Services</u>
Mounting Plate   Single Common Plate		Shelves   0	20A/125V-3-20R Duplex   1		Gas Manufacturer   Beacon Medical
Ceiling Cover   Standalone			20A/125V Duplex (4 Outlets)   2		Gas Fitting Type   Chematron
Brake System   Electric					Air Gas   1
					Vac Gas   2
<u>MFR Configuration</u>			<u>Low Voltage Services</u>		N2O Gas   1
Front MFR Length   406mm			Blank Plate   1		O2 Gas   2
Rear MFR Length   406mm			3rd Party Data Plate 1G Plate   1		WAGD Gas   1
MFR Controls   Rear Only			Distribution Bd Plate   1		
			COR Lite 4-in-1 Plate   1		
Configuration Total:					

# WinnMed

WinnMed  
Expansion and Renovation  
Decorah, IA 52101  
Furniture Specifications

Issue Date: 3/6/2024

CONTACT: Ben Stevens - CFO  
PHONE NUMBER: 563-387-3109

ITEM NUMBER:	45
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ITEM NAME:	Endoscopic/Surgical Room Hub Base System		
ROOM NUMBER:		QUANTITY:	

## SPECIFICATION INFORMATION

MANUFACTURER: Stryker  
MODEL #: 240200100  
DIMENSIONS:  
DESCRIPTION: Endoscopic/Surgical Room Hub Base System

## FURNITURE & EQUIPMENT IMAGE

Room: Stryker Endoscopy



### Stryker Endoscopy

As a technology leader in minimally invasive surgery, Stryker offers comprehensive solutions to meet the changing needs of the high-tech operating room. We combine voice activation, advanced imaging, and high-definition video technology with a data management system to offer a surgical environment designed to improve patient outcomes. The combination of Stryker's market leading products and first class service has set a new standard in minimally invasive surgery.

PART #	DESCRIPTION	QTY	LIST PRICE	EXT LIST PRICE
0240200100	PKG. CONNECTED OR HUB BASE SYSTEM	5		
0240031300	PKG. 32" 4K OLED SURGICAL DISPLAY	10		
0240099265	PKG. DVI TO HDMI CONVERTER	2		
0240200103	CONNECTED OR HUB DEVICE CONTROL PACKAGE	5		
0240099250	PKG. S-V DECOMPOSITE TO HDMI CONVERTER	2		
0240031051	PKG. 32" 4K SURGICAL DISPLAY COVER	10		
0240200106	CONNECTED OR HUB DICOM PACKAGE	5		
Endoscopy Total:				

# WinnMed

WinnMed  
Expansion and Renovation  
Decorah, IA 52101  
Furniture Specifications

Issue Date: 3/6/2024

CONTACT: Ben Stevens - CFO  
PHONE NUMBER: 563-387-3109

ITEM NUMBER:	46
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ITEM NAME:	Surgical Display		
ROOM NUMBER:		QUANTITY:	

## SPECIFICATION INFORMATION

MANUFACTURER: Stryker  
MODEL #: 240031300  
DIMENSIONS: 32"  
DESCRIPTION: 32" OLED Surgical Display

## FURNITURE & EQUIPMENT IMAGE

Room: Stryker Endoscopy



### Stryker Endoscopy

As a technology leader in minimally invasive surgery, Stryker offers comprehensive solutions to meet the changing needs of the high-tech operating room. We combine voice activation, advanced imaging, and high-definition video technology with a data management system to offer a surgical environment designed to improve patient outcomes. The combination of Stryker's market leading products and first class service has set a new standard in minimally invasive surgery.

PART #	DESCRIPTION	QTY	LIST PRICE	EXT LIST PRICE
0240200100	PKG. CONNECTED OR HUB BASE SYSTEM	5		
0240031300	PKG. 32" 4K OLED SURGICAL DISPLAY	10		
0240099265	PKG. DVI TO HDMI CONVERTER	2		
0240200103	CONNECTED OR HUB DEVICE CONTROL PACKAGE	5		
0240099250	PKG. S-V DECOMPOSITE TO HDMI CONVERTER	2		
0240031051	PKG. 32" 4K SURGICAL DISPLAY COVER	10		
0240200106	CONNECTED OR HUB DICOM PACKAGE	5		
Endoscopy Total:				



# WinnMed

WinnMed  
Expansion and Renovation  
Decorah, IA 52101  
Furniture Specifications

Issue Date: 3/6/2024

CONTACT: Ben Stevens - CFO  
PHONE NUMBER: 563-387-3109

ITEM NUMBER:	47
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ITEM NAME:	Surgical Display Cover		
ROOM NUMBER:		QUANTITY:	

## SPECIFICATION INFORMATION

MANUFACTURER: Stryker  
MODEL #: 240031051  
DIMENSIONS: 32"  
DESCRIPTION: 32" Surgical Display Cover

## FURNITURE & EQUIPMENT IMAGE

Room: Stryker Endoscopy



### Stryker Endoscopy

As a technology leader in minimally invasive surgery, Stryker offers comprehensive solutions to meet the changing needs of the high-tech operating room. We combine voice activation, advanced imaging, and high-definition video technology with a data management system to offer a surgical environment designed to improve patient outcomes. The combination of Stryker's market leading products and first class service has set a new standard in minimally invasive surgery.

PART #	DESCRIPTION	QTY	LIST PRICE	EXT LIST PRICE
0240200100	PKG. CONNECTED OR HUB BASE SYSTEM	5		
0240031300	PKG. 32" 4K OLED SURGICAL DISPLAY	10		
0240099265	PKG. DVI TO HDMI CONVERTER	2		
0240200103	CONNECTED OR HUB DEVICE CONTROL PACKAGE	5		
0240099250	PKG. S-V DECOMPOSITE TO HDMI CONVERTER	2		
0240031051	PKG. 32" 4K SURGICAL DISPLAY COVER	10		
0240200106	CONNECTED OR HUB DICOM PACKAGE	5		
Endoscopy Total:				

# WinnMed

WinnMed  
Expansion and Renovation  
Decorah, IA 52101  
Furniture Specifications

Issue Date: 3/6/2024

CONTACT: Ben Stevens - CFO  
PHONE NUMBER: 563-387-3109

ITEM NUMBER:	48
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ITEM NAME:	DVI to HDMI Converter		
ROOM NUMBER:		QUANTITY:	

## SPECIFICATION INFORMATION

MANUFACTURER: Stryker  
MODEL #: 240099265  
DIMENSIONS:  
DESCRIPTION: DVI to HDMI Converter

## FURNITURE & EQUIPMENT IMAGE

Room: Stryker Endoscopy



### Stryker Endoscopy

As a technology leader in minimally invasive surgery, Stryker offers comprehensive solutions to meet the changing needs of the high-tech operating room. We combine voice activation, advanced imaging, and high-definition video technology with a data management system to offer a surgical environment designed to improve patient outcomes. The combination of Stryker's market leading products and first class service has set a new standard in minimally invasive surgery.

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0240031300	PKG. 32" 4K OLED SURGICAL DISPLAY	10		
0240099265	PKG. DVI TO HDMI CONVERTER	2		
0240200103	CONNECTED OR HUB DEVICE CONTROL PACKAGE	5		
0240099250	PKG. S-V DECOMPOSITE TO HDMI CONVERTER	2		
0240031051	PKG. 32" 4K SURGICAL DISPLAY COVER	10		
0240200106	CONNECTED OR HUB DICOM PACKAGE	5		
Endoscopy Total:				

# WinnMed

WinnMed  
Expansion and Renovation  
Decorah, IA 52101  
Furniture Specifications

Issue Date: 3/6/2024

CONTACT: Ben Stevens - CFO  
PHONE NUMBER: 563-387-3109

ITEM NUMBER:	49
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ITEM NAME:	S-Video/Composite to HDMI Converter		
ROOM NUMBER:		QUANTITY:	

## SPECIFICATION INFORMATION

MANUFACTURER: Stryker  
MODEL #: 240099250  
DIMENSIONS:  
DESCRIPTION: S-Video/Composite to HDMI Converter

## FURNITURE & EQUIPMENT IMAGE

Room: Stryker Endoscopy



### Stryker Endoscopy

As a technology leader in minimally invasive surgery, Stryker offers comprehensive solutions to meet the changing needs of the high-tech operating room. We combine voice activation, advanced imaging, and high-definition video technology with a data management system to offer a surgical environment designed to improve patient outcomes. The combination of Stryker's market leading products and first class service has set a new standard in minimally invasive surgery.

PART #	DESCRIPTION	QTY	LIST PRICE	EXT LIST PRICE
0240200100	PKG. CONNECTED OR HUB BASE SYSTEM	5		
0240031300	PKG. 32" 4K OLED SURGICAL DISPLAY	10		
0240099265	PKG. DVI TO HDMI CONVERTER	2		
0240200103	CONNECTED OR HUB DEVICE CONTROL PACKAGE	5		
0240099250	PKG. S-V DECOMPOSITE TO HDMI CONVERTER	2		
0240031051	PKG. 32" 4K SURGICAL DISPLAY COVER	10		
0240200106	CONNECTED OR HUB DICOM PACKAGE	5		
Endoscopy Total:				

# WinnMed

WinnMed  
Expansion and Renovation  
Decorah, IA 52101  
Furniture Specifications

Issue Date: 3/6/2024

CONTACT: Ben Stevens - CFO  
PHONE NUMBER: 563-387-3109

ITEM NUMBER:	50
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ITEM NAME:	Device Control Package		
ROOM NUMBER:		QUANTITY:	

## SPECIFICATION INFORMATION

MANUFACTURER: Stryker  
MODEL #: 240200103  
DIMENSIONS:  
DESCRIPTION: Endoscopic/Surgical Room Hub Device Control Package

## FURNITURE & EQUIPMENT IMAGE

Room: Stryker Endoscopy



### Stryker Endoscopy

As a technology leader in minimally invasive surgery, Stryker offers comprehensive solutions to meet the changing needs of the high-tech operating room. We combine voice activation, advanced imaging, and high-definition video technology with a data management system to offer a surgical environment designed to improve patient outcomes. The combination of Stryker's market leading products and first class service has set a new standard in minimally invasive surgery.

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0240099265	PKG. DVI TO HDMI CONVERTER	2		
0240200103	CONNECTED OR HUB DEVICE CONTROL PACKAGE	5		
0240099250	PKG. S-V DECOMPOSITE TO HDMI CONVERTER	2		
0240031051	PKG. 32" 4K SURGICAL DISPLAY COVER	10		
0240200106	CONNECTED OR HUB DICOM PACKAGE	5		
Endoscopy Total:				

# WinnMed

WinnMed  
Expansion and Renovation  
Decorah, IA 52101  
Furniture Specifications

Issue Date: 3/6/2024

CONTACT: Ben Stevens - CFO  
PHONE NUMBER: 563-387-3109

ITEM NUMBER:	51
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ITEM NAME:	Endoscopic/Surgical Room Hub Dicom Package		
ROOM NUMBER:		QUANTITY:	

## SPECIFICATION INFORMATION

MANUFACTURER: Stryker  
MODEL #: 240200106  
DIMENSIONS:  
DESCRIPTION: Endoscopic/Surgical Room Hub Dicom Package

## FURNITURE & EQUIPMENT IMAGE

Room: Stryker Endoscopy



### Stryker Endoscopy

As a technology leader in minimally invasive surgery, Stryker offers comprehensive solutions to meet the changing needs of the high-tech operating room. We combine voice activation, advanced imaging, and high-definition video technology with a data management system to offer a surgical environment designed to improve patient outcomes. The combination of Stryker's market leading products and first class service has set a new standard in minimally invasive surgery.

PART #	DESCRIPTION	QTY	LIST PRICE	EXT LIST PRICE
0240200100	PKG. CONNECTED OR HUB BASE SYSTEM	5		
0240031300	PKG. 32" 4K OLED SURGICAL DISPLAY	10		
0240099265	PKG. DVI TO HDMI CONVERTER	2		
0240200103	CONNECTED OR HUB DEVICE CONTROL PACKAGE	5		
0240099250	PKG. S-V DECOMPOSITE TO HDMI CONVERTER	2		
0240031051	PKG. 32" 4K SURGICAL DISPLAY COVER	10		
0240200106	CONNECTED OR HUB DICOM PACKAGE	5		
Endoscopy Total:				

# WinnMed

WinnMed

Issue Date:

3/6/2024

Expansion and Renovation

Decorah, IA 52101

Furniture Specifications

CONTACT:

Ben Stevens - CFO

PHONE NUMBER:

563-387-3109

ITEM NUMBER:	52
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ITEM NAME:	BLANK		
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ROOM NUMBER:		QUANTITY:	
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SPECIFICATION INFORMATION	
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MANUFACTURER:

MODEL #:

DIMENSIONS:

DESCRIPTION:

FURNITURE & EQUIPMENT IMAGE
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# WinnMed

WinnMed

Issue Date:

3/6/2024

Expansion and Renovation

Decorah, IA 52101

Furniture Specifications

CONTACT:

Ben Stevens - CFO

PHONE NUMBER:

563-387-3109

ITEM NUMBER:	53
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ITEM NAME:	BLANK		
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ROOM NUMBER:		QUANTITY:	
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SPECIFICATION INFORMATION	
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MANUFACTURER:

MODEL #:

DIMENSIONS:

DESCRIPTION:

FURNITURE & EQUIPMENT IMAGE
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# WinnMed

WinnMed

Issue Date:

3/6/2024

Expansion and Renovation

Decorah, IA 52101

Furniture Specifications

CONTACT:

Ben Stevens - CFO

PHONE NUMBER:

563-387-3109

ITEM NUMBER:	54
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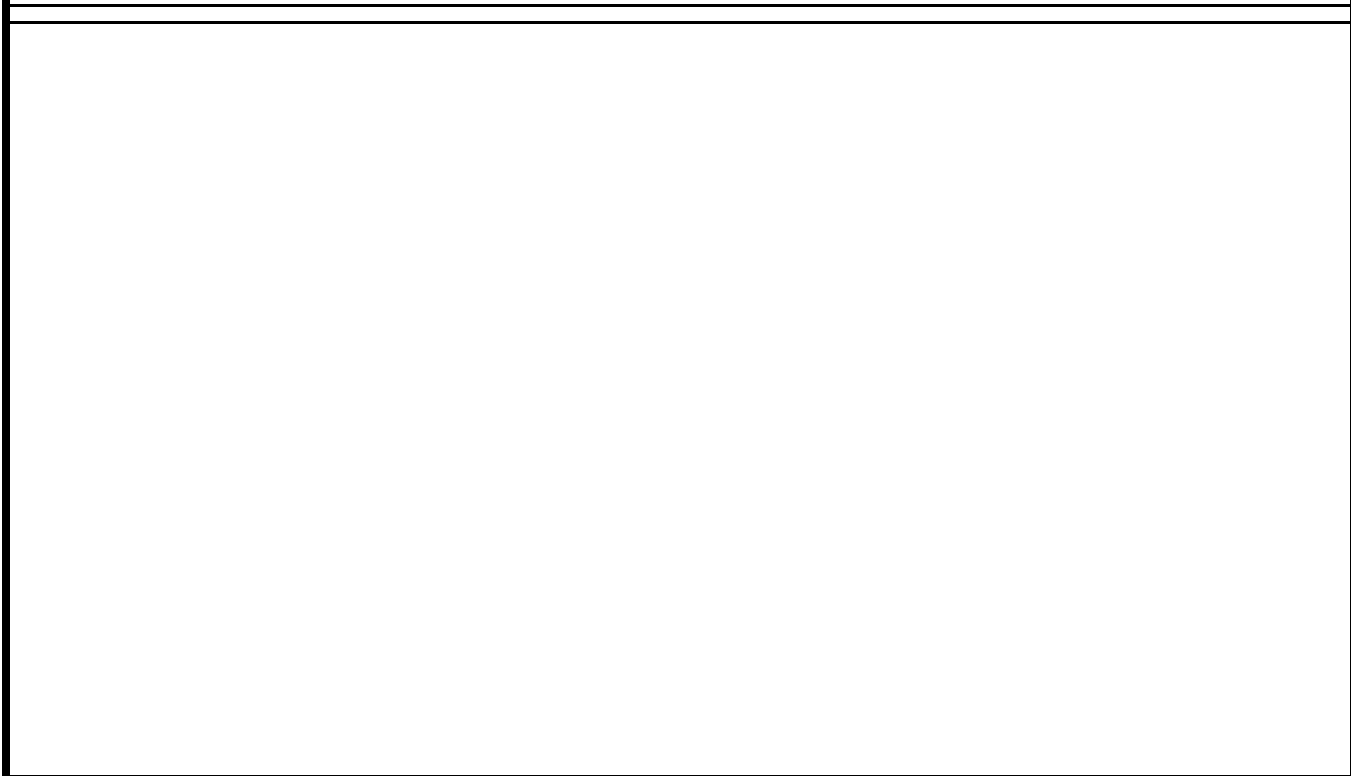
ITEM NAME:	BLANK		
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ROOM NUMBER:		QUANTITY:	
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SPECIFICATION INFORMATION	
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MANUFACTURER:  
MODEL #:  
DIMENSIONS:  
DESCRIPTION:

FURNITURE & EQUIPMENT IMAGE
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# WinnMed

WinnMed

Issue Date:

3/6/2024

Expansion and Renovation

Decorah, IA 52101

Furniture Specifications

CONTACT:

Ben Stevens - CFO

PHONE NUMBER:

563-387-3109

ITEM NUMBER:

55

ITEM NAME:

Infant Security System

ROOM NUMBER:

QUANTITY:

## SPECIFICATION INFORMATION

MANUFACTURER: RF Technologies

MODEL #: Safe Place Infant/Patient Security System


DIMENSIONS:

DESCRIPTION: Infant Security Systems; Server Enterprise software; Staff Alert Panel; (3) Double Door Systems; (12) Alarming Band Receivers w/ Antennas

## FURNITURE & EQUIPMENT IMAGE



# WinnMed

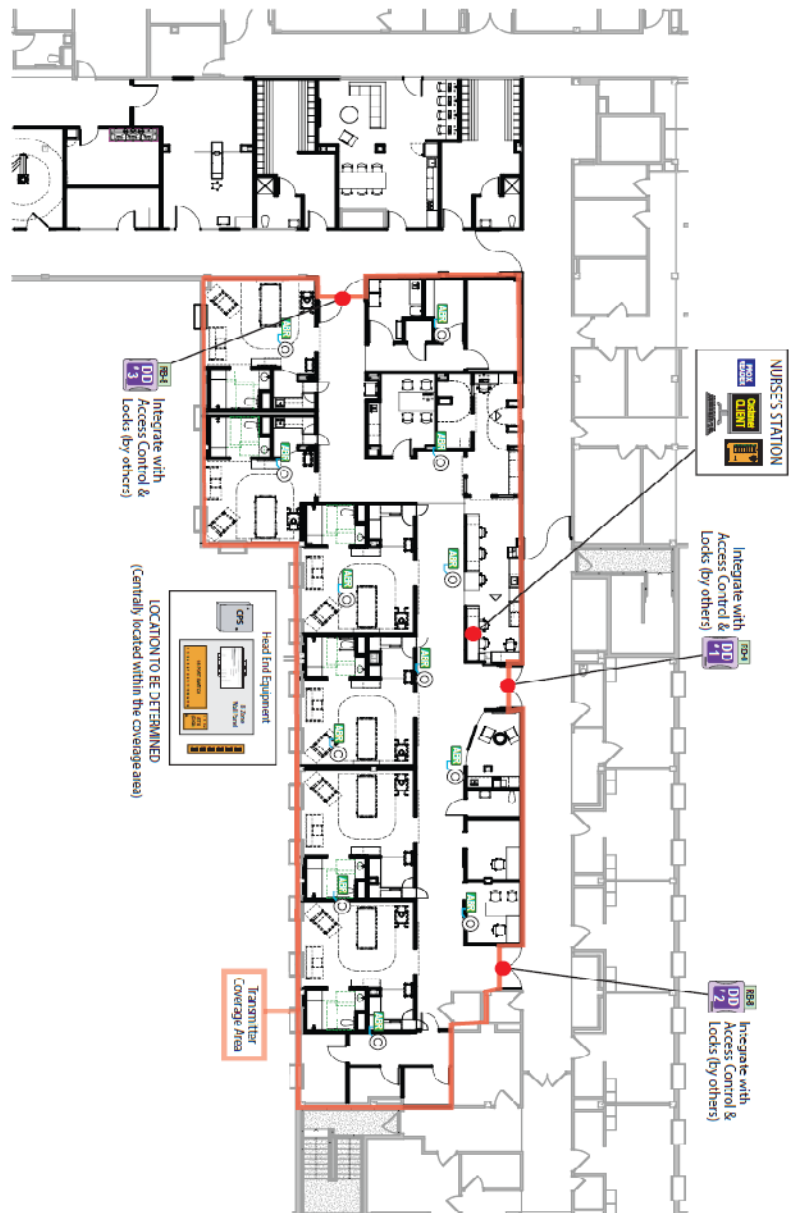

- NOTES:**
1. System will be operating via the Hospital LAN (local area network) facility shall be responsible for providing network drops (or connections) for all network gear and Server/Client computers
  2. For access control integration, we will provide a local relay at the door. A cable (15' in length) will be attached to the relay and coiled in the overhead above each door. Final connection and programming to be provided by others.
  3. Door systems may integrate with existing maglocks that are supplied and maintained by others. Power to the existing maglocks is also supplied by others. RFT only supplies power to our own maglocks. We provide a relay for integration. Final wiring and terminations provided by others.

Virtualized Server  
(on Hospital Hardware/Network)

9450 SYSTEM - DEVICE LEGEND	
	Qty 12
	Qty 3
	Qty 3
	Qty 1
	Qty 1
	Qty 1
	Qty 3
	Qty 1
	Qty 1
	Qty 1
	Qty 1
	Qty 1
Included in the 12-Zone Wall Panel	

Proposal #26583-2

**RF TECHNOLOGIES, INC.**  
3125 N. 11th St.  
Brookfield, WI 53005  
(262) 796-6100 (DND) / 796-9919  
www.rf-tech.com

**Winneshiek Medical Center**  
Decorah, IA  
L&D Department  
Device Layout

System: 9450V Infrared Security  
Date: 09/28/23  
Drawn By: C. Thorpe  
Scale: 1/8" = 1'-0"

# WinnMed



RF TECHNOLOGIES®

## Proposal

### Safe Place® Infant and Pediatric Security Solution L&D Department

Customer ID:  
Proposal #:  
Discount Applied:  
Proposal Date:  
Valid Until:  
Account Manager:

Created For: Brianne Leikvold, Director of Obstetrics  
Winneshiek Medical Center  
901 MONTGOMERY ST  
Decorah, IA 52101  
Phone: (563) 387-3012  
Email: leikvoldb@winmedical.org

### Proposal Details

Quantity		System Components	Unit Price	Amount
<u>Computer Hardware, Software, Licenses &amp; Accessories</u>				
<u>Computer Hardware</u>				
1	0910-0297	Safe Place Enterprise Server Software Virtualization		
<u>System Software</u>				
1	0880-0108	Safe Place Enterprise Server Software		
1	0880-0114	Safe Place Infant Security Module		
1	3000-0366	Safe Place Enterprise Desktop Client Configuration		
<u>System Licenses</u>				
1	9450-9450	Facility Layout PNG		
<u>PC Accessories</u>				
1	0910-0075	Configured USB HID Prox Reader for PC		
<u>Network Gear</u>				
1	9450-9215K	8 Zone Network Wall Panel (CAT-5) Kit		
<u>Cut-Band Solution</u>				
<u>Alarming Band Receivers</u>				
12	9450-0204K	9450 MB Alarming Band Receiver w/Circular Antenna		
<u>T100 Touchpad Exit Controllers</u>				
3	9450-1173-FK	Safe Place Model T100, Double Door, NFPA, Flush Mount (UL)		
<u>Controller Accessory Parts</u>				
3	0290-0033	Relay, Lifesafety Power RB8 Dual 2A, 12VDC/24VDC		
3	0220-0297	Box, Flush Mount, TEC, Existing Construction		
<u>Event Notification</u>				
<u>Staff Alert Panels</u>				
1	9450-1400K	Safe Place 8-Zone Staff Alert Panel, Flush Mt		
<u>Infrastructure</u>				
<u>Central Power Supplies</u>				
1	9450-0555	Central Power Supply, 15VDC 9A, Class II (UL Listed)		
<u>Wire</u>				
2	0100-0029K	Wire, CAT-5e Plenum, Pink 1000 Ft Roll		
2	0100-0030K	Wire, 16/2 Unshielded Plenum, Stranded, 500 ft Kit		
2	0100-0047K	Wire, 16/4 Unshielded Plenum, Stranded, 500 ft Kit		
<u>Supplies &amp; Manuals</u>				
<u>Transmitters</u>				
10	9450-6262-1	Smart Sense Infant Transmitter 262 kHz		
3	3000-0245	Safe Place Smart Sense Plus Banding		
10	0220-0265	Clamp, Smart Sense Infant TX		
2	0900-0006	Cleaning Brush for ICSS Transmitters		
1	9400-0550	Transmitter Storage Case		
1	9450-0050	RFT Transmitter Tester - 66kHz & 262kHz		

# WinnMed

<u>Training/User Guides</u>		
1	0510-0570	Smart Sense Transmitter Quick Reference
1	0510-0572	Transmitter Testing Quick Reference
20	0510-1114	Safe Place Enterprise Users Guide
1	0510-1115	Touchpad Exit Controller Quick Reference
1	0510-1120	Touchpad Exit Controller Administration Guide
1	0510-0164	Door Controller (TEC/DEEAC) Configuration/Program Settings

Supplies & Manuals Total:

<u>Clinical Education</u>		
1	3000-3401	Clinical Education New System Installation Schedule 1

Clinical Education Total:

<u>Installation</u>		
<u>Installation Type</u>		
1	3000-3005	RFT Installation Project
<u>Add-On Services</u>		
1	3000-3004	Project Management
1	0550-0492	Remote Access Configuration
<u>Infection Control</u>		
1	3000-0680	Infection Control, Class I

Installation Total:

Total Price:

\*Estimated Freight:

\*Estimated Tax:

Estimated Total:

\*Customer is responsible for all applicable taxes and freight at time of order

# WinnMed

WinnMed

Issue Date:

3/6/2024

Expansion and Renovation

Decorah, IA 52101

Furniture Specifications

CONTACT:

Ben Stevens - CFO

PHONE NUMBER:

563-387-3109

ITEM NUMBER:	56
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ITEM NAME:	BLANK		
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ROOM NUMBER:		QUANTITY:	
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SPECIFICATION INFORMATION	
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MANUFACTURER:

MODEL #:

DIMENSIONS:

DESCRIPTION:

FURNITURE & EQUIPMENT IMAGE
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# WinnMed

WinnMed

Issue Date:

3/6/2024

Expansion and Renovation

Decorah, IA 52101

Furniture Specifications

CONTACT:

Ben Stevens - CFO

PHONE NUMBER:

563-387-3109

ITEM NUMBER:	57
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ITEM NAME:	BLANK		
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ROOM NUMBER:		QUANTITY:	
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SPECIFICATION INFORMATION	
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MANUFACTURER:

MODEL #:

DIMENSIONS:

DESCRIPTION:

FURNITURE & EQUIPMENT IMAGE
-----------------------------

# WinnMed

WinnMed

Issue Date:

3/6/2024

Expansion and Renovation

Decorah, IA 52101

Furniture Specifications

CONTACT:

Ben Stevens - CFO

PHONE NUMBER:

563-387-3109

ITEM NUMBER:	58
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ITEM NAME:	Clinic Exam Chairs
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ROOM NUMBER:		QUANTITY:	
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## SPECIFICATION INFORMATION

MANUFACTURER: Midmark

MODEL #: MIM626005

DIMENSIONS:

DESCRIPTION: Clinic Exam Chairs; Drawer Heater; Foot and Hand Wired Controls; 650 lbs weight capacity; Active Sensing technology pauses movement when a disrupting impact is detected; One-Touch return to home; 115 VAC, 10 A, 50/60 Hz

## FURNITURE & EQUIPMENT IMAGE



# WinnMed

WinnMed  
Expansion and Renovation  
Decorah, IA 52101  
Furniture Specifications

Issue Date: 3/6/2024

**CONTACT:** Ben Stevens - CFO  
**PHONE NUMBER:** 563-387-3109

ITEM NUMBER:	59
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ITEM NAME:	Clinic Exam Chair Support Rails		
ROOM NUMBER:		QUANTITY:	

SPECIFICATION INFORMATION	
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MANUFACTURER:	Midmark
MODEL #:	MIM9A600002
DIMENSIONS:	
DESCRIPTION:	Clinic Exam Chair Support Rails; 500 lbs capacity; Field Installed

FURNITURE & EQUIPMENT IMAGE
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# WinnMed

WinnMed  
Expansion and Renovation  
Decorah, IA 52101  
Furniture Specifications

Issue Date: 3/6/2024

**CONTACT:** Ben Stevens - CFO  
**PHONE NUMBER:** 563-387-3109

ITEM NUMBER:	60
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ITEM NAME:	Clinic Exam Chair Premium Upholstered Top Upgrade
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ROOM NUMBER:		QUANTITY:	
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SPECIFICATION INFORMATION	
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MANUFACTURER:	Midmark
MODEL #:	MIM0022000814
DIMENSIONS:	
DESCRIPTION:	EXAM CHAIR ACCESSORIES: PREMIUM UPHOLSTERED TOP FOR 626 EXAM CHAIR, 28", STONE

FURNITURE & EQUIPMENT IMAGE
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# WinnMed

WinnMed

Issue Date:

3/6/2024

Expansion and Renovation

Decorah, IA 52101

Furniture Specifications

CONTACT:

Ben Stevens - CFO

PHONE NUMBER:

563-387-3109

ITEM NUMBER:	61
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ITEM NAME:	Clinic Procedure Chair		
ROOM NUMBER:		QUANTITY:	

## SPECIFICATION INFORMATION

MANUFACTURER: Midmark

MODEL #: MIM230001

DIMENSIONS:

DESCRIPTION: Clinic Procedure Chair; Foot & Hand Pedal; Swing Away Instrument Tray; Premium Upholstered Top Upgrade; 450 lbs. weight capacity; 115 VAC, 10 A, 50/60 Hz; LED Exam Light; Vision Block Screen; Articulating Knee Crutches

## FURNITURE & EQUIPMENT IMAGE



# WinnMed



Articulating Knee Crutches



Swing Arm Instrument Tray



Ritter® 253 LED Exam Light



Vision Block Screen



# WinnMed

WinnMed

Issue Date:

3/6/2024

Expansion and Renovation

Decorah, IA 52101

Furniture Specifications

CONTACT:

Ben Stevens - CFO

PHONE NUMBER:

563-387-3109

ITEM NUMBER:	62
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ITEM NAME:	BLANK		
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ROOM NUMBER:		QUANTITY:	
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SPECIFICATION INFORMATION	
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MANUFACTURER:

MODEL #:

DIMENSIONS:

DESCRIPTION:

FURNITURE & EQUIPMENT IMAGE
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# WinnMed

WinnMed

Issue Date:

3/6/2024

Expansion and Renovation

Decorah, IA 52101

Furniture Specifications

CONTACT:

Ben Stevens - CFO

PHONE NUMBER:

563-387-3109

ITEM NUMBER:	63
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ITEM NAME:	BLANK		
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ROOM NUMBER:		QUANTITY:	
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SPECIFICATION INFORMATION	
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MANUFACTURER:

MODEL #:

DIMENSIONS:

DESCRIPTION:

FURNITURE & EQUIPMENT IMAGE
-----------------------------

# WinnMed

WinnMed  
Expansion and Renovation  
Decorah, IA 52101  
Furniture Specifications

Issue Date: 3/6/2024

**CONTACT:** Ben Stevens - CFO  
**PHONE NUMBER:** 563-387-3109


ITEM NUMBER:	64
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ITEM NAME:	Pass-Through Cabinets		
ROOM NUMBER:		QUANTITY:	





## SPECIFICATION INFORMATION

MANUFACTURER: Unicas Medical  
MODEL #: Type E Pass-Through  
DIMENSIONS: 55" W x 60" H x 22.75" D  
DESCRIPTION: Stainless Steel Pass-Through Cabinets; 55" W x 60" H x 22.75" D; Sliding Glass Door  
Surgery Room Side; Door Handle Sterile Hall Side; Accepts Type Unicas Supply Tray System; Includes  
Type EU interior plastic supply panels; Trim Included



## FURNITURE & EQUIPMENT IMAGE

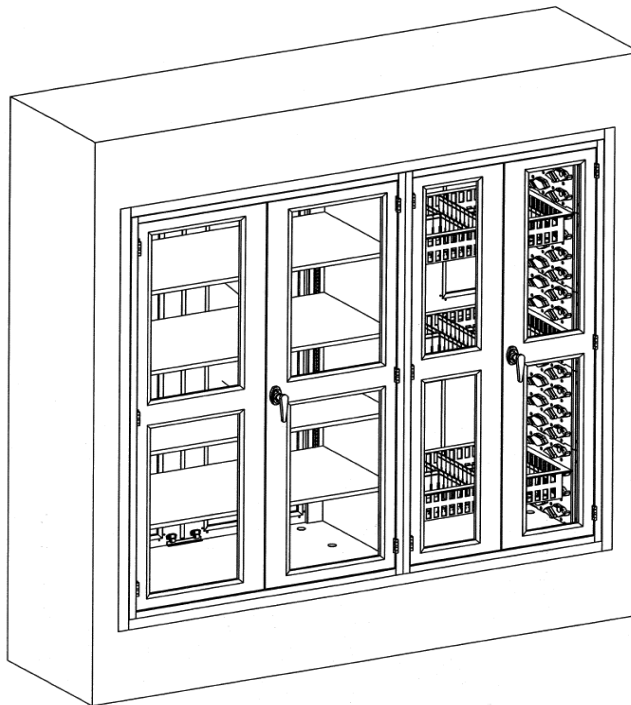

# WinnMed

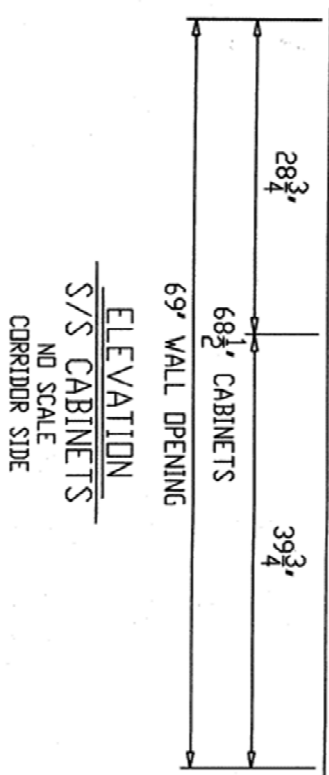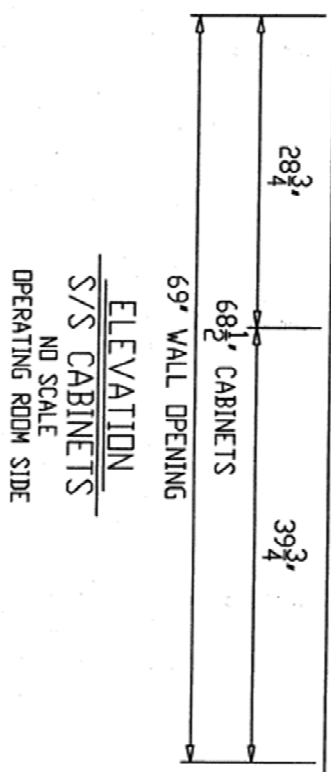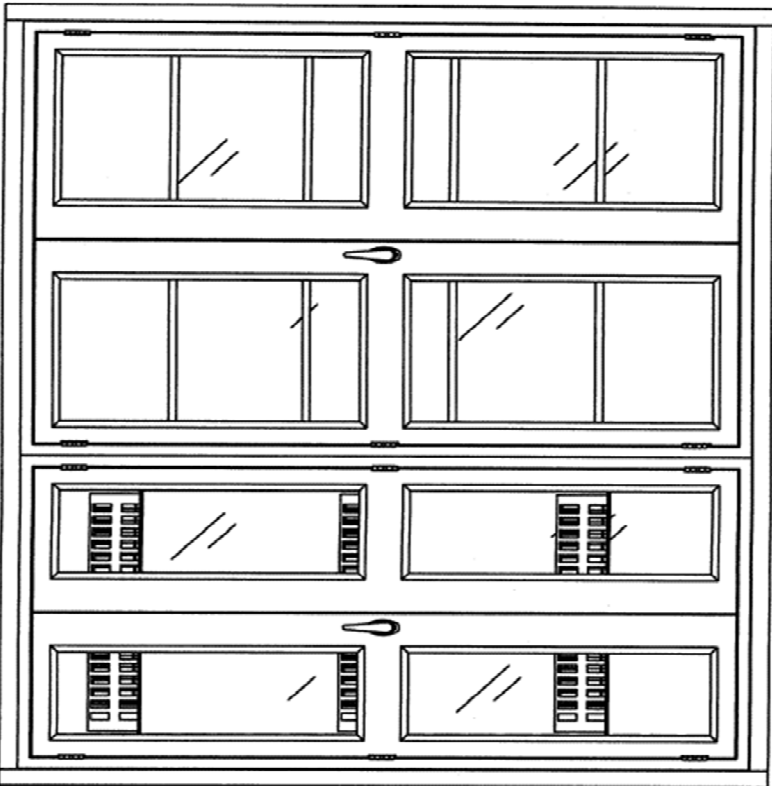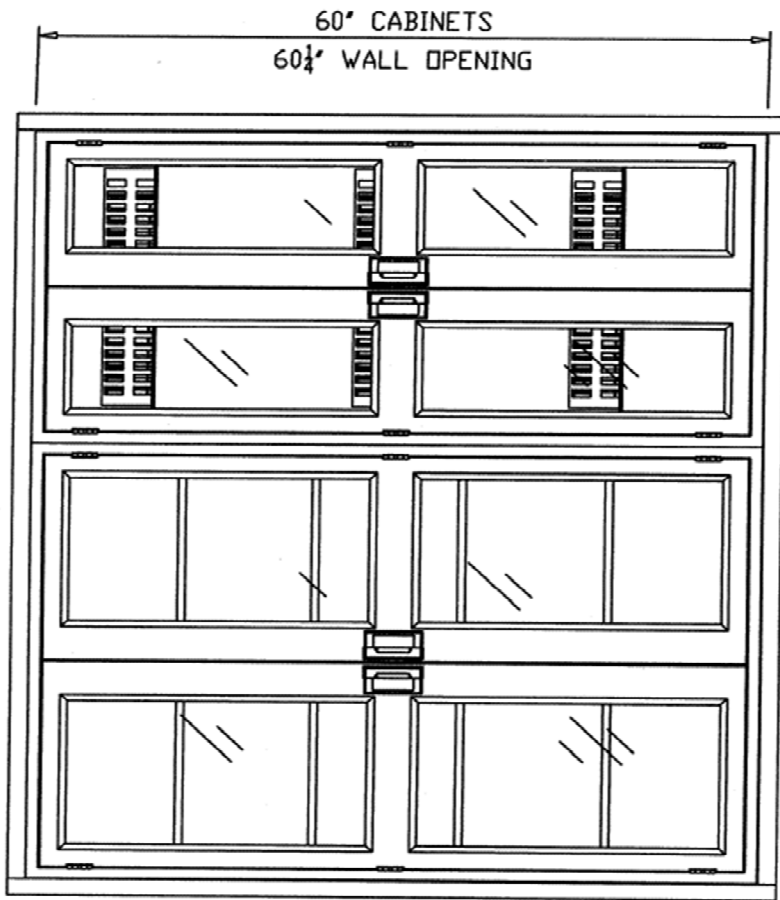

# WinnMed

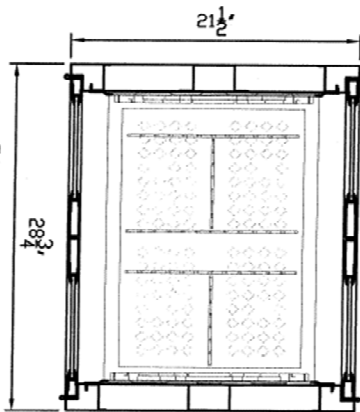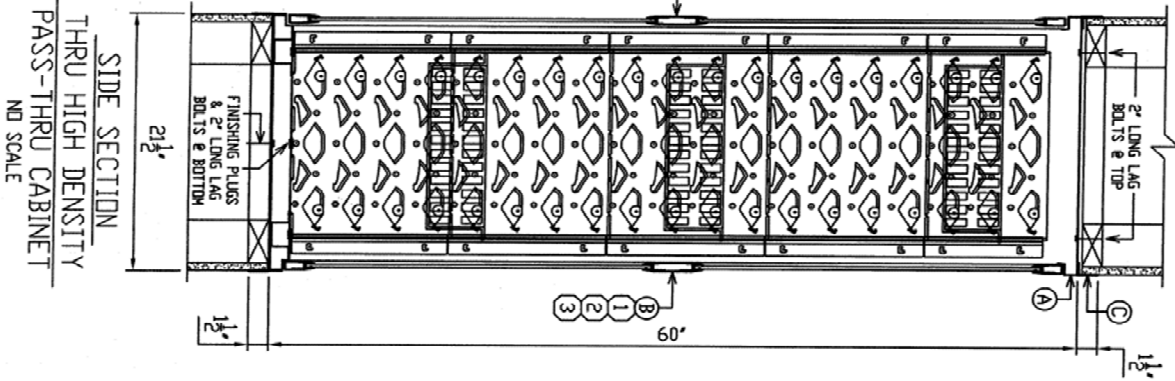

THRU HIGH DENSITY PASS-THRU CABINET  
ND SCALE

COMPONENT LIST	
NO.	DESCRIPTION
1	GUDEN #8000200718
2	FIVE KNUCKLE S/S BUTT HINGE.
3	CH.G. #R63-1012 - S/S RECESSED ROLL, FULL GRP, WITH FRAME BEVELED EDGE.
4	AMEROCK #CM9823-B2G
5	SPRING LOADED NYLON ROLLER CATCH.
6	AUSTIN #20062-1/2
7	1" CHROME PLATED HANDLE.
8	EBERHARD #5611-R
9	ZINC PLATED DEAD BOLT LATCH.
10	CLOSED CELL NEOPRENE GASKET.


LETTER	PART	FABRICATION NOTES
(A)	TRIM	#18 GA. (T-304) S/S WITH A ND. 4
(B)	GLASS	#18 GA. (T-304) S/S EXT. #20 GA. (T-304) S/S INT. WITH 1/4" THICK TEMPERED GLASS.
(C)	DOOR	#18 GA. (T-304) S/S WITH A ND. 4
(D)	NET	BRUSHED SATIN FINISH.

## MATERIAL LIST




# WinnMed

SIDE SECTION  
THRU STANDARD  
PASS-THRU CABINET  
NO SCALE

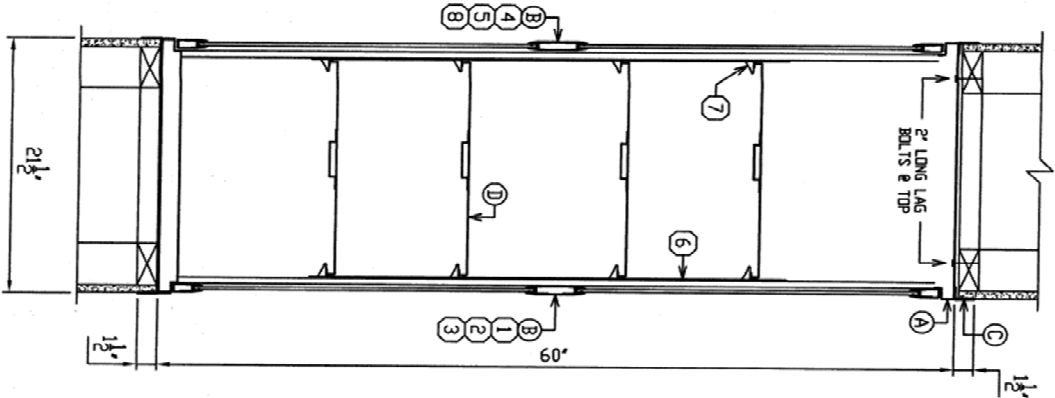

PLAN SECTION  
THRU STD PASS-THRU CABINET  
NO SCALE

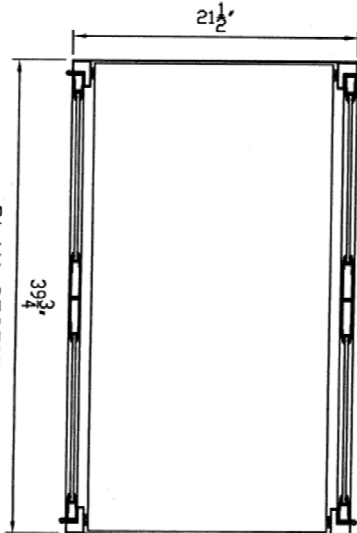


## COMPONENT LIST

NO.	QTY.	DESCRIPTION
1	-	GUDEN #8000200718
2	-	FIVE KNUCKLE S/S BUTT HINGE.
3	-	CHG. #P63-1012 - S/S RECESSED PULL, FULL GRIP, WITH FRAME BEVELED EDGE.
4	-	AMERDOCK #CW9823-B2G
5	-	SPRING LOADED NYLON ROLLER CATCH.
6	-	AUSTIN #20062-1/2
7	-	1" CHROME PLATED HANDLE.
8	-	EBERHARD #5611-R
9	-	ZINC PLATED DEAD BOLT LATCH
10	-	CHG. #T21-1024
11	-	KEYHOLE TYPE PILASTER.
12	-	CHG. #T30-5030
13	-	S/S SNAP-IN SHELF SUPPORTS.
14	-	CLOSED CELL NEOPRENE GASKET.

LETTER	PART	FABRICATION NOTES
1	REMOV	#18 GA. (T-304) S/S WITH A NO. 4
2	ADJ.	BRUSHED SATIN FINISH, REINFORCED
3	SHELF	WITH #18 GA. S/S HAT SECTIONS.
4	TRIM	#18 GA. (T-304) S/S WITH A NO. 4
5	BRUSHED SATIN FINISH.	
6	GLASS	#18 GA. (T-304) S/S EXT. #20 GA.
7	DOOR	(T-304) S/S INT. WITH 1/4" THICK
8	TEMPERED GLASS.	
9	CAB	#18 GA. (T-304) S/S WITH A NO. 4
10	NET	BRUSHED SATIN FINISH.


## MATERIAL LIST

# WinnMed

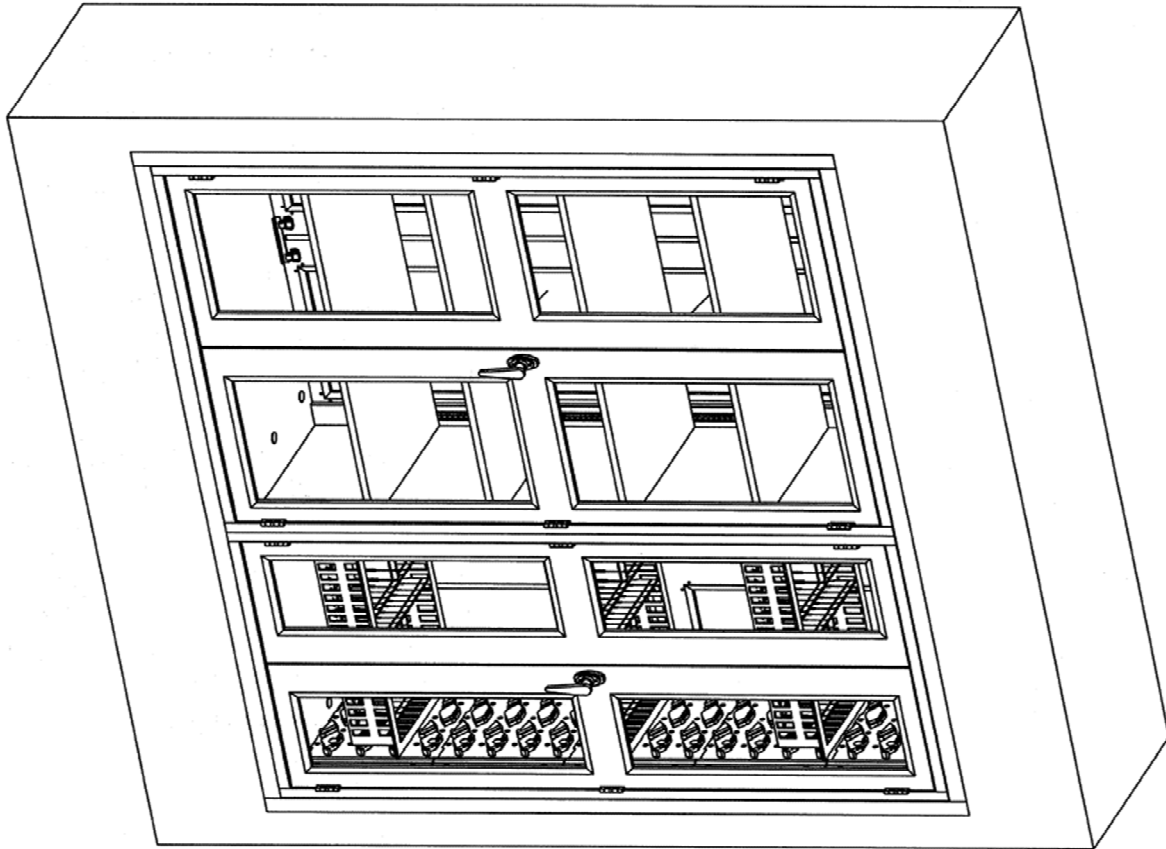

ISOMETRIC  
S/S CABINETS  
(8) SETS REQUIRED  
CORRIDOR ROOM SIDE

# WinnMed

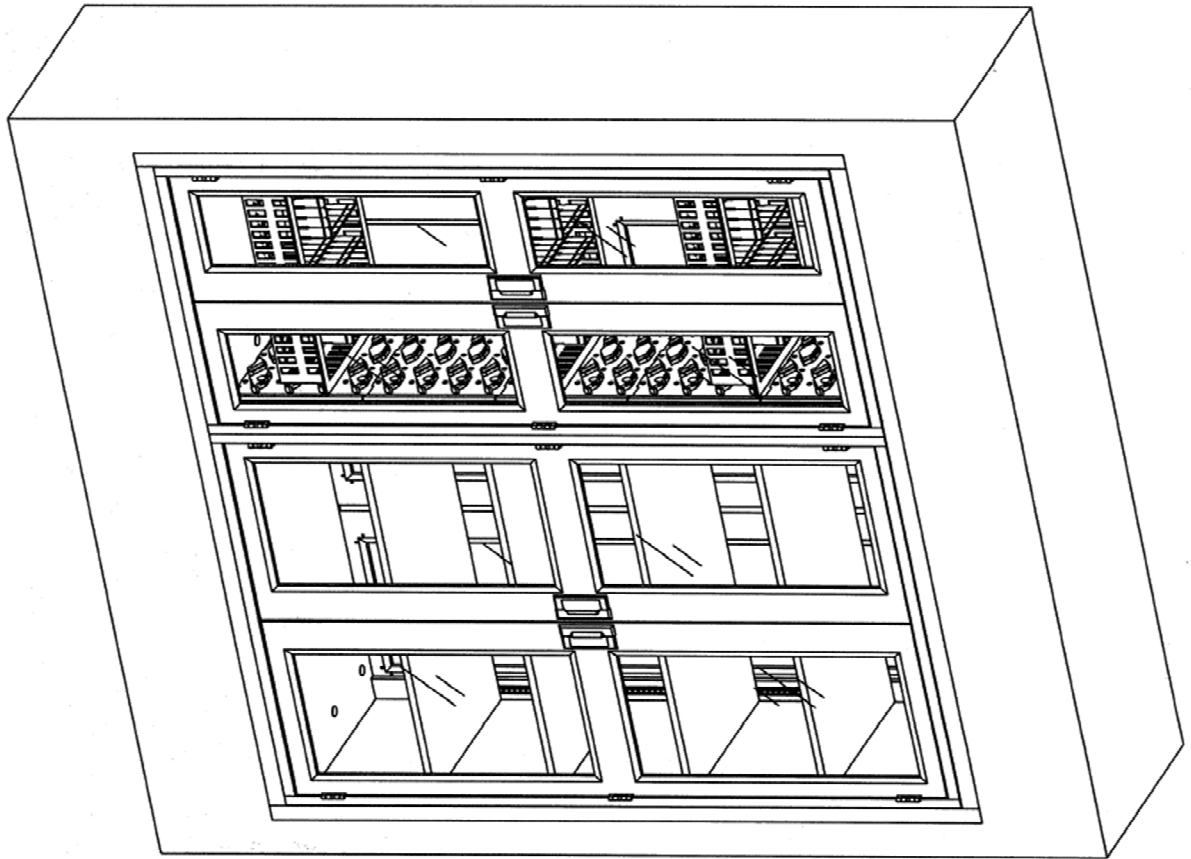

ISOMETRIC  
S/S CABINETS  
(8) SETS REQUIRED  
OPERATING ROOM SIDE

# WinnMed

WinnMed

Issue Date:

3/6/2024

Expansion and Renovation

Decorah, IA 52101

Furniture Specifications

CONTACT:

Ben Stevens - CFO

PHONE NUMBER:

563-387-3109

ITEM NUMBER:	65
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ITEM NAME:	BLANK		
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ROOM NUMBER:		QUANTITY:	
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SPECIFICATION INFORMATION	
---------------------------	--

MANUFACTURER:

MODEL #:

DIMENSIONS:

DESCRIPTION:

FURNITURE & EQUIPMENT IMAGE
-----------------------------

# WinnMed

WinnMed

Issue Date:

3/6/2024

Expansion and Renovation

Decorah, IA 52101

Furniture Specifications

CONTACT:

Ben Stevens - CFO

PHONE NUMBER:

563-387-3109

ITEM NUMBER:	66
--------------	----

ITEM NAME:	Pass-Through Blanket & Fluid Warmer		
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ROOM NUMBER:		QUANTITY:	
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## SPECIFICATION INFORMATION

MANUFACTURER: Steris

MODEL #: CB4721003001

DIMENSIONS: 24" W x 58 3/4" H x 18" D


DESCRIPTION: Pass-Through Blanket/Fluid warmer; glass doors; 120 VAC, 50/60 Hz, 1-Phase; 14 Amp, 1680 Watts; Stainless Steel Trim by others; Independent Heating Controls for both compartments LED display; 90-160 degree range with overtemperature visual/audible alarm; Slope Top; Sub Base; End Panels

## FURNITURE & EQUIPMENT IMAGE



# WinnMed

## WALL MOUNTED - DOUBLE WALL CONDITION

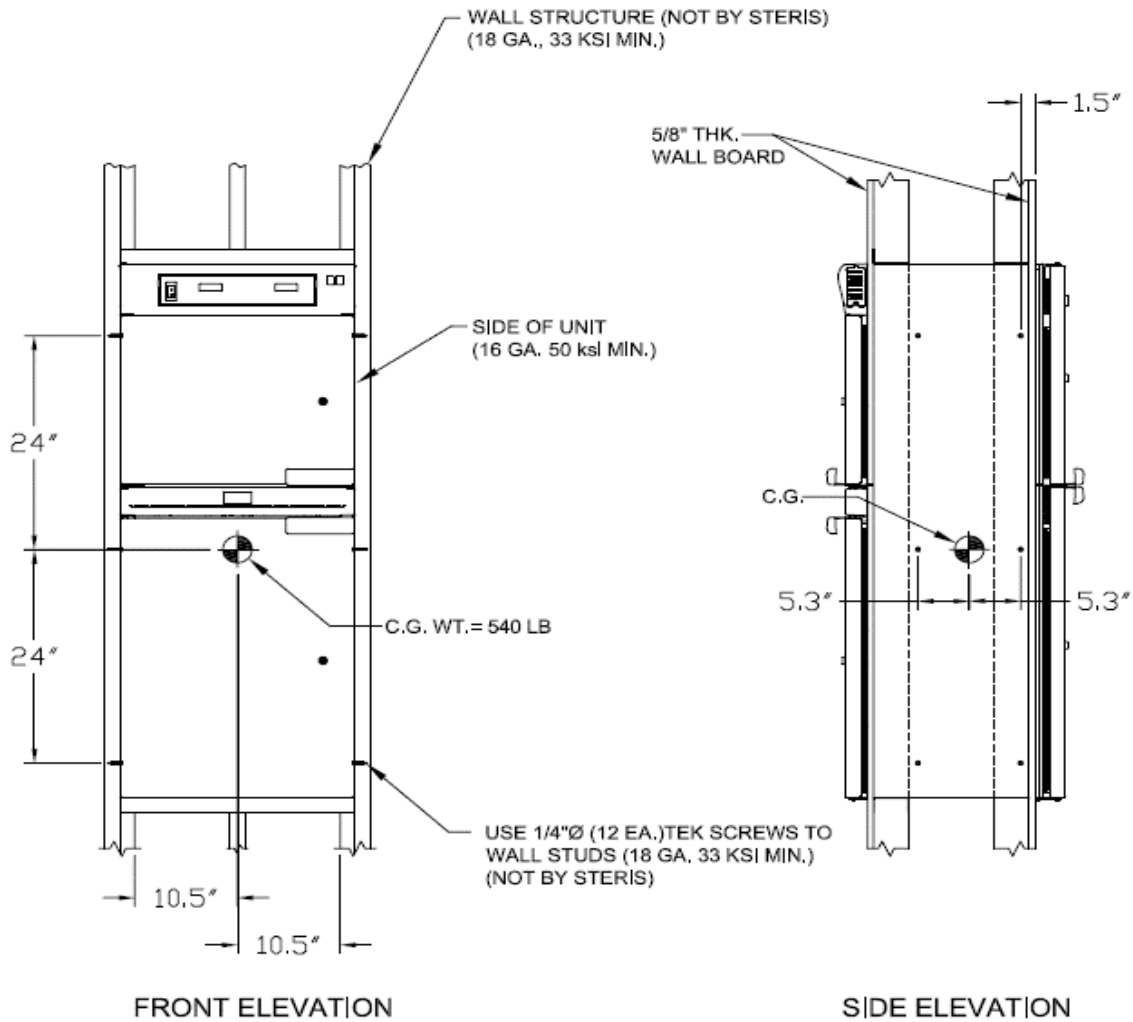

FOR ADDITIONAL SEISMIC INFORMATION AND CALCULATIONS SEE DRAWING 083280-399

ALL DIMENSIONS ARE IN INCHES  
ALSO REFER TO GENERAL NOTES  
APPLICABLE TO EQUIPMENT DRAWINGS

**STERIS**



STERIS Corporation  
Mentor, OH

### PASS-THRU WARMING CABINET O.R. CONSOLE

ACCOUNT NAME

ACCOUNT LOCATION


FILE NAME

PRINTED DATE

SHEET **1 OF 2**

# WinnMed

## WALL MOUNTED - SINGLE WALL CONDITION

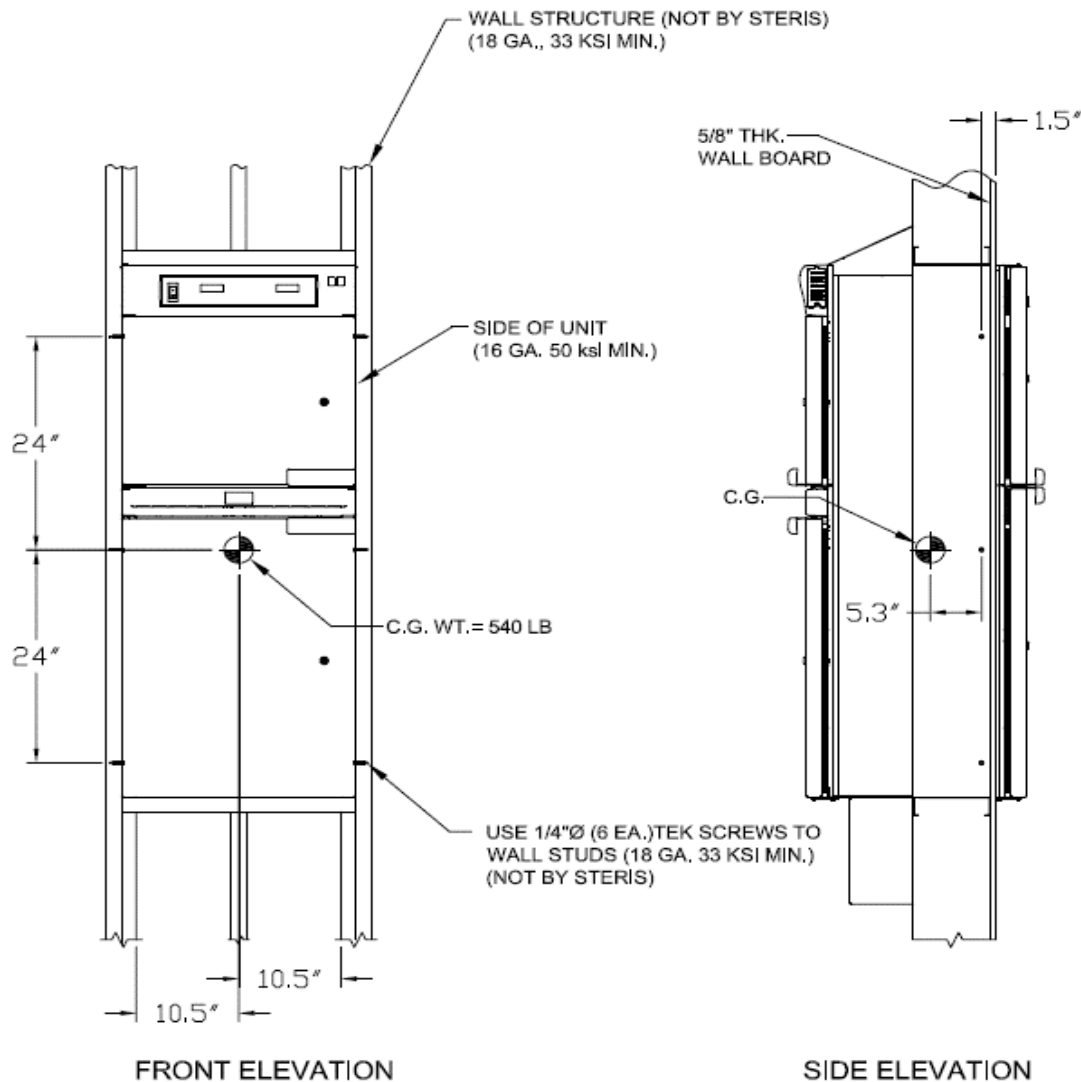

ALL DIMENSIONS ARE IN INCHES  
ALSO REFER TO GENERAL NOTES  
APPLICABLE TO EQUIPMENT DRAWINGS

**STERIS**



STERIS Corporation  
Mentor, OH

**PASS-THRU WARMING CABINET  
O.R. CONSOLE**

ACCOUNT NAME

ACCOUNT LOCATION

FILE NAME

PRINTED DATE

SHEET **2 OF 2**

# WinnMed

WinnMed

Issue Date:

3/6/2024

Expansion and Renovation

Decorah, IA 52101

Furniture Specifications

CONTACT:

Ben Stevens - CFO

PHONE NUMBER:

563-387-3109

ITEM NUMBER:	67
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ITEM NAME:	Surgery Scrub Sink		
------------	--------------------	--	--

ROOM NUMBER:		QUANTITY:	
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SPECIFICATION INFORMATION	
---------------------------	--

MANUFACTURER: Steris

MODEL #: CD122303

DIMENSIONS: 64" W x 27.5" D x 51.5" H

DESCRIPTION: Surgery Scrub Sink; 2- Station; Infared Faucet System; Stainless Steel;


FURNITURE & EQUIPMENT IMAGE
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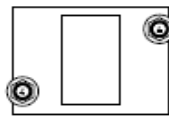
# WinnMed

CAD DWG. DATE 01-07-15 DRAWN BY DWT CHECKED BY EE ECA 50137 REV. DATE 01-07-15 REV. NO. 0 DWG. NO. 125399-216



**FRONT  
ELEVATION**

**SIDE  
ELEVATION**

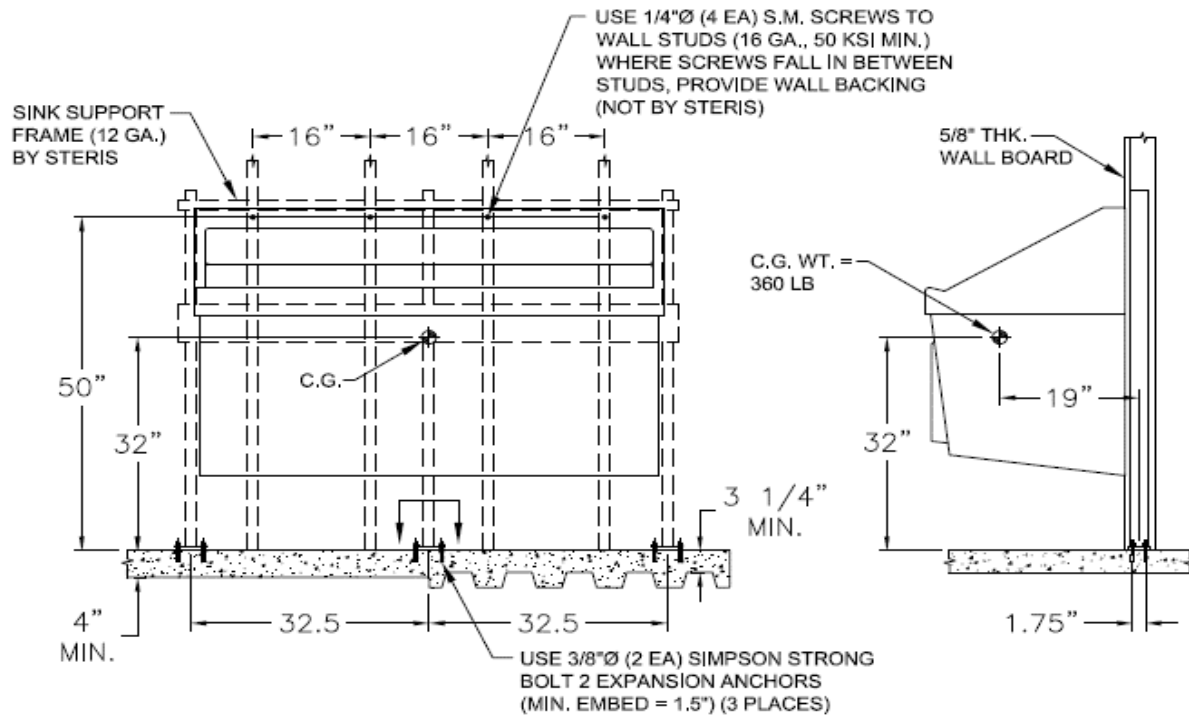

VIEW AT ARROWS

FOR ADDITIONAL SEISMIC INFORMATION AND CALCULATIONS SEE DRAWING 083280-367

ALL DIMENSIONS ARE IN INCHES  
ALSO REFER TO GENERAL NOTES  
APPLICABLE TO EQUIPMENT DRAWINGS

**STERIS**



STERIS Corporation  
Mentor, OH

**SCRUB SINK  
DOUBLE**

ACCOUNT NAME

ACCOUNT LOCATION

FILE NAME


PRINTED DATE

SHEET

**1 OF 3**

# WinnMed

CAD DWG DATE 01-07-15 DRAWN BY DWT CHECKED BY EE ECA 50137 REV. DATE 01-07-15 REV. NO. 0 DWG. NO. 128382-216

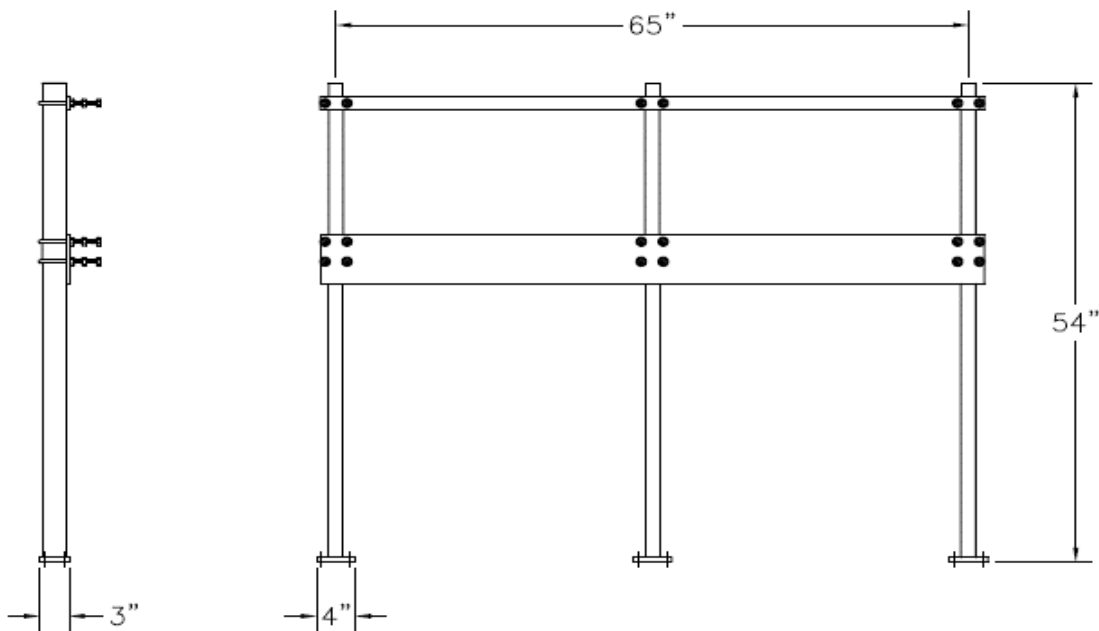

SINK SUPPORT FRAME  
617106-851

ALL DIMENSIONS ARE IN INCHES  
ALSO REFER TO GENERAL NOTES  
APPLICABLE TO EQUIPMENT DRAWINGS

**STERIS®**



STERIS Corporation  
Mentor, OH

SCRUB SINK  
DOUBLE

ACCOUNT NAME

ACCOUNT LOCATION



FILE NAME

PRINTED DATE

SHEET **2 OF 3**

# WinnMed

CAD DWG. DATE 01-07-15 DRAWN BY DWI CHECKED BY EE ECA 50137 REV. DATE 01-07-15 REV. NO. 0 DWG. NO. 129388-216

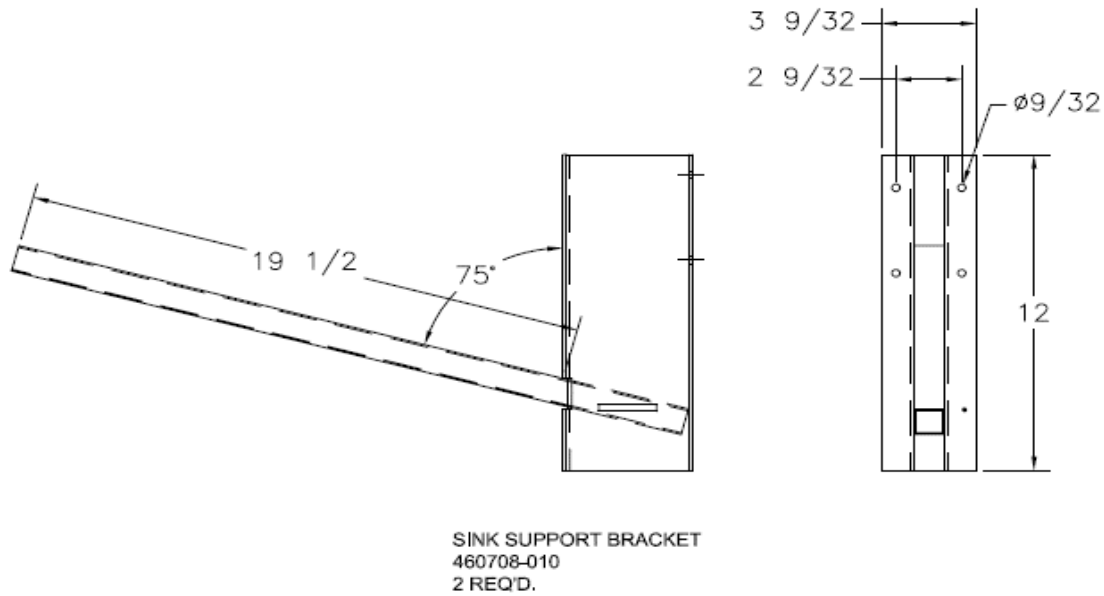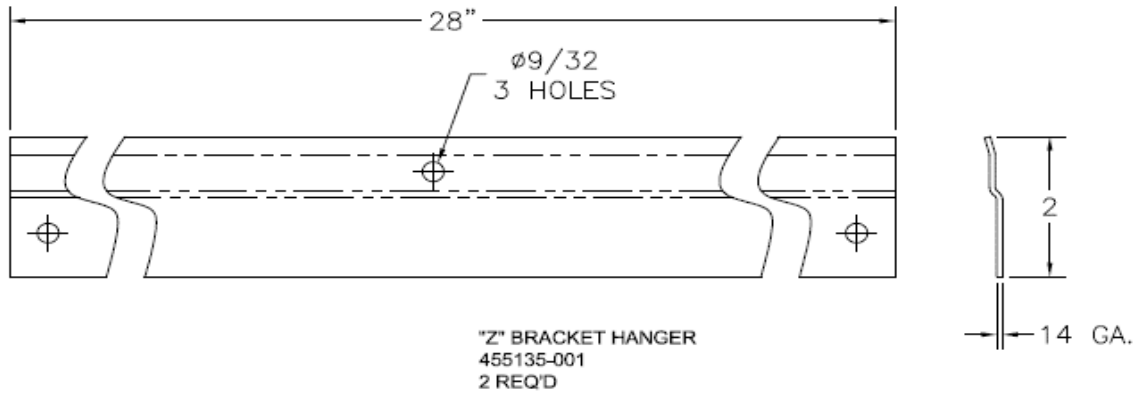

ALL DIMENSIONS ARE IN INCHES  
ALSO REFER TO GENERAL NOTES  
APPLICABLE TO EQUIPMENT DRAWINGS

**STERIS**



STERIS Corporation  
Mentor, OH

**SCRUB SINK  
DOUBLE**

ACCOUNT NAME

ACCOUNT LOCATION

FILE NAME

PRINTED DATE

SHEET

**3 OF 3**

# WinnMed



## AMSCO® FLEXMATIC® SCRUB STATION

### APPLICATION

The AMSCO Flexmatic Scrub Station is used for preoperative surgical scrubbing of hands and arms. Water temperature is automatically maintained by a thermostatically controlled mixing valve. Options include an infra-red water sensor, which detects when hands are under the faucet and turns water on and off automatically, or a digital timer, which displays time elapsed from start of water flow, an eye wash fixture, which extends faucet use to an eye wash station and a laminar flow faucet head, which delivers a constant stream of water.

### DESCRIPTION

The AMSCO Flexmatic Scrub Station is of all stainless-steel construction. It consists of a washing compartment, controls, and mounting devices. The Flexmatic is available with either one, two, or three scrub stations (as specified). STERIS furnishes all components necessary to obtain a complete working unit, ready for (but not including) installation and connection to building utility service lines. Installation may be purchased separately.

### FEATURES

**Washing compartment** is continuous even if a multiple-station unit is specified. Each station of the washing compartment includes a centrally located gooseneck spout assembly.

The spout assembly with rose spray head provides carefully controlled water-spray coverage. The rose spray head is removable for cleaning. The bottom of the compartment is formed to reduce splashing and to flush soil away from the user. The underside of the compartment is sound-deadened.

The compartment, including backsplash, is welded 16 gauge stainless steel. It is 19-1/4" (489 mm) deep x 10-1/2" (267 mm) high with coved inside corners. The width is 29, 61 or 93" (737, 1549 or 2362 mm)



Single Station with Infra-Red Water Valve Sensor shown.  
(Typical only - some details may vary.)

depending on number of stations selected. The backsplash extends the full width of the unit.

Each station (except unit with infra-red sensor) has one **knee-operated control** to start and stop water flow. Pressing then releasing the knee panel labeled WATER opens a water valve. Closing the water valve is accomplished by again pressing then releasing the knee panel.

**Thermostatically controlled mixing valve** provides selection of water temperature up to 115°F (46°C) at each station. The mixing valve quickly compensates for temperature fluctuations induced by water temperature and pressure changes. If the water temperature rises above 115°F (46°C), an anti-scald feature automatically shuts off the flow of hot water. The mixing valve also features heavy, cast-brass construction, and chromium plated operating handle.

**Mounting brackets** are furnished for securing the station to a wall.

### The Selections Checked Below Apply To This Equipment

#### STATION SIZES - W x D x H

- ☐ One Station - 32 x 27-9/32 x 51-1/2"
- ☐ Two Station - 64 x 27-9/32 x 51-1/2"
- ☐ Three Station - 96 x 27-9/32 x 51-1/2"

#### OPTIONS

- ☐ Infra-Red Water Control Sensor
- ☐ Digital Timer on Backsplash
- ☐ Eye Wash Fixture
- ☐ Laminar Flow Faucet Head

#### FIELD UPGRADEABLE OPTION

- ☐ Knee Operated Internal Soap Dispenser  
(Special Sales Quotation [SSQ] required to order)

#### ACCESSORIES

- ☐ Soap Dispenser - Quantity \_\_\_\_\_
- ☐ Divider Screen - Quantity \_\_\_\_\_
- ☐ Chair Carrier
  - ☐ for use with Single Sink
  - ☐ for use with Double Sink
  - ☐ for use with Triple Sink

Item \_\_\_\_\_

Location(s) \_\_\_\_\_

SD240 (01/01/19)

# WinnMed

## STANDARDS

- **FDA Good Manufacturing Practices Regulations 21CFR820**, for Medical Devices.
- **Underwriters Laboratories (UL) Standard 61010-1, 2nd Edition: 2004**, as certified by ETL Testing Laboratories, Inc.
- **Standard CSA-C22.2, No. 61010-1: 2004, Issued: 2004/07/12, 2nd Edition**, as certified by ETL Testing Laboratories, Inc.

## CONSTRUCTION

Plumbing hardware includes chromium-plated brass strainer with gasket, tailpiece, and nut. The plumbing and mounting brackets are concealed by 18 gauge stainless-steel skirt assembly. Exposed surfaces are glass beaded to a matte finish.

The washing compartment is constructed of 16 gauge stainless steel; exposed surfaces are glass beaded to a matte finish.

Stainless steel conforms to ASTM Specification A240 for type 201 and 304.

## OPTIONAL FEATURES

**Infra-Red Sensor.** Sensor can be provided to turn water on and off automatically when hands are under the faucet.

**Digital Timer.** Each station can be equipped with a timer that begins timing when water flow starts. Timer continues to run until the water flow stops. Several seconds after stopping, the display automatically switches off.

**Eye Wash Fixture.** This attachment extends faucet use to an eye wash station.

*NOTE: Faucet-mounted eye wash stations (regardless of manufacturer) require two motions to operate (turn water on, pull knob) and thus do not meet the provisions of ANSI Z358.1-2004.*

**Laminar Flow Faucet Head.** Each station can be equipped with an alternative laminar flow faucet head. Laminar flow faucet head delivers a consistent (non-rose spray) stream of water that has a nonsplash characteristic.

## FIELD UPGRADEABLE OPTION

**Knee Operated Internal Soap Dispenser.** Each time the knee panel labeled SOAP is pressed then released, approximately 2 cc of soap is pumped out of the soap dispenser spout. A shelf is provided under the washing compartment for a 1-gallon (3.78-liter) container of soap. These knee panels can be either opened or removed when components under washing compartment have to be serviced. (SSQ required to order.)

## ACCESSORIES

**Foot operated soap dispenser** can be mounted directly to the wall above each station, allowing for easy access to change out the container when empty. Each dispenser comes with a one quart container of Bactoshield® Surgical Hand Scrub which

screws directly to the dispenser. Each time the foot pedal is pressed, approximately 1.5 – 2 cc of detergent is pumped out of the soap dispenser spout. A special air intake feature prevents dripping after use. The unique valving prevents air from the foot pedal from coming in contact with the soap.

**Divider Screen** (constructed of Plexiglas®) is available to divide two- and three-station units for reducing splash and aerosol contamination between adjacent stations. One screen is recommended for a two-station unit, and two screens for a three-station unit.<sup>1</sup>

**Chair Carrier** supports the hanging weight of a scrub sink if the wall is not properly reinforced.

## PREVENTIVE MAINTENANCE

A global network of skilled service specialists can provide periodic inspections and adjustments to help ensure low-cost peak performance. STERIS representatives can provide information regarding annual maintenance agreements.

## ENGINEERING DATA

Shipping Weight:

- » One station – 175 lbs (80 kg)
- » Two stations – 295 lbs (134 kg)
- » Three stations – 420 lbs (191 kg)

## NOTES

1. Pipe sizes shown indicate terminal outlets only. Building service lines (not provided by STERIS) must supply the specified pressures and flow rates.
2. If the wall is not properly reinforced to support the hanging weight of a scrub sink, STERIS recommends the use of chair carriers to ensure proper sink support.

## UTILITY REQUIREMENTS

### Cold Water

1/2" NPT; 20-50 psig (138-345 kPa) dynamic.

### Hot Water

1/2" NPT; 120-140°F (49-60°C),  
20-50 psig (138-345 kPa) static.

### Drain

1-1/2" OD.

### Electricity

Single, double, or triple sink with manual timer/clock, infrared water valve sensor and/or infrared wash sensor options (80VA transformer):

120V, 1.2A, 50/60 Hz, 0.144KW, 1Ø

220-240V, 0.6A, 50/60 Hz, 0.144KW, 1Ø

Triple sink with timer/clock, infrared water valve sensor and infrared wash sensor options (130VA transformer):

120V, 1.6A, 50/60 Hz, 0.192KW, 1Ø

220-240V, 0.8A, 50/60 Hz, 0.192KW, 1Ø

1. Plexiglas® is a registered trademark of Altuglas International

# WinnMed

WinnMed

Issue Date:

3/6/2024

Expansion and Renovation

Decorah, IA 52101

Furniture Specifications

CONTACT:

Ben Stevens - CFO

PHONE NUMBER:

563-387-3109

ITEM NUMBER:	68
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ITEM NAME:	BLANK		
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ROOM NUMBER:		QUANTITY:	
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SPECIFICATION INFORMATION	
---------------------------	--

MANUFACTURER:

MODEL #:

DIMENSIONS:

DESCRIPTION:

FURNITURE & EQUIPMENT IMAGE
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# WinnMed

WinnMed

Issue Date:

3/6/2024

Expansion and Renovation

Decorah, IA 52101

Furniture Specifications

CONTACT:

Ben Stevens - CFO

PHONE NUMBER:

563-387-3109

ITEM NUMBER:	69
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ITEM NAME:	BLANK		
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ROOM NUMBER:		QUANTITY:	
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SPECIFICATION INFORMATION	
---------------------------	--

MANUFACTURER:

MODEL #:

DIMENSIONS:

DESCRIPTION:

FURNITURE & EQUIPMENT IMAGE
-----------------------------

# WinnMed

WinnMed

Issue Date:

3/6/2024

Expansion and Renovation

Decorah, IA 52101

Furniture Specifications

CONTACT:

Ben Stevens - CFO

PHONE NUMBER:

563-387-3109

ITEM NUMBER:	70
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ITEM NAME:	Ceiling Mounted Patient Lift		
ROOM NUMBER:		QUANTITY:	

## SPECIFICATION INFORMATION



MANUFACTURER: ARJO  
MODEL #: Max Sky 2  
DIMENSIONS:  
DESCRIPTION: Ceiling Mounted Patient Lift; 600 lbs capacity

## FURNITURE & EQUIPMENT IMAGE





# WinnMed

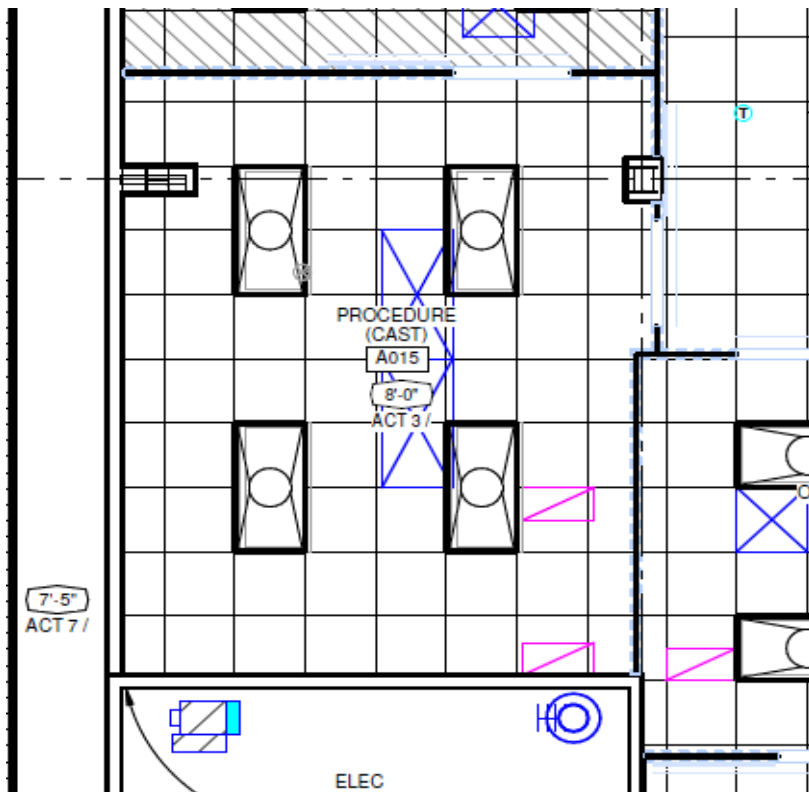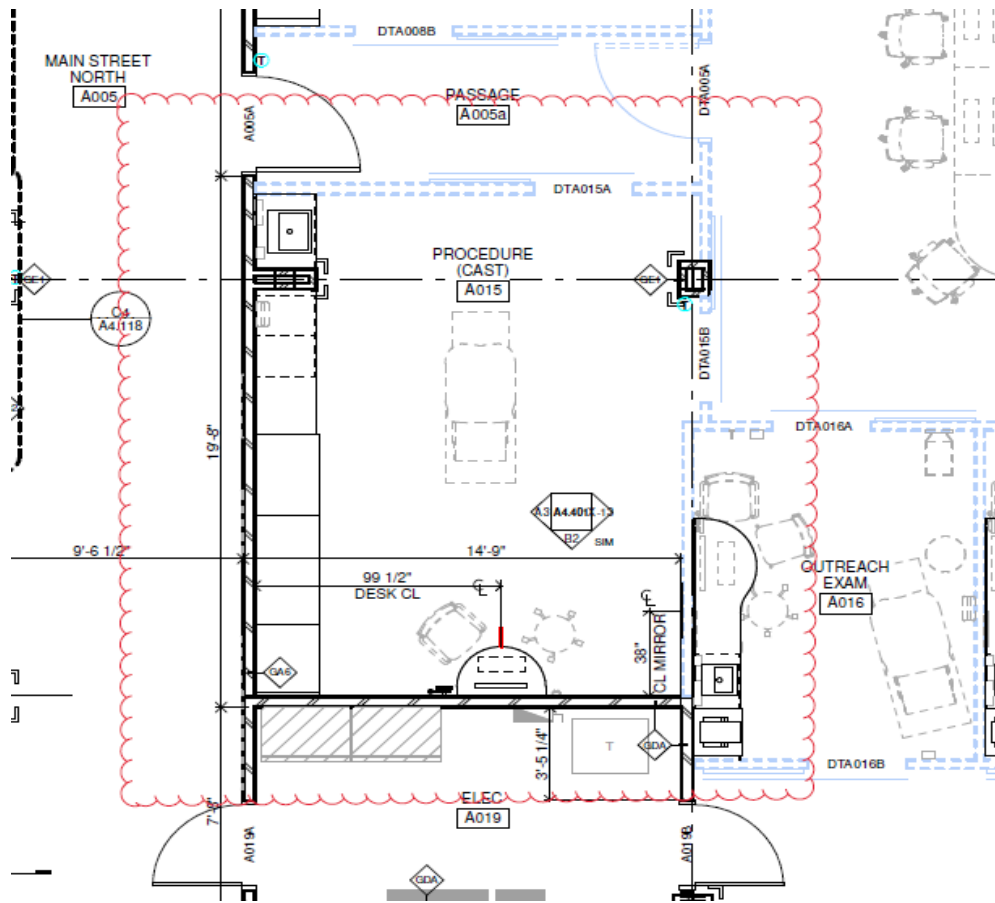

IMPORTANT NOTES

1. The ceiling minimum structure capacity must be able to support the load specified on the installation drawing.
2. Electrical power source outlet already available by the facility at a maximum distance of 3 meters from charging station.
3. Any obstructions such as vents, pipes, lights and sprinklers that could possibly be in the path of the ceiling lifts to be removed or relocated by the facility prior to installation.
4. Modifications of door headers by the facility.
5. Arjo reserves the right to slightly modify the track layout if necessary.
6. See the "Agreed Conditions for the Installation of Ceiling Lifts" document included with this quote for important installation details.
7. Arjo will not be held responsible for any damages, inconvenience, resulting from hitting any non visible conduits during our installation process.
8. Signed drawings are required prior to ordering and installation of ceiling lifts. This signature of each drawings confirms agreement of all the conditions listed above.


MY SIGNATURE BELOW VERIFIES THAT I HAVE:

Reviewed all 5 pages, with a total quantity of 1 rooms, for the approbation of layout for each room and the approbation of structure for each room. I verify that the answers below are accurate to the best of my knowledge and I understand that the quote produced is dependent upon the conditions below as well as this full drawing set.

- Is a load dock available? ☐ YES ☐ NO
- Can facility accept shipment and store until install begins? ☐ YES ☐ NO
- Will a drop trailer be needed? ☐ YES ☐ NO
- Is parking available on site? Is there a fee involved? ☐ YES ☐ NO
- Are there any installation time frame limitations? ☐ YES ☐ NO
- What are they? ☐ YES ☐ NO
- Is a level of infectious control required? ☐ YES ☐ NO
- If YES, then what level ☐ YES ☐ NO

CUSTOMER APPROVAL: \_\_\_\_\_ DATE: \_\_\_\_\_

Legend

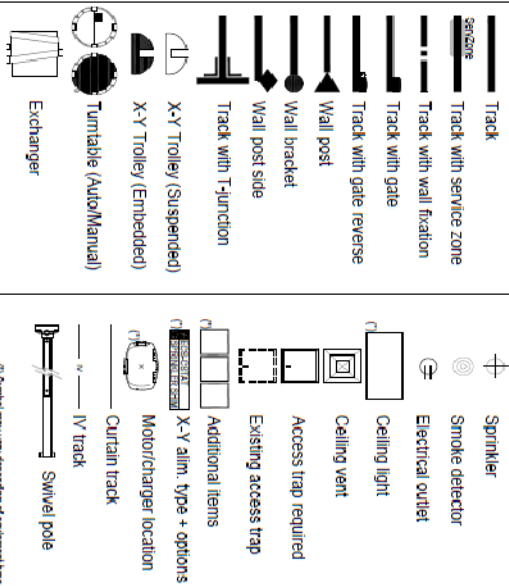

REVISION(S)	DATE(S) (D-M-Y)

INSTALLATION DRAWING

WINNESHIEK  
MEDICAL CENTER

DISTRIBUTOR:  
ARJO

REPRESENTATIVE:  
CHRIS TOREN


DATE (DD-MM-YYYY):  
13-MAR-2024

REFERENCE #:  
QC-03132403


PAGE: 1 / 5

arjo

# WinnMed

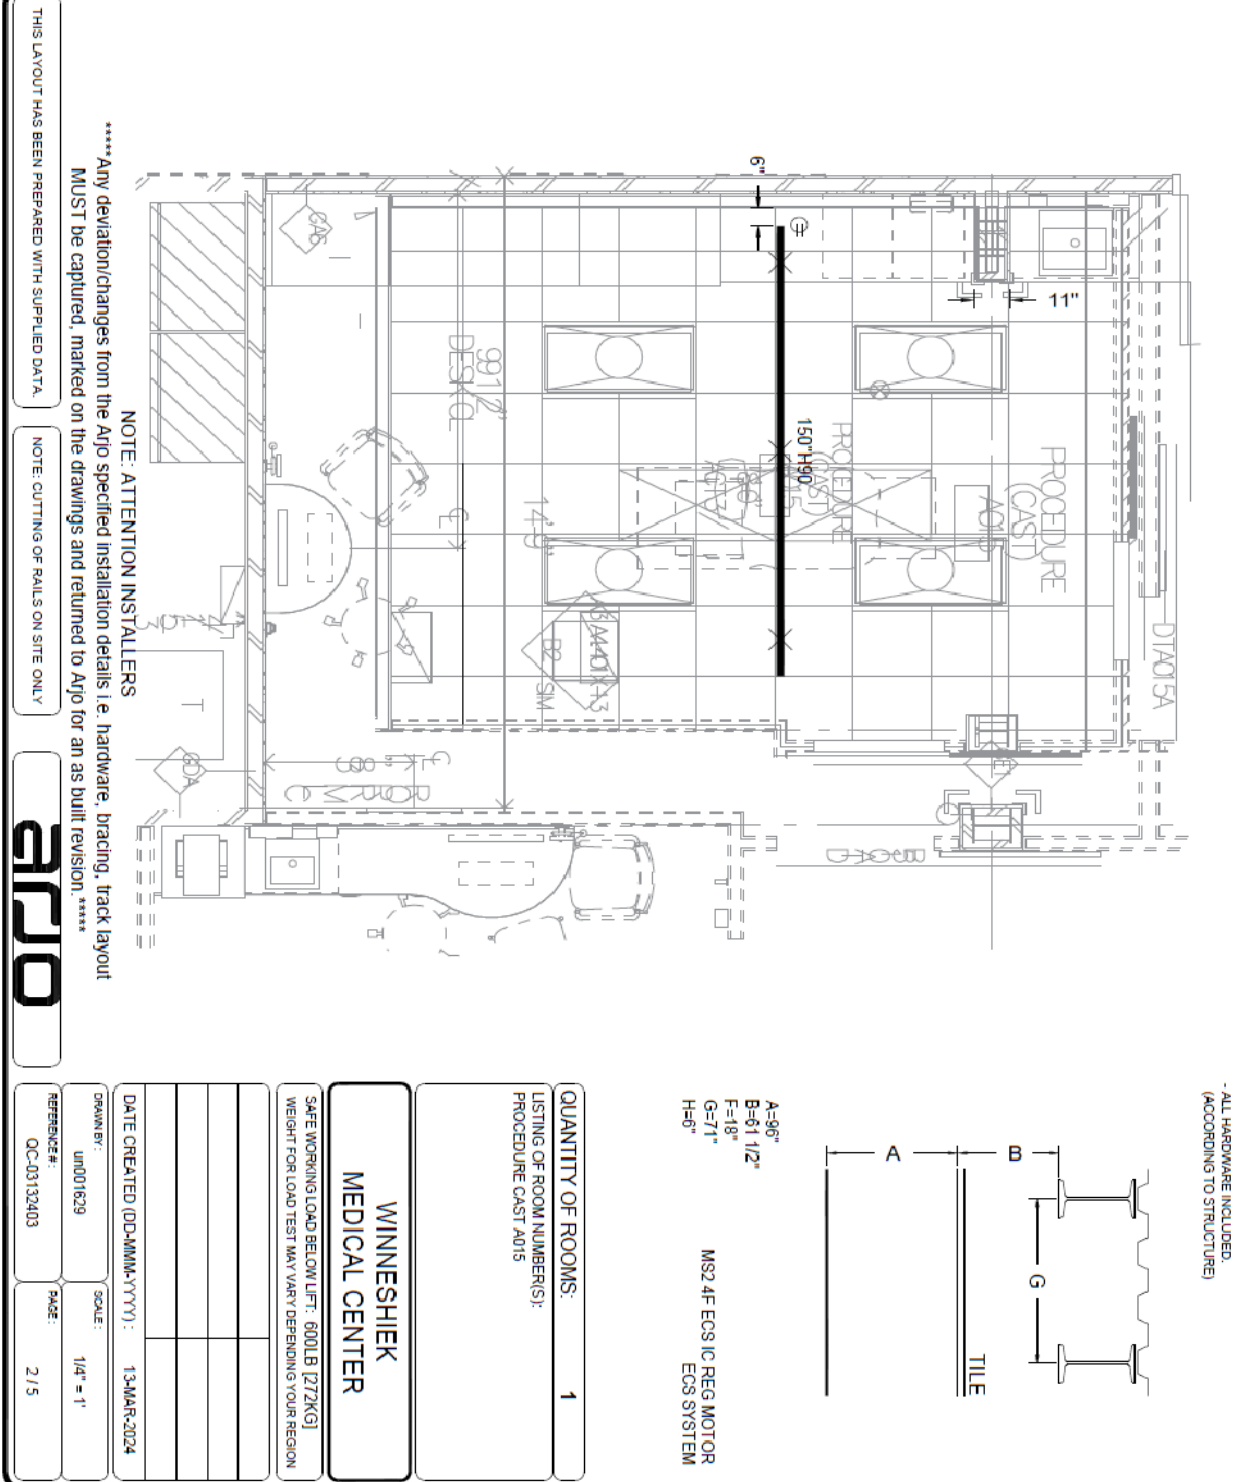

## STANDARD TRACK INSTALLATION M/S2

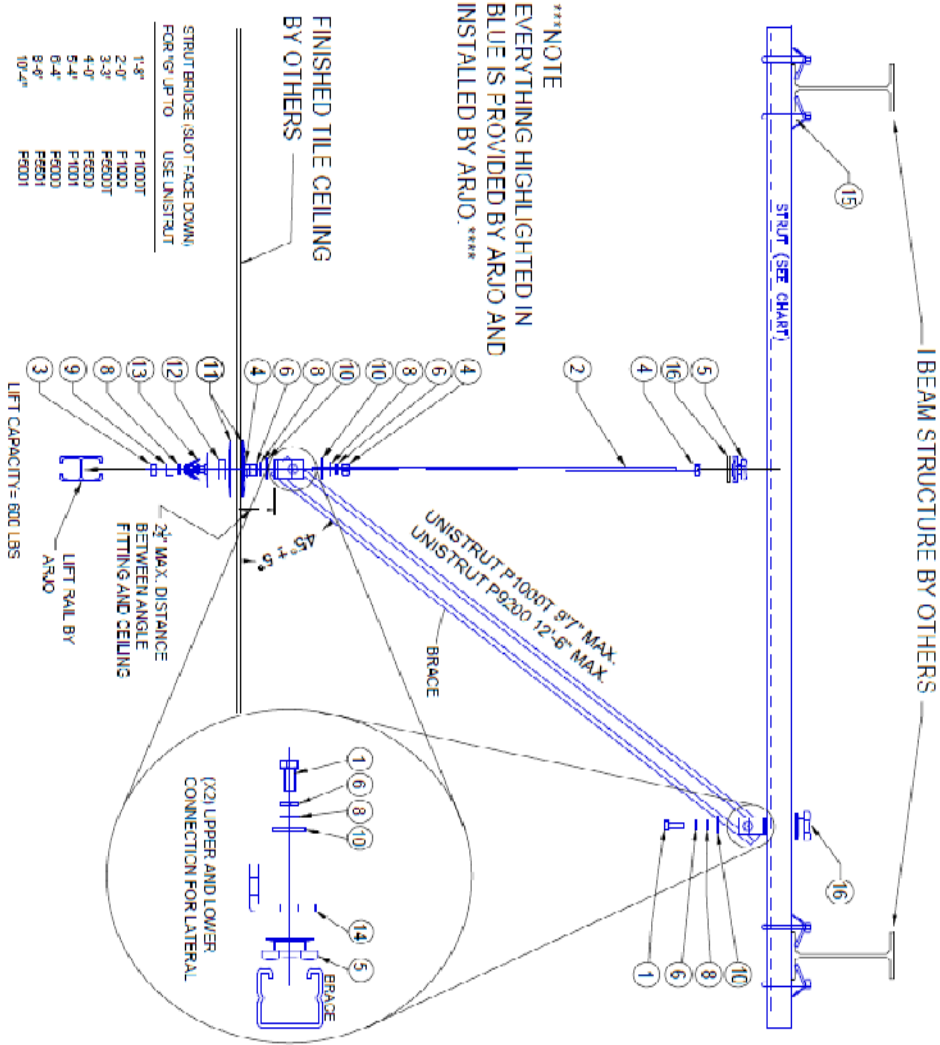

- ALL HARDWARE INCLUDED.  
(ACCORDING TO STRUCTURE)

Item #	Part #	Description	Qty
1	00C 00380	BOLT 3/8" - 16 X 1 1/2"	3
2	00C 00394	THREAD-ROD 3/8" - 16 X 12 ZINC	1
3	00C 00402	LOCKNUT COVER 3/8-16 ZINC	1
4	00C 00405	NUT 3/8-16 ZINC	4
5	UNSP11006	CHANNEL NUT W/ SPRING 3/8-16	4
6	00C 00425	LOCKWASHER 3/8"	5
8	00C 00430	FLAT WASHER M12 ZINC	6
9	00C 00435	TAB WASHER M10	1
10	00C 00475	FLAT WASHER M12	5
11	00C 11140	CEILING PLATE #103MM	2
12	00C 11170	BRACKET SHIM 127mm	1
12	200 11150	BRACKET SHIM 50mm	1
12	200 11150	BRACKET SHIM 15mm	1
13	100 11120	TRACER BRACKET (KINETRAK)	1
14	UNSP1006	UNISTRUT ANGLE	2
15	UNSP201X	UNISTRUT BEAM CLAMP (PEND ON OTHER UTILITY)	4
16	UNSP1045	UNISTRUT SQUARE PLATE	1

WINNESHIEK  
MEDICAL CENTER

SAFE WORKING LOAD BELOW LIFT: 600LB (272KG)





DATE CREATED (DD-MM-YYYY): 13-MAR-2024

SCALE: N/A


REFERENCE: 3 / 5

## LATERAL BRACE REQUIREMENTS REV-3


-ALL HARDWARE INCLUDED  
(ACCORDING TO STRUCTURE)

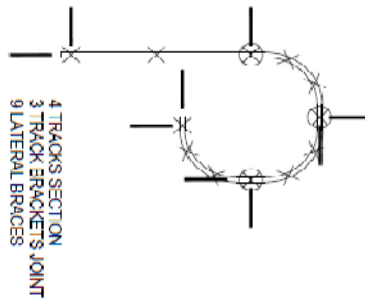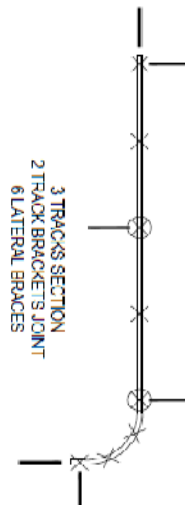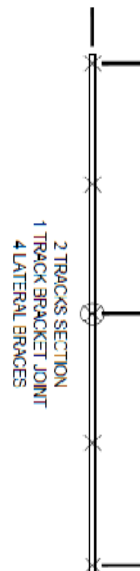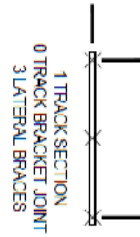


- MINIMUM 3 LATERAL BRACES  
- NUMBER OF LATERAL BRACE = (NUMBER OF TRACK BRACKET JOINT X 2) + 2.

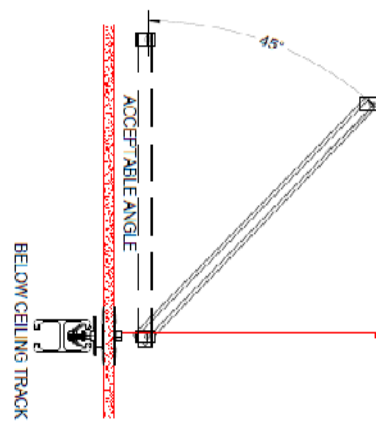

POSSIBLE ANCHOR LATERAL TO THE CEILING OR TO THE WALL

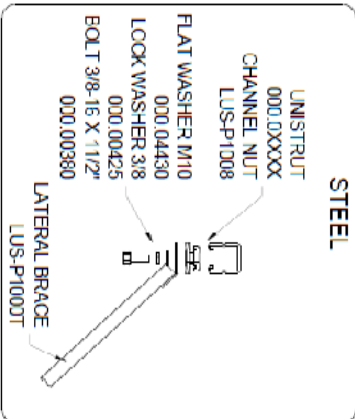

WINNESHIEK MEDICAL CENTER	
SAFE WORKING LOAD BELOW LIFT 600LB [272KG]	
DATE CREATED (DD-MMM-YYYY):	13-MAR-2024
DRAWN BY:	SCALE: N/A
REFERENCE:	PAGE: 4 / 5

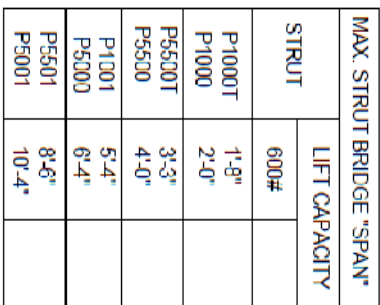

NOTE: ARJO GUARANTEES THE STRUCTURAL INTEGRITY OF THE TOTAL LIFT SYSTEM DESIGN, INCLUDING TRACK, BRACING, HANGERS, AND ALL CONNECTIONS TO THE BUILDING STRUCTURE. OUR DESIGN IS BASED ON THE REQUIREMENTS OF THE CURRENT INTERNATIONAL BUILDING CODE (IBC) AND THE SEISMIC LOADS OF THE REGION. THE FACILITY MUST VERIFY THE ADEQUACY OF THE BUILDING STRUCTURE TO SUPPORT THE LOADS IMPOSED BY THE LIFT SYSTEM."

Item #	Part #	Description	Qty
1	000.00394	THREADED ROD 3/8-16 X 16 ZINC	2
2	000.00405	NUT 3/8-16 ZINC	6
3	LUS-P3006	CHANNEL NUT 3/8	2
4	LUS-P1363	SQUARE PLATE 3/8"	6

DATE CREATED (DD-MMM-YYYY) : 13-MAR-2024	
CRASH BY : UNDO1629	
REFERENCE # : QC-0313241G	
PAGE : 5 / 5	
SAVE WORKING LOAD BELOW LEFT : 600LB [272KG]	
WINNESHIEK MEDICAL CENTER	

# WinnMed

WinnMed

Issue Date:

3/6/2024

Expansion and Renovation

Decorah, IA 52101

Furniture Specifications

CONTACT:

Ben Stevens - CFO

PHONE NUMBER:

563-387-3109

ITEM NUMBER:	71
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ITEM NAME:	BLANK		
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ROOM NUMBER:		QUANTITY:	
--------------	--	-----------	--

SPECIFICATION INFORMATION	
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MANUFACTURER:

MODEL #:

DIMENSIONS:

DESCRIPTION:

FURNITURE & EQUIPMENT IMAGE
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# WinnMed

WinnMed

Issue Date:

3/6/2024

Expansion and Renovation

Decorah, IA 52101

Furniture Specifications

CONTACT:

Ben Stevens - CFO

PHONE NUMBER:

563-387-3109

ITEM NUMBER:	72
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ITEM NAME:	BLANK		
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ROOM NUMBER:		QUANTITY:	
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SPECIFICATION INFORMATION	
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MANUFACTURER:

MODEL #:

DIMENSIONS:

DESCRIPTION:

FURNITURE & EQUIPMENT IMAGE
-----------------------------



# WinnMed

WinnMed

Issue Date:

3/6/2024

Expansion and Renovation

Decorah, IA 52101

Furniture Specifications

CONTACT:

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PHONE NUMBER:

563-387-3109


ITEM NUMBER:	73
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ITEM NAME:	OB Headwall		
ROOM NUMBER:		QUANTITY:	

## SPECIFICATION INFORMATION

MANUFACTURER: AMICO  
MODEL #: NuLook Manifold System  
DIMENSIONS: 111.5" x 88" H x 5" D  
DESCRIPTION: OB Headwall system with Backlit Accent panel, built in electrical (qty 14 emerg. outlets; qty 10 normal power outlets)/data (qty 3 outlets)/medical gas connections (qty 2 O2; qty 2 Med Air; qty 2 Vacuum); bed bumpers

## FURNITURE & EQUIPMENT IMAGE

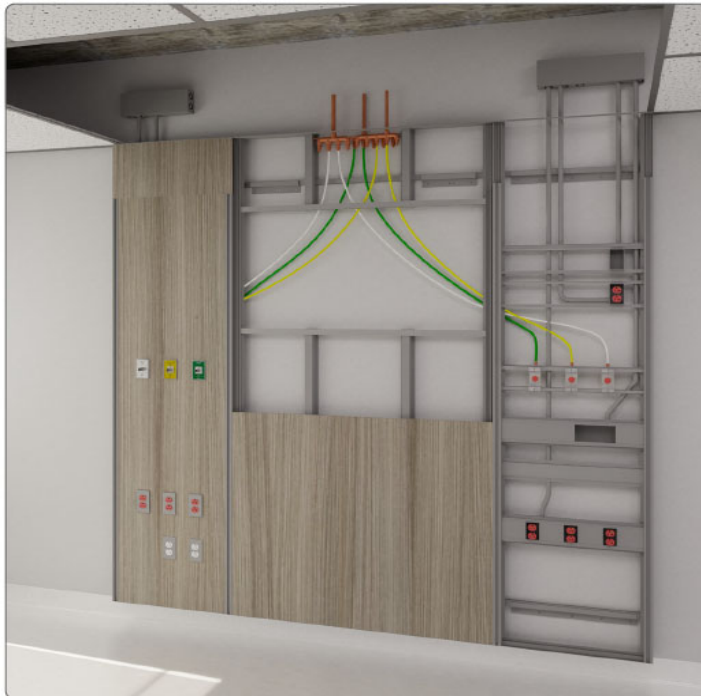


**NULOOK MANIFOLD SURFACE MOUNTED PANEL WALL**  
FULL LENGTH GENERAL CARE  
(M/N: FW1008-NUL-GEN-P)



## Discussion

FOR PRESENTATION  
PURPOSES ONLY  
Mar-21-2024  
NOT FOR  
CONSTRUCTION USE

FOR USUAL PURPOSES ONLY  
ACTUAL NUMBER & LOCATION  
OF TERMINATION BORES,  
ENT CONDUITS & GAS PIPES TO  
BE COMPLETED DURING PRODUCTION  
TESTS DIFFERENCE SPECIFIED

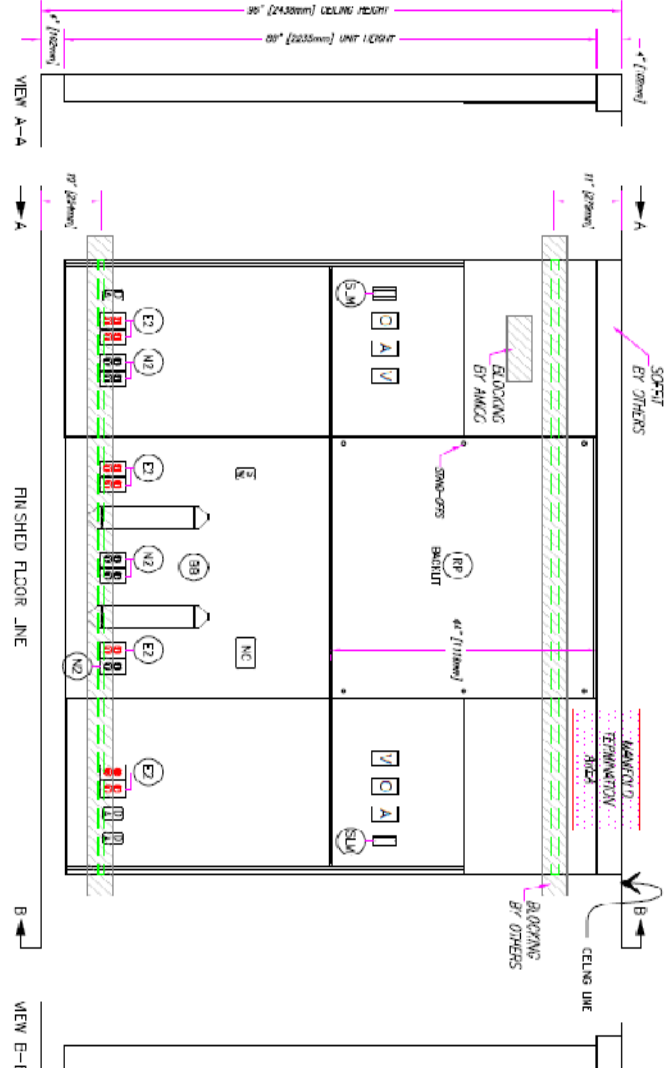

IMPORTANT: PLEASE VERIFY THAT THE ABOVE INFORMATION IS CORRECT, AND PROVIDE THE REMAINING DETAILS.

HOSPITAL	WINNESHIEK MEDICAL CENTER
LOCATION	DECORAH, IA UNIT AS SHOWN - N.T.S.

APPROVAL - PRINT AND SIGNATURE

MODEL CALL	MFG# : TBC	MODEL No. : TBC
Q&S DETAILS	MFG# : AMICO	TYPE CONNECTION : TBC
FINISH	TBC	BLIND HOLE : 8'-0"

DATE \_\_\_\_\_

PHONE NO.

# DRAWING # 01

TYPE	QUANTITY
LD RP	6

IF MIRRORED UNITS ARE REQUIRED,  
THE CUSTOMER MUST INDICATE THE  
QUANTITY BELOW

## SYSTEM DETAILS

S/V	Q/V	DESCRIPTION
P	1	PANEL WALL
D	2	PAINTED GAS OUTLET, OXYGEN
CS	1	GAS MANIFOLD - CYGARD
1		CYD-BL-U-OXY-26XRB-D-SHB-U
A	2	PAINTED GAS OUTLET, MED AIR
1		GAS MANIFOLD - MED AIR
C	1	CYD-B-L-A-R-66XRB-D-SHB-U
V	2	PAINTED GAS OUTLET, VACUUM
1		GAS MANIFOLD - VACUUM
E	7	CYD-B-L-U-AC-40XRB-D-SHB-U
2		RECEPTACLE - D/PLEX-RED
N	5	RECEPTACLE - D/PLEX-RED
1		PROVISION - N/USE CAL. 36
DA	3	PROVISION - DATA 16
SW	2	PROVISION - SWITCH 16
SL	1	VACUUM SLIDE
BP	1	EXHAUST REGN. PANEL - 41.5 Wx41.4 H
BB	1	VERTICAL, BEB SUMMER - PAIR
1		BLOCKING 16 GA

### NOTE

- [illegible]



**4 Imico**  
www.4imico.com

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T4 656 - 637-604-4510  
T4 0022 76-1-2005  
FAX (520) 798-0062

COOCE MR.  
MOORE 348  
REV. BY 12/05-ETLB  
PUBLISHED 7/16/14  
DATE MAR-21-2024  
REV. DATE

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